ATTACHMENTS DISTRIBUTED UNDER SEPARATE COVER

DAC 15/12/2022 – 9 WILLIAM STREET MAYFIELD – DA2022/00532 - DUAL OCCUPANCY - INCLUDING DEMOLITION OF EXISTING STRUCTURES

PAGE 3	ITEM-21	Attachment A:	Submitted Plans
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PAGE 42	ITEM-21	Attachment C:	Processing Chronology

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DAC 15/12/2022 – 9 WILLIAM STREET MAYFIELD – DA2022/00532 - DUAL OCCUPANCY - INCLUDING DEMOLITION OF EXISTING STRUCTURES

ITEM-21 Attachment A: Submitted Plans

WORKING DOCUMENTATION

DWG No. DRAWING TITLE

WD01 **COVER SHEET** WD02 **SURVEY**

WD03 LANDSCAPE PLAN WD04 SITE SETOUT PLAN WD05 **DEMOLITION PLAN** WD06 STORMWATER PLAN SHADOW DIAGRAMS **WD07** WD08 SHADOW DIAGRAMS **COVER SHEET - UNIT 1** WD09

FLOOR PLAN - GROUND FLOOR WD10 **WD11** FLOOR PLAN - FIRST FLOOR

WD12 **ELEVATIONS** WD13 **ELEVATIONS** WD14 **SECTIONS**

WD15 COVER SHEET - UNIT 2

WD16 FLOOR PLAN

WD17 FLOOR PLAN - FIRST FLOOR

WD18 **ELEVATIONS** WD19 **ELEVATIONS**



9 William Street Mayfield SUMMARY OF BASIX COMMITMENTS FOR EACH UNIT This is a summary of the BASIX Commitments as detailed in the BASIX Certificate. Refer to the CURRENT BASIX Certificate for Complete details. For definitions refer to basix.nsw.gov.au WATER COMMITMENTS Fixtures 3 Star Shower Heads Yes 3 Star Kitchen / Basin Taps Yes 3 Star Toilet Yes **Alternative Water** Minimum Tank Size (L) 1500 Collected from Roof Area (m2) Tank Connected To: All Toilets Laundry W/M Cold Tap Yes One Outdoor Tap Yes THERMAL COMFORT COMMITMENTS - Refer to TPA Specification on plan **ENERGY COMMITMENTS** Gas Instantaneous 6 Star Hot Water Living EER 3.0 - 3.5 Cooling 1 Phase A/C Zoned System Bedrooms 1 Phase A/C Zoned EER 3.0 - 3.5 Heating Living 1 Phase A/C Zoned EER 3.0 - 3.5 System Bedrooms 1 Phase A/C Zoned EER 3.0 - 3.5 1 x Bathroom Fan ducted to exterior Manual on/off Ventilation Kitchen Natural ventilation N/A Laundry Natural ventilation N/A Window/Skylight in Kitchen As drawn Natural Lighting Window/Skylight in Bathrooms/Toilets As drawn Number of bedrooms Dedicated Yes Artificial Lighting Number of Living/Dining rooms All Dedicated Yes (rooms to be Kitchen Yes Dedicated Yes primarily lit by All Bathrms/Toilets Yes Dedicated Yes fluorescent or Laundry Yes Dedicated Yes LED lights) All Hallways Yes Dedicated Yes OTHER COMMITMENTS Outdoor clothes line Yes Ventilated refrigerator space

Gas cooktop & electric oven

Alternative Energy | Photovoltaic System: 0.4kw to U1 only

		ity Assessments sustainability.net.au	www	. buildingsustain)2) 4962 343 ability.net.a
		Important	Note		-
the Assessor C Assessor and N	Certificate NatHERS	ion was used to achievo e. If the proposed const certificates will no long	ruction varie jer be valid.	s to those detailed to Assessments assu	nelow than the me that the
,		ding sealing & ventilation	,		
		e BCA variations must be in accordance with Vol			
- Thermal brea - Floor insulation	ks for Cla	ass 1 dwellings in accor ass 1 dwellings as per F cordance with Section J	rdance with Part 3.12.1.5	Part 3.12.1.2(c) & 3. (a)(ii), (iii) & (e) or (c	12.1.4(d)
		rformance Specificati	ons (does i	not apply to garage)
External Wall	Constru	ıction		Add	ded Insulation
AAC 75mm V	eneer &	Lightweight			R2.0
Ceiling Const	ruction		R3 5		
Plasterboard		Colour (Solar Absorn		to ceilings adjacent	
		Colour (Solar Absorp		to ceilings adjacent	
Plasterboard Roof Constru	ction	Any	tance)	to ceilings adjacent Add	to roof space ded Insulation Foil
Plasterboard Roof Construct Metal Floor Construct	ction	<u> </u>	tance)	to ceilings adjacent Add	to roof space ded Insulation
Plasterboard Roof Construct Metal Floor Construct	ction	Any Covering (if not noted	tance)	to ceilings adjacent Add	to roof space ded Insulation Foil ded Insulation None
Plasterboard Roof Construct Metal Floor Construct Concrete (175n Timber	ction action mm waffle	Any Covering (if not noted e pod) As drawn	tance)	to ceilings adjacent Add	to roof space ded Insulation Foil ded Insulation
Plasterboard Roof Construct Metal Floor Construct Concrete (175n Timber	ction uction mm wafflo	Any Covering (if not noted e pod) As drawn As drawn	tance) I default valu U value	to ceilings adjacent Add ues used) Add	to roof space ded Insulation Foil ded Insulatior None None
Plasterboard Roof Construct Metal Floor Construct Concrete (175n Timber Windows	ction Iction mm waffle Glass an Alumir	Any Covering (if not noted e pod) As drawn As drawn d frame type	tance) I default valu U value Ir 6.70	to ceilings adjacent Add ues used) Add SHGC Range	to roof space ded Insulation Foil ded Insulation None None

BSA Reference: 18082

BASIX REQUIREMENTS

August 2022



Mine Subsidence Acid Sulphate Soil Yes/No Class 2 Acoustic Requirements Yes Mains Water Available: Yes Mains Sewer Available: Stormwater Drainag Kerb/Pit >1km to Breaking Surf: >100m to Salt Water No Flood Min RL: No Bushfire Requirements:

Wind Classification:

N2

Soil Classification

H1

WD01₃₂₀

COVER SHEET

0009WILL

12/10/2022

CONTRACT

PLANS

Custom DETATCHED DUAL OCCUPANCY

WITH Custom FACADE

Mahdi Ashuri

63 / B / 192768

9 WILLIAM STREET

MAYFIELD,

NSW, 2304

No ITH HEART

11 Hank Street, Heatherbrae, NSW, 2324

Websile: www.hunterhomesnsw.com

Bensile: inde@punterhomesnsw.com

Phone: (02) 4987 4909

ABN: 76 133 887 064

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No. | DETAIL | 1. KD | PLANS ISSUED FOR APPROVAL 2. MI DESIGN CHANGES ISSUED FOR REVIEW AND COMMENT 3. MI BASIX COMMITMENTS ADDED

Type B windows are double hung windows, sliding windows & doors, fixed windows, stacker doors, louvres Skylights Glass and frame type U SHGC Area sq m U and SHGC values are according to AFRC. Alternate products may be used if the U value is lower & the SHGC is within the range specified Shade elements (eaves, verandahs, awnings etc. All shade elements modelled as drawn **Ceiling Penetrations** (downlights, exhaust fans, flues etc) Modelled as drawn and/or to comply with the ventilation and sealing requirements of the BCA Ducting is modelled at 150mm. No insulation losses from downlighting have been modelled. Additional Notes

Stove/Oven

TOWN PLANNER AMENDMENTS 5. MI COUNCIL RFI AMENDMENTS, DWELLINGS ATTACHED B. MI UPDATED BASIX BLOCKS ADDED 7. MI MINOR SETBACK ADJUSTMENTS + GFA CALC UPDATE

LEGEND

STREET TREE

TELSTRA PILLAR

ONBN NBN PIT


TELSTRA PIT

 \square **ELECTRICITY PILLAR**

- THE REGISTRAR GENERAL. THE BOUNDARIES SHOWN IN THE SKETCH HEREON REPRESENT OUR INTERPRETATION OF THEIR POSITION AND CAN BE CHALLENGED BY ANOTHER SURVEYOR OR ALTERED IF A PLAN OF SURVEY WAS PREPARED FOR ONE OF THE NEIGHBOURING LOTS THEN REGISTERED BY NSW LAND REGISTRY SERVICES. THE PREPARATION OF A PLAN OF REDEFINITION FOR THE LAND THEN ITS LODGMENT WITH, AND REGISTRATION BY, NSW LAND REGISTRY SERVICES WOULD CONFIRM THE BOUNDARIES AND EXTINGUISH THE "LIMITED TITLE" NOTATION.)
- **CONTOUR PLAN**

17 William Street HAMILTON NSW 2303 PO Box 986 HAMILTON NSW 2303 Ph: 4969 6995 www.parkerscanlon.com.au Email: surveys@parkerscanlon.com.au ABN 36124 624 022

No. Trunk Spread Height 1 0.5mø 9mø 4m		Table of	Tree Da	ta
1 0.5mø 9mø 4m	No.	Trunk	Spread	Height
	1	0.5mø	9mø	4m

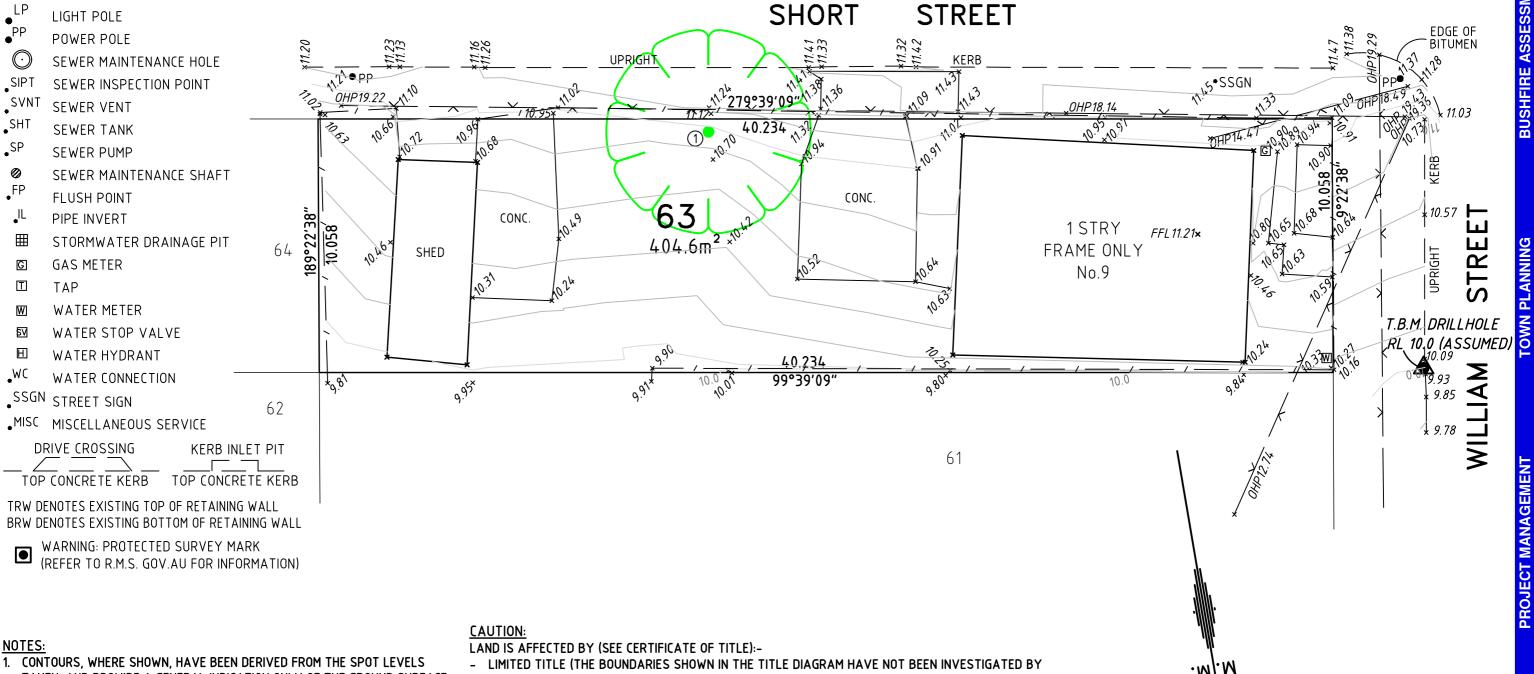

YES*

YES*

GAS MAIN

WATER MAIN

* AS PER "DIAL BEFORE YOU DIG"

SEARCH DATED 25/08/2021

TAKEN, AND PROVIDE A GENERAL INDICATION ONLY OF THE GROUND SURFACE.

2. CONTOUR INTERVALS ARE 0.2 METRES.

3. ONLY VISIBLE SERVICES HAVE BEEN LOCATED.

4. IT IS RECOMMENDED THE POSITION AND DEPTHS OF ALL SERVICES BE INVESTIGATED. A "DIAL BEFORE YOU DIG" SEARCH SHOULD BE UNDERTAKEN.

5. THIS DOCUMENT IS FOR PLANNING PURPOSES ONLY.

6. ONLY SIGNIFICANT TREES LOCATED AT TIME OF SURVEY.

PLAN TITLE: REV DETAILS & AMENDMENTS A INITIAL PLAN 2/09/2021 9 WILLIAM STREET, MAYFIELD HUNTER HOMES SECTION: _{L0Т:} DP: 192768 CLIENT REFERENCE: 0009WILL - P0.2134 PARKER SCANLON CONTACT:

JOEL SHEARER SURVEYED/DRAWN/CHECKED: TM/PC/JH ASSUMED REF No: 14962CON-A SHEET 1 OF 1 Α3 TBM DRILLHOLE RL10.0

WIND CLASSIFICATION

BREAKING SALT WATER NO

WITHIN 1 KM. OF

WITHIN 100 M. OF

SALT WATER

N1

NO

PARKER SCANLON

SCALE 1:150

EDGE OF

RL 11.000

CUT 345

LANDSCAPING SCHEDULE



LANDSCAPE PLAN


RL 11.105

CUT 75

RL 10.955

FILL 75

RL 10.955

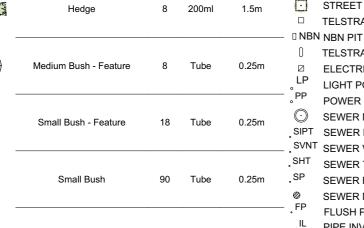




SITE 404.67

TOTAL VERTICAL LANDSCAPE

95.93m² 140.03m² LANDSCAPE PERCENTAGE 34.6%

44.10m²

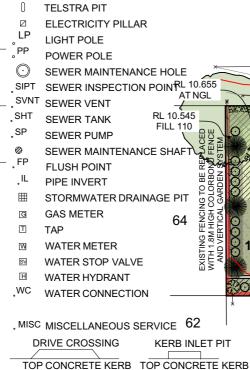

TRW DENOTES EXISTING TOP OF RETAINING WALL BRW DENOTES EXISTING BOTTOM OF RETAINING WALL

STREET TREE

TELSTRA PILLAR

AT NGL RL 10.545 FILL 110 KERB INLET PIT

DWELLING 2 P.OS 16.00 m² 19m X 1.8h VERTICAL GARDEN 34.2m2 LANDSCAPED AREA

RL 10.875

RL 10.920

FILL 110

RL 10.900

CUT 245

10.655 2 AT NGL * CUT DWELLING ALL **P.O.S** 16.01 m² EXISTING FENCING TO BE REPLACED WITH 1.8M HIGH COLO RL/10.310 FILt 345 5.5m X 1.8h VERTICAL GARDEN 9.9m2 LANDSCAPED AREA

PROPOSED 1.2m HIGH PICKET FENCING

_ - LANSCAPED AREA







0

MULCHED GARDEN BED



- GRAVEL

CONTRACT PLANS

For the design of a:

Custom DETATCHED DUAL OCCUPANCY WITH Custom FACADE

Mahdi Ashuri 63 / B / 192768 9 WILLIAM STREET MAYFIELD, NSW, 2304

Wind Classification Mains Water Available: >1km to Breaking Surf: N2 Yes Yes No Soil Classification: Stormwater Drainag Mains Gas Available: >100m to Salt Water H1 Kerb/Pit Yes No Mine Subsidence: Acid Sulphate Soil: Mains Sewer Available: Acoustic Requirements Yes/No Class 2 Yes No

Bushfire Requirements: No Flood Requirements: No Rock (Approx. Depth): Yes/No

No. DETAIL

1. KD PLANS ISSUED FOR APPROVAL

2. MI DESIGN CHANGES ISSUED FOR REVIEW AND COMMENT

3. MI BASIX COMMITMENTS ADDED

4. JL TOWN PLANNER AMENDMENTS

5. MI COUNCIL RFI AMENDMENTS, DWELLINGS ATTACHED

6. MI UPDATED BASIX BLOCKS ADDED

7. MI MINOR SETBACK ADJUSTMENTS + GFA CALC UPDATE

8. MI SHADOW DIAGRAMS UPDATE

Hunter Homes Ptv Ltd 11 Hank Street, Heatherbrae NSW, 2324 Website: www.hunterhomesnsw.com Phone: (02) 4987 4909 ABN: 76 133 887 064
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live WITH HEART On:

WD03₀20 LANDSCAPE PLAN

0009WILL

12/10/2022

SITE SETOUT PLAN

0009WILL

12/10/2022 CONTRACT **PLANS**

Custom DETATCHED DUAL OCCUPANCY WITH Custom FACADE

Mahdi Ashuri

63 / B / 192768 9 WILLIAM STREET MAYFIELD. NSW, 2304

CUT FILL SPLIT

32.77

404.67

Soil Classification

H1

Acid Sulphate Soil

Class 2

Mains Power

Yes

Yes

Stormwater Drainag

Kerb/Pit

No

Flood Min RL:

No

>100m to Salt Water

Cubic Meters	14.62	72.89	-58.27
Tonne	32.12	160.36	-128.19
12t Trucks	2.68	13.35	-10.67

SITE COVERAGE

UNIT 1 GARAGE GROUND FLOOR

SITE

68.64 PORCH 6.03 107.44 m² UNIT 2 ALFRESCO 7.26 GARAGE 36.22 **GROUND FLOOR** 77.73 4.54 125.75 m² 233.19 m²

DRIVEWAY CROSSING - NEWCASTLE CONCRETE 100mm THICK REINFORCED WITH SL72 FABRIC IN TOP 40mm COVER GARAGERL 11.195 500 / 1,413 / 1,200 / 650 558 855 1,200

No. | DETAIL | 1. KD | PLANS ISSUED FOR APPROVAL

TOWN PLANNER AMENDMENTS 5. MI COUNCIL RFI AMENDMENTS, DWELLINGS ATTACHED 6. MI UPDATED BASIX BLOCKS ADDED 7. MI MINOR SETBACK ADJUSTMENTS + GFA CALC UPDATE

2. MI DESIGN CHANGES ISSUED FOR REVIEW AND COMMENT BASIX COMMITMENTS ADDED

DRIVEWAY GRADIENT - UNIT 1

SCALE 1:100 @A3

- CUT BATTER (1:4 UNLESS NOTED OTHERWISE - FILL BATTER (1:4 UNLESS NOTED OTHERWISE



Wind Classification

N2

Mine Subsidence

Yes/No

Acoustic Requirements

No

Mains Water Available

Yes

Mains Sewer Available:

Yes

>1km to Breaking Surf:

No


Yes/No

Bushfire Requirements:

No

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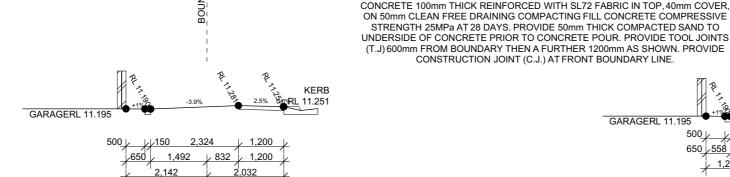
GROSS FLOOR AREAS

CONDITIONED 109.67 UNCONDITIONED 8 19 117.86 m² UNIT 2 CONDITIONED 111.73 UNCONDITIONED 8 41 120.14 m² 238.00 m² SITE 404.67

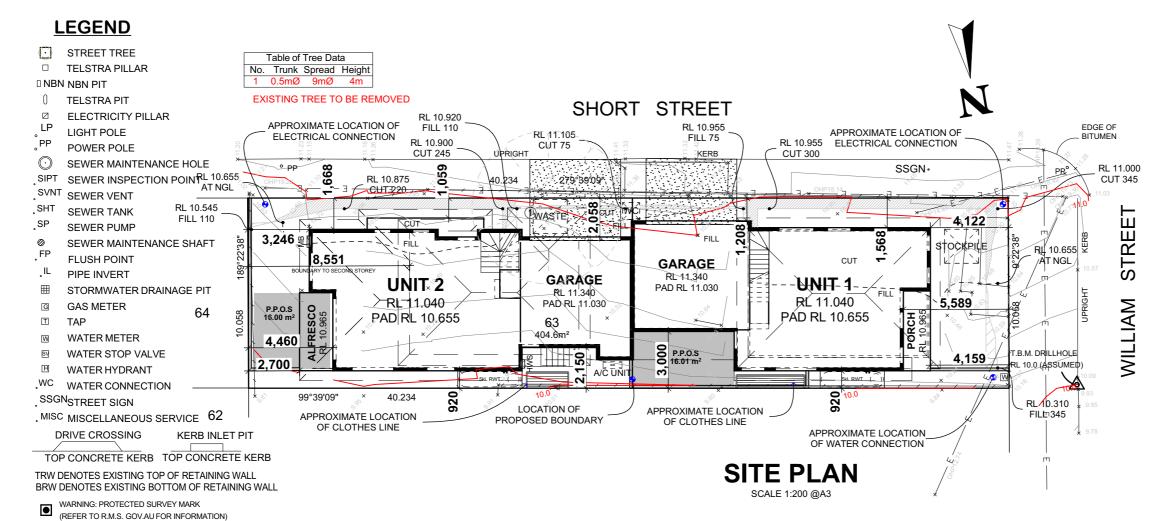- ALL BATTERS SHOWN ARE 1V:4H UNLESS NOTED OTHERWISE
- CONTOURS SHOWN ARE BASED ON COMPUTER INTERPRETATION OF POINT LEVELS, CARE SHOULD BE TAKEN IF EXTRAPOLATING
- SERVICES LOCATED HEREIN ARE APROXIMATE ONLY AND TAKEN RMATION AVAILABLE AT THE TIME OF D CONSULT DIAL BEFORE YOU DIG TO ESTABLISH EXACT DETAILS AT THE COMMENCEMENT OF WORKS
- ALL EROSION AND SEDIMENTATION CONTROLS ARE TO BE WITHIN THE ALLOTMENT BOUNDARIES
- ALL EROSION AND SEDIMENTATION CONTROLS ARE TO BE INSPECTED AND MAINTAINED BY SITE SUPERVISOR REGULARLY AND CLEANED UPON REACHING 50% CAPACITY. FOOTWAYS, DRIVEWAYS AND ROADS SHOULD BE TREATED SIMLIARLY








DRIVEWAY GRADIENT - UNIT 2

LEGEND

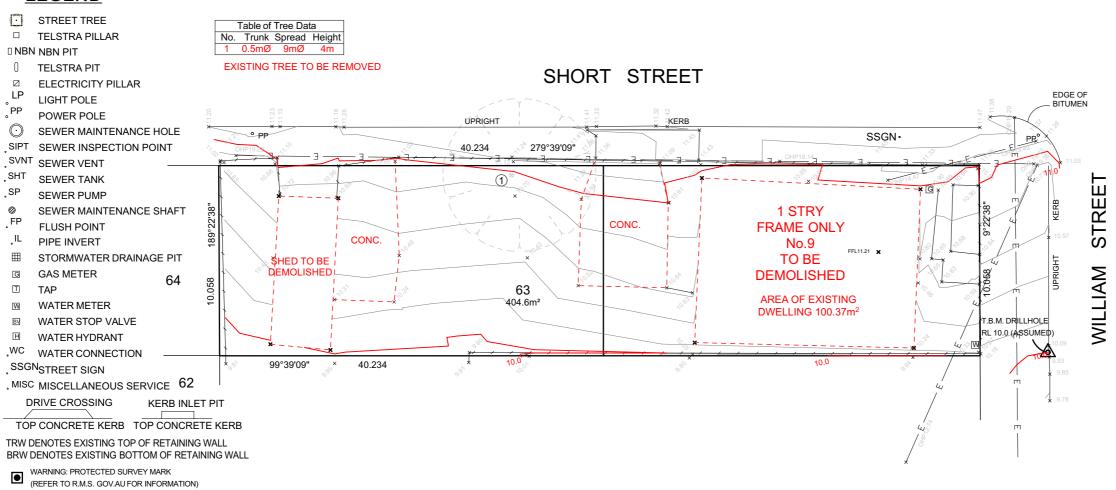

DEMOLITION PLAN

SCALE 1:200 @A0

WD05₃20

DEMOLITION PLAN

0009WILL

12/10/2022 **CONTRACT PLANS**

For the design of a:

Custom DETATCHED DUAL OCCUPANCY WITH Custom FACADE

Mahdi Ashuri

63 / B / 192768 9 WILLIAM STREET MAYFIELD, NSW, 2304

N2 H1 Acid Sulphate Soil: Mine Subsidence Yes/No Class 2 Acoustic Requirements: Mains Power: No Yes Mains Water Available: Yes Yes Mains Sewer Available: Stormwater Drainage Yes Kerb/Pit >1km to Breaking Surf: >100m to Salt Water: No No Flood Min RL: Yes/No No Bushfire Requirements:

Soil Classification

Wind Classification:

No



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No. DETAIL


1. KD PLANS ISSUED FOR APPROVAL

2. MI DESIGN CHANGES ISSUED FOR REVIEW AND COMMENT

3. MI BASIX COMMITMENTS ADDED

4. JL TOWN PLANNER AMENDMENTS

MI COUNCIL RFI AMENDMENTS, DWELLINGS ATTACHED
 MI MI UPDATED BASIX BLOCKS ADDED
 MI MINOS SETBACK ADJUSTMENTS + GFACALC UPDATE
 SHADOW DIAGRAMS UPDATE

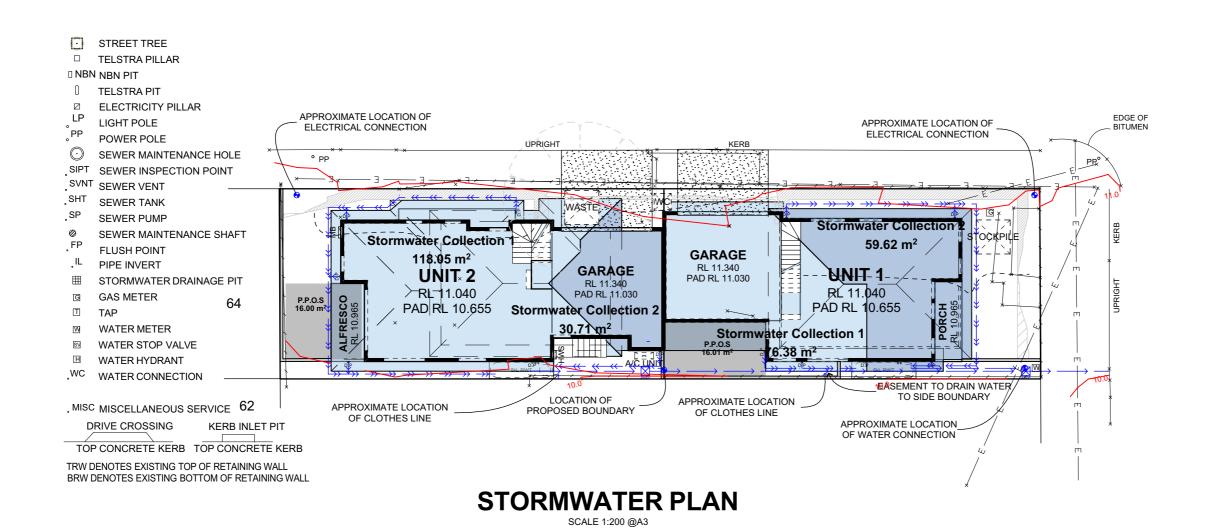

WD06,20

STORMWATER PLAN

0009WILL

12/10/2022 **CONTRACT PLANS**

Custom DETATCHED DUAL OCCUPANCY WITH Custom FACADE

Mahdi Ashuri

63 / B / 192768 9 WILLIAM STREET MAYFIELD, NSW, 2304

Wind Classification N2 H1 Mine Subsidence Acid Sulphate Soil Yes/No Class 2 Acoustic Requirements Mains Power: No Yes Mains Water Available: Yes Yes Mains Sewer Available: Stormwater Drainage Yes Kerb/Pit >1km to Breaking Surf: >100m to Salt Water No No Flood Min RL: Yes/No No Bushfire Requirements:

No



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No. DETAIL

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4. JL TOWN PLANNER AMENDMENTS


5. MI COUNCIL RFI AMENDMENTS, DWELLINGS ATTACHED


MI UPDATED BASIX BLOCKS ADDED
 MINOR SETBACK ADJUSTMENTS + GFA CALC UPDATE
 MI SHADOW DIAGRAMS UPDATE


■ ALL BATTERS SHOWN ARE 1V:4H UNLESS NOTED OTHERWISE

- CONTOURS SHOWN ARE BASED ON COMPUTER INTERPRETATION OF POINT LEVELS, CARE SHOULD BE TAKEN IF EXTRAPOLATING
- SERVICES LOCATED HEREIN ARE APROXIMATE ONLY AND TAKEN FROM INFORMATION AVAILABLEAT THE TIME OF DRAFTING. CONSULT DIAL BEFORE YOU DIG TO ESTABLISH EXACT DETAILS AT THE COMMENCEMENT OF WORKS
- ALL EROSION AND SEDIMENTATION CONTROLS ARE TO BE WITHIN THE ALLOTMENT BOUNDARIES
- ALL EROSION AND SEDIMENTATION CONTROLS ARE TO BE INSPECTED AND MAINTAINED BY SITE SUPERVISOR REGULARLY AND CLEANED UPON REACHING 50% CAPACITY. FOOTWAYS, DRIVEWAYS AND ROADS SHOULD BE TREATED SIMILIARLY
- ALL STORMWATER MUST BE CONNECTED TO LEGAL POINT OF DISCHARGE AS SOON AS PRACTICAL DURING CONSTRUCITON



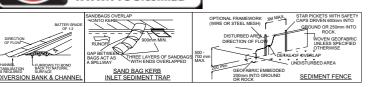

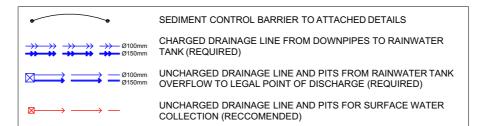

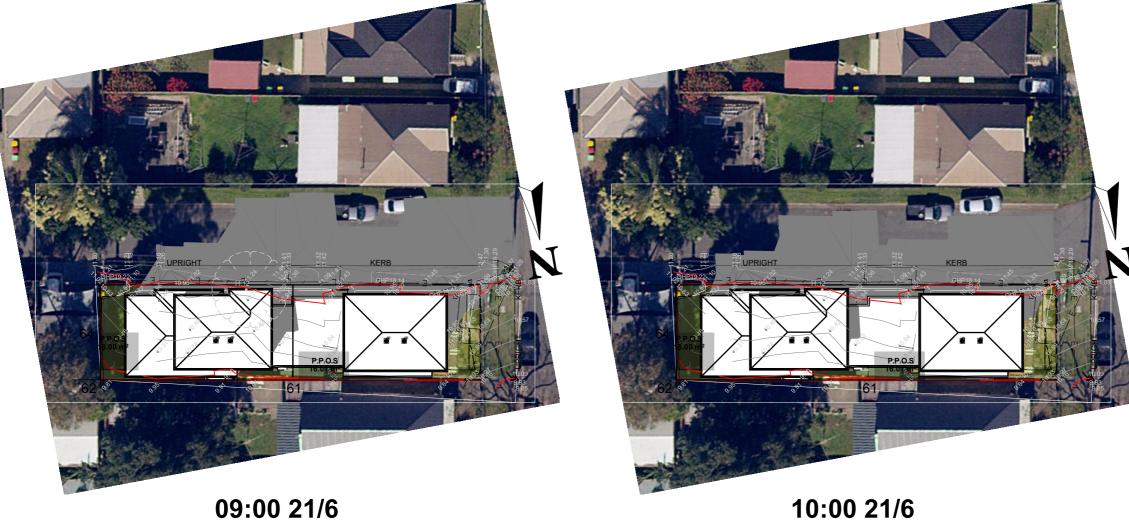

09:00 21/6 NOT TO SCALE

NOT TO SCALE

12:00 21/6 NOT TO SCALE

11:00 21/6

NOT TO SCALE

WD07⁴ of 20

SHADOW DIAGRAMS

0009WILL

12/10/2022 **CONTRACT PLANS**

For the design of a:

Custom DETATCHED DUAL OCCUPANCY
WITH Custom FACADE

Mahdi Ashuri

63 / B / 192768 9 WILLIAM STREET MAYFIELD, NSW, 2304

Wind Classification: N2 H1 Mine Subsidence: Acid Sulphate Soil: Yes/No Class 2 Acoustic Requirements: Mains Power: No Yes Mains Water Available: Yes Yes Mains Sewer Available: Stormwater Drainage Yes Kerb/Pit >1km to Breaking Surf: >100m to Salt Water: No No Flood Min RL: Yes/No No Bushfire Requirements:



Hunter Homes Pty Ltd

11 Hank Street, Heatherbrae, NSW, 2324
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No. | DETAIL

1. KD | PLANS ISSUED FOR APPROVAL

2. MI | DESIGN CHANGES ISSUED FOR REVIEW AND COMMENT

3. MI | BASIX COMMITMENTS ADDED

4. JL | TOWN PLANNER AMENDMENTS

5. MI | COUNCIL RF1 AMENDMENTS, DWELLINGS ATTACHED


6. MI | UPDATED BASIX BLOCKS ADDED

7. MI | MINOR SETBACK ADJUSTMENTS + GFA CALC UPDATE

8. MI | SHADOW DIAGRAMS UPDATE



14:00 21/6 NOT TO SCALE

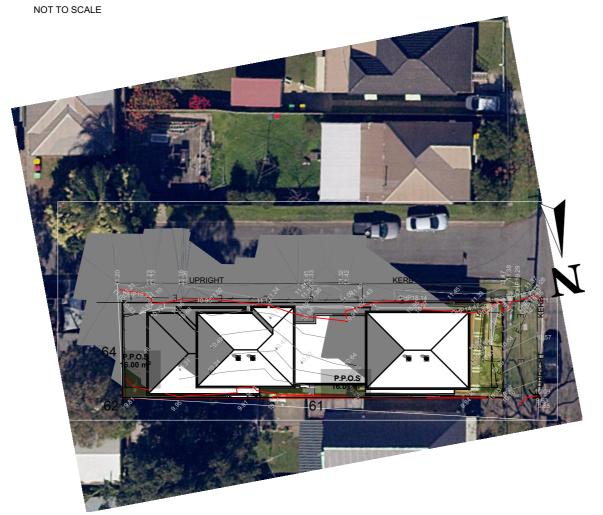

15:00 21/6

NOT TO SCALE

WD08°,20

SHADOW DIAGRAMS

0009WILL

12/10/2022 **CONTRACT PLANS**

For the design of a:

Custom DETATCHED DUAL OCCUPANCY

WITH Custom FACADE

Mahdi Ashuri

63 / B / 192768 9 WILLIAM STREET MAYFIELD, NSW, 2304

N2	H1
Mine Subsidence:	Acid Sulphate Soil:
Yes/No	Class 2
Acoustic Requirements:	Mains Power:
No	Yes
Mains Water Available:	Mains Gas Available:
Yes	Yes
Mains Sewer Available:	Stormwater Drainage:
Yes	Kerb/Pit
>1km to Breaking Surf:	>100m to Salt Water:
No	No
Rock:	Flood Min RL:
Yes/No	No
Bushfire Red	quirements:

Wind Classification: Soil Classification:

No. DETAIL

1. KD PLANS ISSUED FOR APPROVAL

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WITH HEART 父

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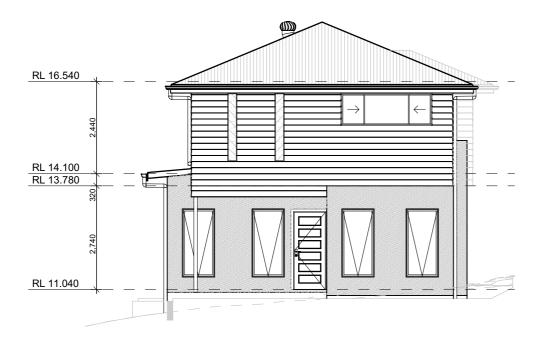
WORKING DOCUMENTATION

DWG No. DRAWING TITLE

WD08	COVER SHEET - UNIT 1
WD09	FLOOR PLAN - GROUND FLOOR


WD10 FLOOR PLAN - FIRST FLOOR

WD11 **ELEVATIONS ELEVATIONS** WD12 WD13 **SECTION A-A**



FRONT ELEVATION

SCALE 1:100 @A0

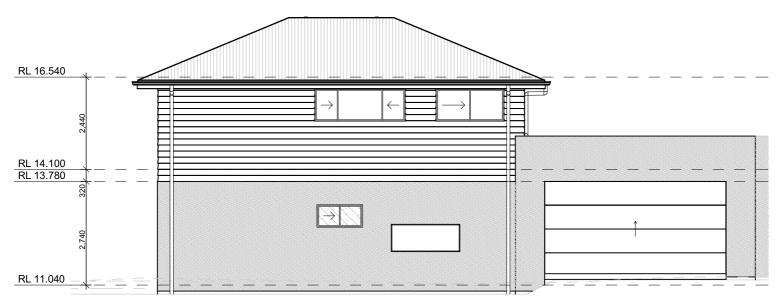

RIGHT ELEVATION

WD09,20

COVER SHEET - UNIT 1

0009WILL

12/10/2022 **CONTRACT PLANS**

For the design of a:

Custom DETATCHED DUAL OCCUPANCY WITH Custom FACADE

Mahdi Ashuri

63 / B / 192768 9 WILLIAM STREET

MAYFIELD, NSW, 2304

N2 H1 Acid Sulphate Soil: Mine Subsidence: Yes/No Class 2 Acoustic Requirements: Mains Power: No Yes Mains Water Available: Yes Yes Mains Sewer Available: Stormwater Drainage Yes Kerb/Pit >1km to Breaking Surf: >100m to Salt Water: No No Flood Min RL: Yes/No No Bushfire Requirements:

Soil Classification:



Wind Classification:

WITH HEART 🎔

No. DETAIL

1. KD PLANS ISSUED FOR APPROVAL

2. MI DESIGN CHANGES ISSUED FOR REVIEW AND COMMENT

3. MI BASIX COMMITMENTS ADDED

4. JL TOWN PLANNER AMENDMENTS

5. MI COUNCIL RFI AMENDMENTS, DWELLINGS ATTACHED


6. MI UPDATED BASIX BLOCKS ADDED

7. MI MINOR SETBACK ADJUSTMENTS + GFA CALC UPDATE

8. MI SHADOW DIAGRAMS UPDATE

DATE 18/01/2022 09/05/2022 16/05/2022 18/05/2022 16/08/2022 17/08/2022

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WD10 of 20

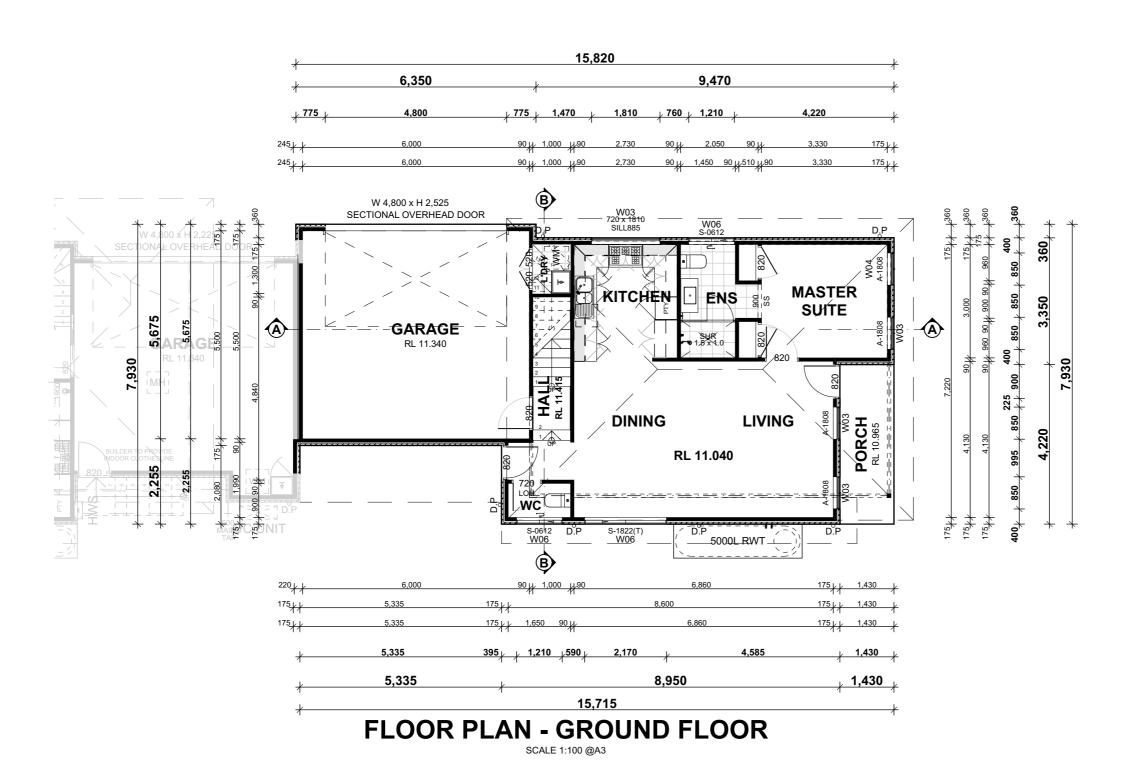FLOOR PLAN - GROUND FLOOR

0009WILL

12/10/2022 **CONTRACT PLANS**

Custom DETATCHED DUAL OCCUPANCY WITH Custom FACADE

Mahdi Ashuri

63 / B / 192768 9 WILLIAM STREET MAYFIELD, NSW, 2304

BASIX AREAS

UNIT 1

Conditioned Unconditioned 109.67 8.19 117.86 m²

FLOOR AREAS

UNIT 1

GROUND FLOOR FIRST FLOOR GARAGE

64.82 32.77 6.03 172.26 m²

68.64

ROOF DETAILS

CUSTOM ORB ROOF SHE... CUSTOM ORB ROOF SHE... Roof Type 22.5° Pitch 5.0° Flat Area 55.31 85.69 92.75 Pitched Area 55 52

> Wind Classification: N2 H1 Acid Sulphate Soil Mine Subsidence Yes/No Class 2 Acoustic Requirements Mains Power: No Yes Yes Yes Mains Sewer Available: Stormwater Drainage Yes Kerb/Pit >1km to Breaking Surf: >100m to Salt Water No No Flood Min RL: Yes/No No

> > Bushfire Requirements: No



No. DETAIL

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4. JL TOWN PLANNER AMENDMENTS

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 MI UPDATED BASIX BLOCKS ADDED
 MI INFORMETTS + GFA CALC UPDATE
 SHADOW DIAGRAMS UPDATE

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uction. All plans are to be read in conjunction with

FLOOR PLAN - FIRST FLOOR

SCALE 1:100 @A3

9,560

WD11_{15 of} 20

FLOOR PLAN - FIRST FLOOR

0009WILL

12/10/2022 **CONTRACT PLANS**

For the design of a:

Custom DETATCHED DUAL OCCUPANCY

WITH Custom FACADE

Mahdi Ashuri

63 / B / 192768 9 WILLIAM STREET MAYFIELD, NSW, 2304

BASIX AREAS

Conditioned Unconditioned 109.67 8.19 117.86 m²

FLOOR AREAS

UNIT 1 GROUND FLOOR FIRST FLOOR

64.82 GARAGE 32.77 6.03 172.26 m²

ROOF DETAILS

CUSTOM ORB ROOF SHE... CUSTOM ORB ROOF SHE... 5.0° 22.5° 85.69 55.31 55.52

> Wind Classification: Soil Classification N2 H1 Acid Sulphate Soil Mine Subsidence Yes/No Class 2 Acoustic Requirements: Mains Power: No Yes Mains Water Available: Yes Yes Mains Sewer Available: Stormwater Drainage Yes Kerb/Pit >1km to Breaking Surf: >100m to Salt Water: No No Flood Min RL: Yes/No No Bushfire Requirements:



No. DETAIL

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2. MI DESIGN CHANGES ISSUED FOR REVIEW AND COMMENT


3. MI BASIX COMMITMENTS ADDED


4. JL TOWN PLANNER AMENDMENTS

MI COUNCIL RFI AMENDMENTS, DWELLINGS ATTACHED
 MI MI UPDATED BASIX BLOCKS ADDED
 MI MINOS SETBACK ADJUSTMENTS + GFACALC UPDATE
 SHADOW DIAGRAMS UPDATE

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RIGHT ELEVATION

SCALE 1:100 @A3

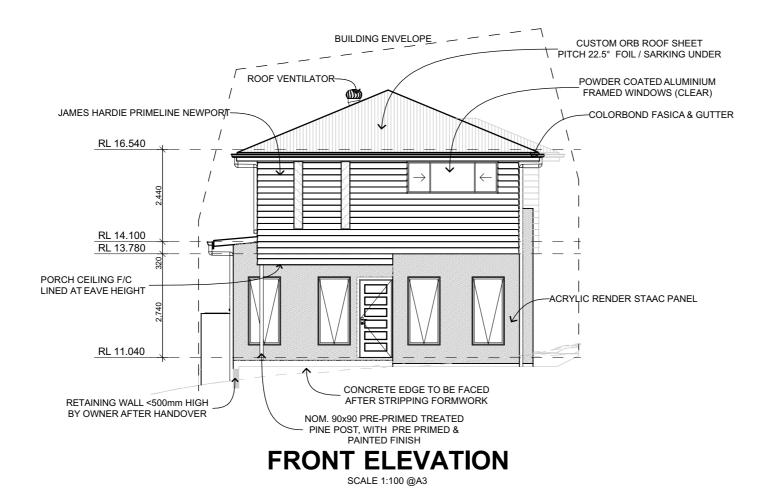WD12 20 **ELEVATIONS**

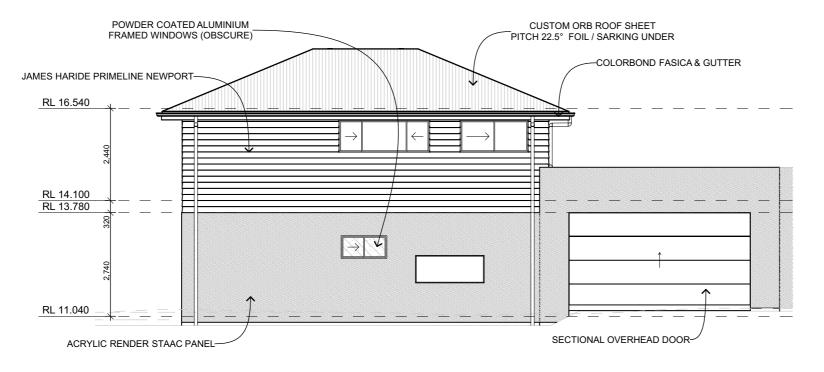0009WILL

12/10/2022 **CONTRACT**

PLANS For the design of a:

Custom DETATCHED DUAL OCCUPANCY

WITH Custom FACADE Mahdi Ashuri

63 / B / 192768

9 WILLIAM STREET MAYFIELD, NSW, 2304

NOTE: BRICK SILLS ARE TO BE PROVIDED TO WINDOWS AS PER BELOW;

- ALL WINDOWS FACING OUTDOOR LIVING AREAS (ALFRESCO) SNAP HEADER
- SPLASHBACK WINDOWS SNAP HEADER
 - ALL OTHER CASES RAKED SILL

N2	H1
Mine Subsidence:	Acid Sulphate Soil:
Yes/No	Class 2
Acoustic Requirements:	Mains Power:
No	Yes
Mains Water Available:	Mains Gas Available:
Yes	Yes
Mains Sewer Available:	Stormwater Drainage:
Yes	Kerb/Pit
>1km to Breaking Surf:	>100m to Salt Water:
No	No
Rock:	Flood Min RL:
Yes/No	No
Puphfire Do	uiromonte:

Wind Classification: Soil Classification:



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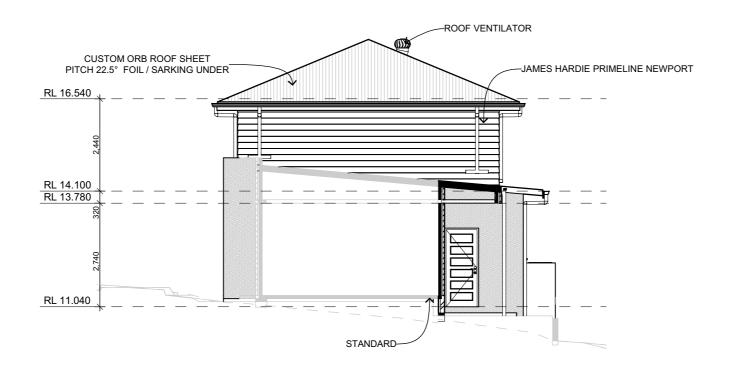
4. JL TOWN PLANNER AMENDMENTS

5. MI COUNCIL RFI AMENDMENTS, DWELLINGS ATTACHED


6. MI UPDATED BASIX BLOCKS ADDED

7. MI MINOR SETBACK ADJUSTMENTS + GFA CALC UPDATE

8. MI SHADOW DIAGRAMS UPDATE



REAR ELEVATION

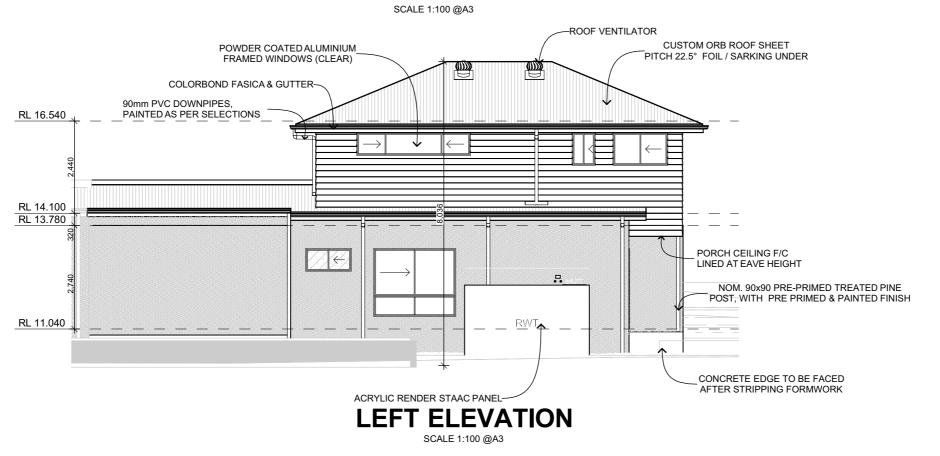

WD13_{of}20

ELEVATIONS

0009WILL

12/10/2022 **CONTRACT PLANS**

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Custom DETATCHED DUAL OCCUPANCY WITH Custom FACADE

Mahdi Ashuri

63 / B / 192768 9 WILLIAM STREET MAYFIELD, NSW, 2304

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Wind Classification: N2 H1 Acid Sulphate Soil: Mine Subsidence Yes/No Class 2 Acoustic Requirements: Mains Power: No Yes Mains Water Available: Yes Yes Mains Sewer Available: Stormwater Drainage Yes Kerb/Pit >1km to Breaking Surf: >100m to Salt Water: No No Flood Min RL: Yes/No No Bushfire Requirements:



No. DETAIL

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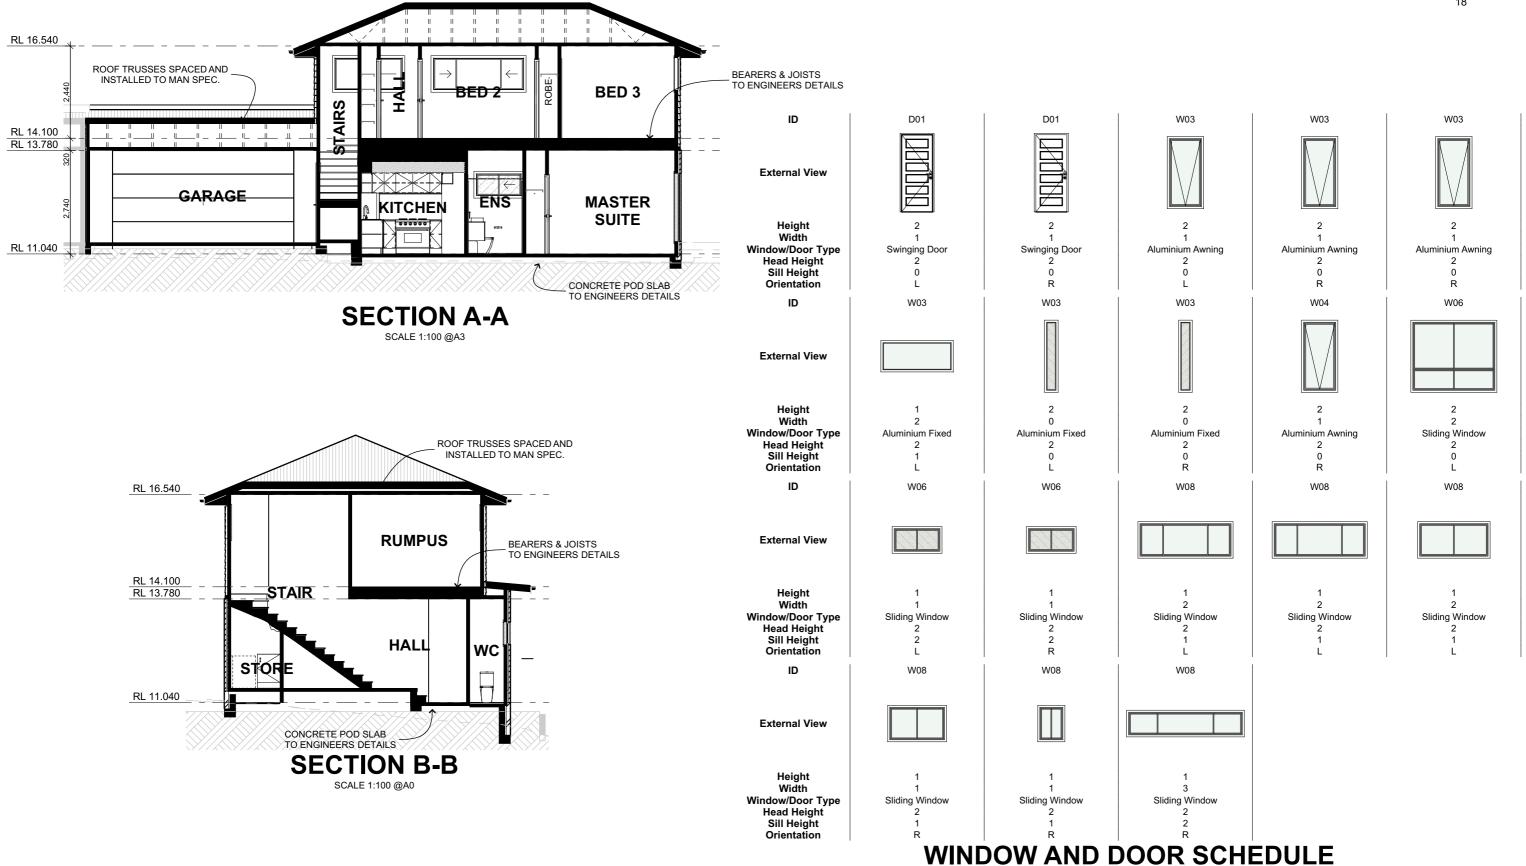
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HOUSE PLANNER AMENDMENTS, DWELLINGS ATTACHED
 MI COUNCIL RFI AMENDMENTS, DWELLINGS ATTACHED
 MI UPDATED BASIX BLOCKS ADDED
 MI MINOS SETBACK ADJUSTMENTS + GFACALC UPDATE
 SHADOW DIAGRAMS UPDATE

VITH HEART 🏈

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CONTRACT PLANS

63 / B / 192768 9 WILLIAM STREET MAYFIELD, NSW, 2304

Mahdi Ashuri

Wind Classification N2 Yes Yes Soil Classification: Stormwater Drainage Mains Gas Available: H1 Kerb/Pit Yes Mine Subsidence: Acid Sulphate Soil: Mains Sewer Available: Acou Yes/No Class 2 Yes

No Flood Requirements: No

No

>100m to Salt Water:

No

No

stic Requirements

No. DETAIL

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4. JL TOWN PLANNER AMENDMENTS

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8. MI SHADOW DIAGRAMS UPDATE

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WD14₆20 **SECTIONS** 0009WILL 12/10/2022

Yes/No

WORKING DOCUMENTATION

DWG No. DRAWING TITLE

WD14 **COVER SHEET - UNIT 2**

WD15 FLOOR PLAN

WD16 FLOOR PLAN - FIRST FLOOR

WD17 **ELEVATIONS** WD18 **ELEVATIONS** WD19 SECTION A-A



RIGHT ELEVATION

WD15,20

COVER SHEET - UNIT 2

0009WILL

12/10/2022 **CONTRACT PLANS**

For the design of a:

Custom DETATCHED DUAL OCCUPANCY WITH Custom FACADE

Mahdi Ashuri

63 / B / 192768 9 WILLIAM STREET MAYFIELD, NSW, 2304

N2 H1 Acid Sulphate Soil: Mine Subsidence: Yes/No Class 2 Acoustic Requirements: Mains Power: Yes No Mains Water Available: Yes Yes Mains Sewer Available: Stormwater Drainage Yes Kerb/Pit >1km to Breaking Surf: >100m to Salt Water: No No Flood Min RL: Yes/No No

Soil Classification:

Wind Classification:

No



No. DETAIL

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4. JL TOWN PLANNER AMENDMENTS


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83.66 m²

GROSS FLOOR AREA -

GROUND FLOOR

WD16,20

FLOOR PLAN

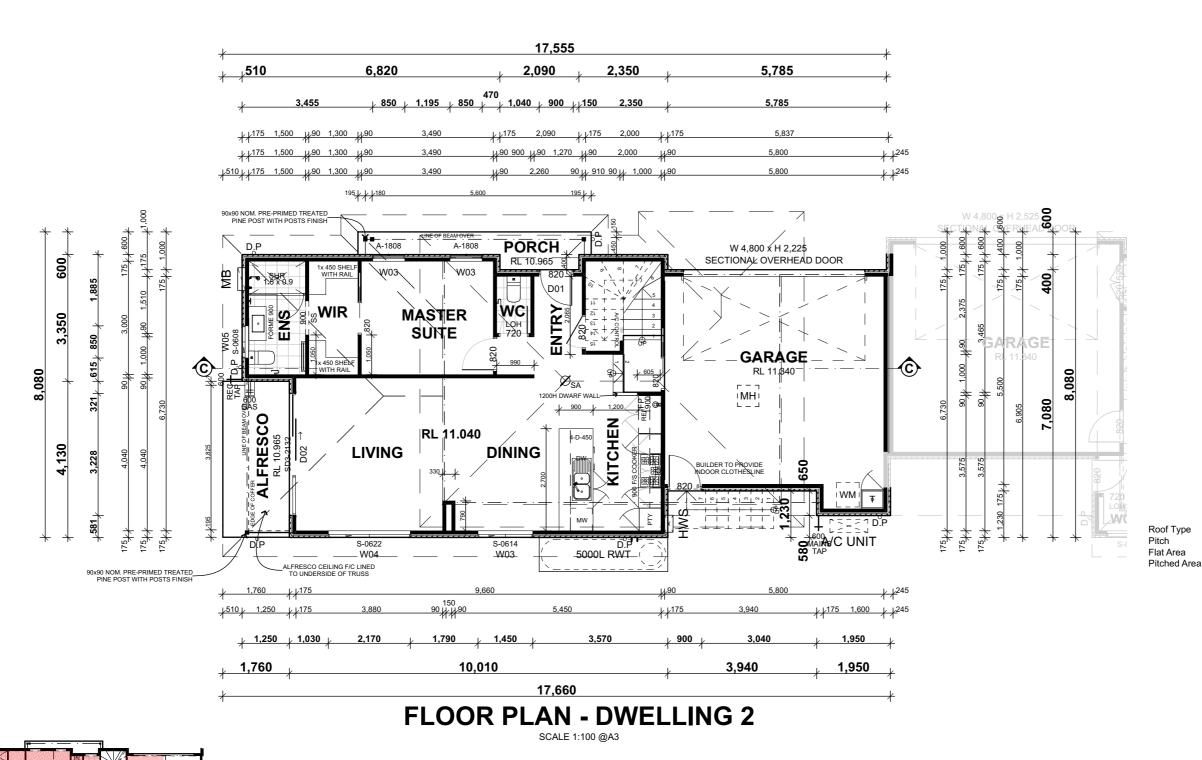0009WILL

12/10/2022 **CONTRACT PLANS**

Custom DETATCHED DUAL OCCUPANCY WITH Custom FACADE

Mahdi Ashuri

63 / B / 192768 9 WILLIAM STREET MAYFIELD, NSW, 2304

BASIX AREAS

UNIT 2

Conditioned Unconditioned

111.73 8.41 120.14 m²

FLOOR AREAS

UNIT 2

GROUND FLOOR	77.7
FIRST FLOOR	60.4
GARAGE	36.2
ALFRESCO	7.2
PORCH	4.5

186.19 m²

ROOF DETAILS

CUSTOM ORB ROOF SHE... CUSTOM ORB ROOF SHE.. 5.0° 22.5° 18.80 145.12 18.87 157.07

> Wind Classification: Soil Classification N2 H1 Acid Sulphate Soil Mine Subsidence Yes/No Class 2 Acoustic Requirements Mains Power: No Yes Yes Yes Mains Sewer Available: Stormwater Drainage Yes Kerb/Pit >1km to Breaking Surf: >100m to Salt Water No No Flood Min RL: Yes/No No

> > Bushfire Requirements: No



No. DETAIL

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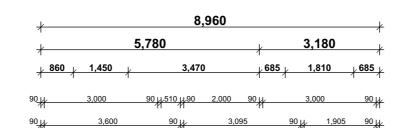
3. MI BASIX COMMITMENTS ADDED


4. JL TOWN PLANNER AMENDMENTS


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 MI INFORMETTS + GFA CALC UPDATE
 SHADOW DIAGRAMS UPDATE 16/08/2022 17/08/2022

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FIRST FLOOR PLAN - DWELLING 2



WD17_{21 of} 20

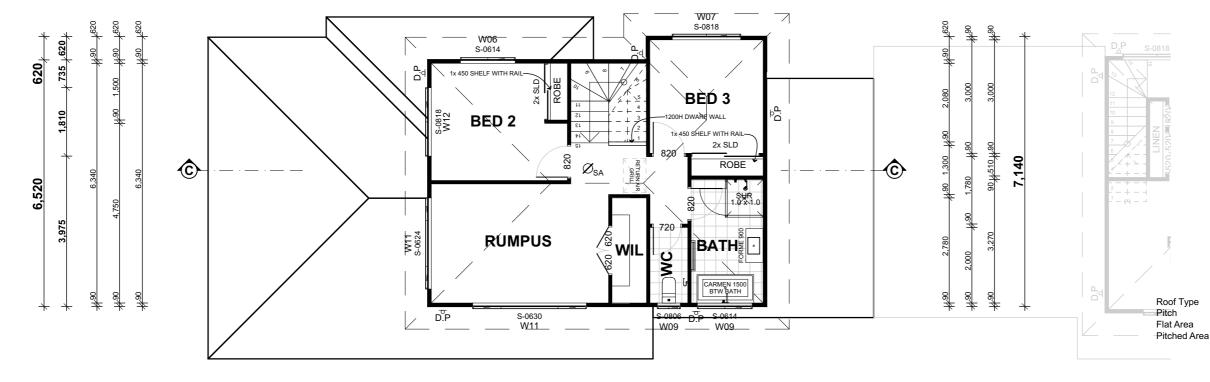FLOOR PLAN - FIRST FLOOR

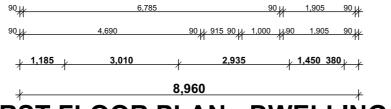0009WILL

12/10/2022 **CONTRACT PLANS**

For the design of a:

Custom DETATCHED DUAL OCCUPANCY

WITH Custom FACADE

Mahdi Ashuri

63 / B / 192768 9 WILLIAM STREET MAYFIELD, NSW, 2304

BASIX AREAS

UNIT 2

Conditioned

8.41 120.14 m²

FLOOR AREAS

UNIT 2

GROUND FLOOR	77.73
FIRST FLOOR	60.44
GARAGE	36.22
ALFRESCO	7.26
PORCH	4.54

186.19 m²

ROOF DETAILS

JSTOM ORB ROOF SHE	CUSTOM ORB ROOF SHE
5.0°	22.5°
18.80	145.12
18.87	157.07

Wind Classification:	Soil Classification:
N2	H1
Mine Subsidence:	Acid Sulphate Soil:
Yes/No	Class 2
Acoustic Requirements:	Mains Power:
No	Yes
Mains Water Available:	Mains Gas Available:
Yes	Yes
Mains Sewer Available:	Stormwater Drainage:
Yes	Kerb/Pit
>1km to Breaking Surf:	>100m to Salt Water:
No	No
Rock:	Flood Min RL:
Yes/No	No
Ruchfire Red	nuirements:



No. DETAIL

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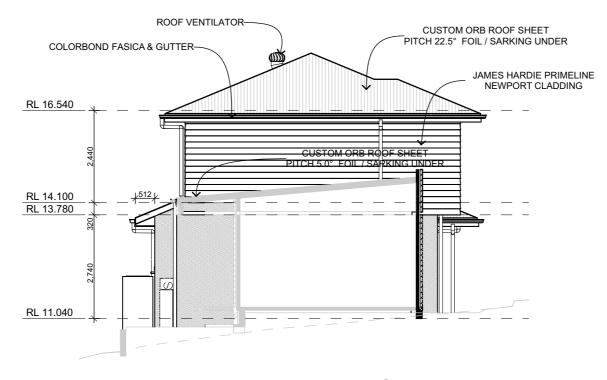
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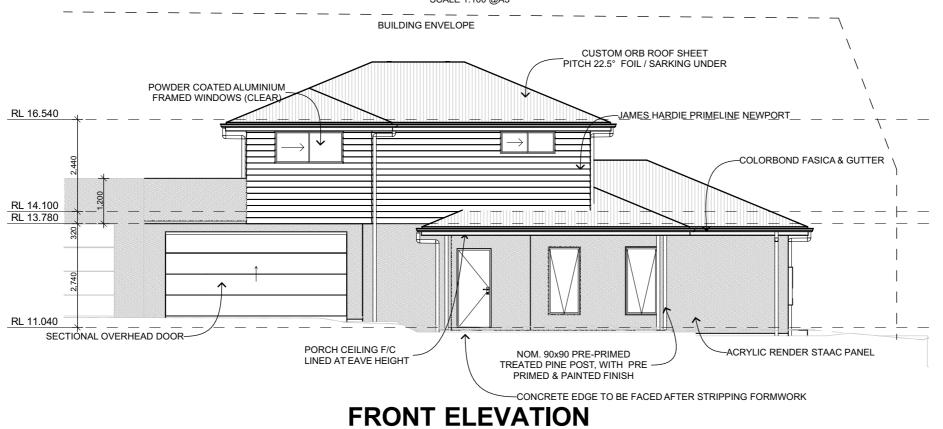
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LEFT ELEVATION

SCALE 1:100 @A3



No. DETAIL

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7. MI MINOR SETBACK ADJUSTMENTS + GFA CALC UPDATE

8. MI SHADOW DIAGRAMS UPDATE

WD18,20 **ELEVATIONS**

0009WILL

12/10/2022 **CONTRACT PLANS**

For the design of a:

Custom DETATCHED DUAL OCCUPANCY WITH Custom FACADE

Mahdi Ashuri

63 / B / 192768 9 WILLIAM STREET MAYFIELD, NSW, 2304

NOTE: BRICK SILLS ARE TO BE PROVIDED TO WINDOWS AS PER BELOW;


- ALL WINDOWS FACING OUTDOOR LIVING AREAS (ALFRESCO) SNAP HEADER
- SPLASHBACK WINDOWS SNAP HEADER
 - ALL OTHER CASES RAKED SILL

Wind Classification:	Soil Classification:
N2	H1
Mine Subsidence:	Acid Sulphate Soil:
Yes/No	Class 2
Acoustic Requirements:	Mains Power:
No	Yes
Mains Water Available:	Mains Gas Available:
Yes	Yes
Mains Sewer Available:	Stormwater Drainage:
Yes	Kerb/Pit
>1km to Breaking Surf:	>100m to Salt Water:
No	No
Rock:	Flood Min RL:
Yes/No	No
Bushfire Red	quirements:


No



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RIGHT ELEVATION

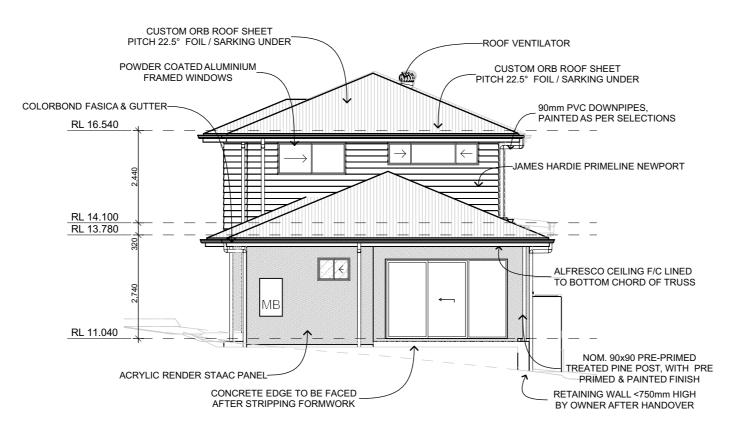

REAR ELEVATION

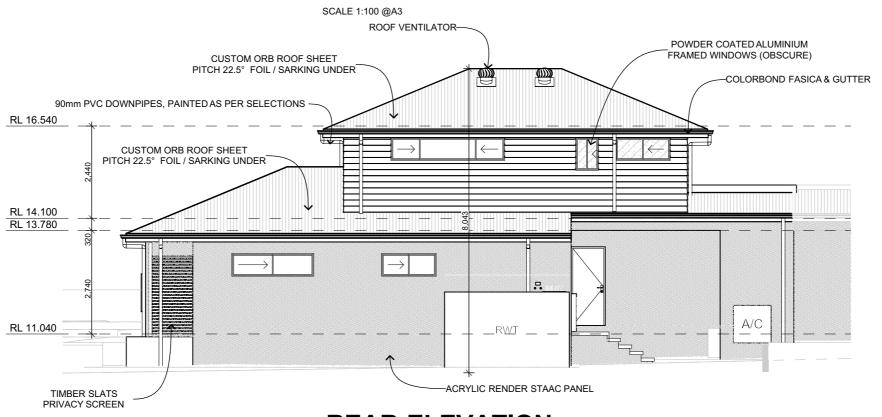SCALE 1:100 @A3

WITH Custom FACADE Mahdi Ashuri

63 / B / 192768 9 WILLIAM STREET MAYFIELD, NSW, 2304

WD19,20

ELEVATIONS

0009WILL

12/10/2022

CONTRACT

PLANS

For the design of a:

Custom DETATCHED DUAL OCCUPANCY

NOTE: BRICK SILLS ARE TO BE PROVIDED TO WINDOWS AS PER BELOW;

- ALL WINDOWS FACING OUTDOOR LIVING AREAS (ALFRESCO) SNAP HEADER
- SPLASHBACK WINDOWS SNAP HEADER
 - ALL OTHER CASES RAKED SILL

Willia Olassilloation.	Oon Olassincation.
N2	H1
Mine Subsidence:	Acid Sulphate Soil:
Yes/No	Class 2
Acoustic Requirements:	Mains Power:
No	Yes
Mains Water Available:	Mains Gas Available:
Yes	Yes
Mains Sewer Available:	Stormwater Drainage:
Yes	Kerb/Pit
>1km to Breaking Surf:	>100m to Salt Water:
No	No
Rock:	Flood Min RL:
Yes/No	No
Bushfire Red	quirements:

Wind Classification Soil Classification

No



No. DETAIL

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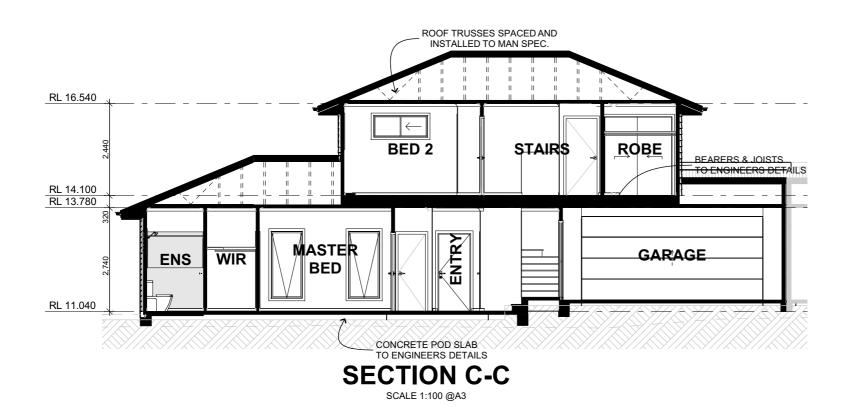
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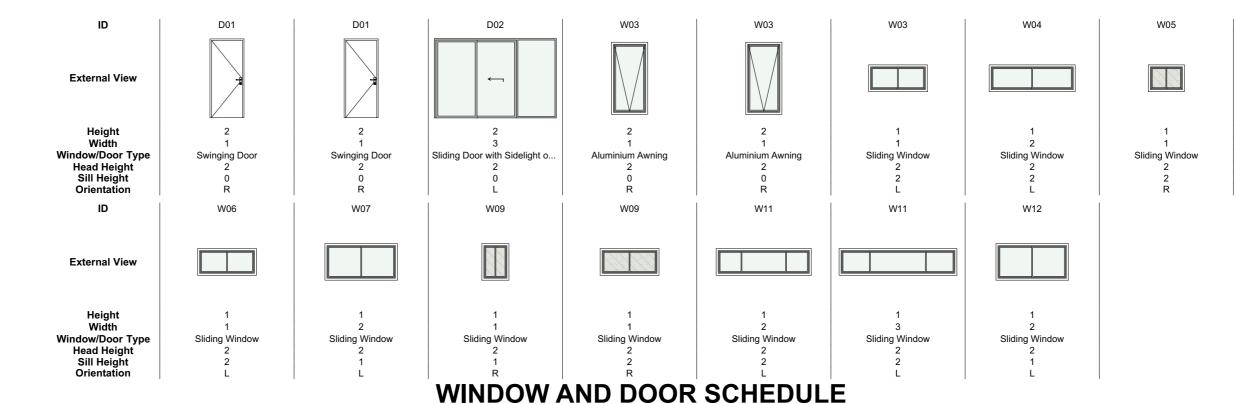
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CONTRACT PLANS

Mahdi Ashuri 63 / B / 192768 9 WILLIAM STREET MAYFIELD, NSW, 2304

Wind Classification Mains Water Available: >1km to Breaking Surf: N2 Yes Yes Soil Classification: Stormwater Drainage Mains Gas Available: >100m to Salt Water H1 Kerb/Pit Yes Mine Subsidence: Acid Sulphate Soil: Mains Sewer Available: Acoustic Requirements Yes/No Class 2 Yes

Bushfire Requirements: No Flood Requirements: No

Rock (Approx. Depth):

Yes/No

No

No

No

No. DETAIL

1. KD PLANS ISSUED FOR APPROVAL

2. MI DESIGN CHANGES ISSUED FOR REVIEW AND COMMENT

3. MI BASIX COMMITMENTS ADDED

4. JL TOWN PLANNER AMENDMENTS

5. MI COUNCIL RFI AMENDMENTS, DWELLINGS ATTACHED

6. MI UPDATED BASIX BLOCKS ADDED

7. MI MINOR SETBACK ADJUSTMENTS + GFA CALC UPDATE

8. MI SHADOW DIAGRAMS UPDATE

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VIVE WITH HEART V on:

WD20₀20 **SECTIONS** 0009WILL 12/10/2022



CIVIL SERVICES for 9 WILLIAM STREET, MAYFIELD NSW 2304

Prepared by

WALLACE INFRASTRUCTURE DESIGN PTY LTD

GENERAL NOTES

- 1. THESE PLANS ARE FOR DA PURPOSES ONLY AND SHALL NOT BE USED FOR CONSTRUCTION PURPOSES UNDER ANY CASE.
- 2. THESE PLANS ARE TO BE READ IN CONJUNCTION WITH OTHER RELEVANT REPORTS AND PLANS (INCLUDING BUT NOT LIMITED TO ARCHITECTURAL, GEOTECHNICAL, SURVEY ETC.).
- 3. LEVELS, OUTSIDE OF STORMWATER DESIGN LEVELS, ARE SHOWN FOR REFERENCE ONLY.



DRAWING NUMBER DRAWING DESCRIPTION LEGEND, DRAWING SCHEDULE AND LOCATION PLAN C01.01 C02.01 **GENERAL NOTES** C04.01 CIVIL WORKS AND STORMWATER DRAINAGE PLAN TYPICAL SECTIONS AND DETAILS

ABBREVIATIONS

A/G AGG ARCH ASP BM CAD C/C CH CJ CO CONC CTRL CR CTS DIA DP	ABOVE GROUND AGGREGATE ARCHITECT ASPHALT BENCHMARK COMPUTER AIDED DRAFTING CENTRE TO CENTRE CHAINAGE CAST IRON CONSTRUCTION JOINT COVER LEVEL or CENTRE LINE CLEAN OUT (SUBSOIL) CHANGE OF GRADE CONCRETE CONTROL CROWN CENTRES DIAMETRE DOWNPIPE	GA GI IC ID IFC IFCR IL IO KIP LP (m) MAX MC MH MIN MISC N NRV NTS	GENERAL ARRANGEMENT GALVANISED IRON INSPECTION CHAMBER INSIDE DIAMETER ISSUED FOR CONSTRUCTION ISSUED FOR CLIENT REVIEW INVERT LEVEL INSPECTION OPENING KERB INLET PIT LAMP POST (SURVEY) METRE MAXIMUM MASS CONCRETE MANHOLE MINIMUM MISCELLANEOUS NORTH NON RETURN VALVE NOT TO SCALE	SC SF S/S SV SV SV
	CHAINAGE	Ю	INSPECTION OPENING	
		_		
		LP	LAMP POST (SURVEY)	SM
CL	COVER LEVEL or CENTRE LINE	(m)	METRE	SC
CO	CLEAN OUT (SUBSOIL)	MAX	MAXIMUM	SP
COG	CHANGE OF GRADE	MC	MASS CONCRETE	S/S
CONC	CONCRETE	MH	MANHOLE	ST
CTRL	CONTROL	MIN	MINIMUM	SV
CR	CROWN	MISC	MISCELLANEOUS	SV
CTS	CENTRES	N	NORTH	SV
DIA	DIAMETRE	NRV	NON RETURN VALVE	TH
DP	DOWNPIPE	NTS	NOT TO SCALE	TC
DRG	DRAWING	OD	OUTER DIAMETER	TV
D/S	DOWN STREAM	OF	OVERFLOW	TY
DTM	DIGITAL TERRAIN MODEL	OH	OVERHEAD	U/C
EB	EDGE BEAM	PP	POWER POLE	UN
EX	EXISTING	PPE	PERSONAL PROTECTIVE EQUIPMENT	U/S
ESL	EXISTING SURFACE LEVEL	PVC	POLYVINYLCHLORIDE	VC
FH	FIRE HYDRANT	PV	PRESSURE VENT	VP
FHR	FIRE HOSE REEL	PVP	PRESSURE VENT PIPE	VR
FFL	FINISHED FLOOR LEVEL	QA	QUALITY ANALYSIS	W(
FGL	FINISHED GROUND LEVEL	QTY	QUANTITY	WL
FSL	FINISHED SURFACE LEVEL	RAD	RADIUS	WI
FW	FLOOR WASTE	RC	REINFORCED CONCRETE	WS

REVISION REDUCED LEVEL ROLLED STEEL JOIST RETAINING WALL SEALED FLOOR WASTE SHOWER KITCHEN SINK SURFACE LEVEL

SEWER MAN HOLE SEWER MAIN VENT SIDE OUTLET DRAIN SPRINKLER STAINLESS STEEL STANDARD STOP VALVE STORMWATER PIT THICKNESS TOP OF WALL TRADE WASTE TYPICAL UNDERGROUND UPSTREAM

STORMWATER DRAINAGE UNLESS NOTED OTHERWISE VITRIFIED CLAY PIPE VENT PIPE VERTICAL RISER WATER CLOSET WATER LEVEL WATER MARK WASTE STACK

LINETYPES

GENERAL		PROPOSED - UTILITIES (cont.)	
SITE BOUNDARY		SEWER PIPE	— S - S - S - S -
CADASTRAL BOUNDARY		WATER	— w- w- w-
EASEMENT BOUNDARY		COMMUNICATIONS	
		COMMUNICATIONS - OPTIC FIBRE	
EXISTING - SURVEY FEATURES		COMMUNICATIONS PIT	
CONTOURS	30.0	GAS	
STORMWATER PIPE		REDUNDANT	$\cdots \times \times$
STORMWATER PIT			
TREES / SHRUBS	0 0 0 0	PROPOSED - EROSION AND SEDIM	MENT CONTROL
ELECTRICAL CABLE - U/G	———— Е ——	SITE EXCLUSION FENCE	[X] - [X] - [X] -
ELECTRICAL CABLE - O/H	O/H O/H O/H	STABLISED SITE ACCESS	
EXISTING SEWER PIPE	— s - s - s - s —	SEDIMENT FENCE	
EXISTING WATER	$ \ W - \ W - \ W - \ W -$	MATERIAL STOCKPILE	//////////////////////////////////////
EXISTING WATER (HYDRANT)	•	DIVERSION DRAIN	->->->-
EXISTING WATER (STOP VALVE)	X	SLOPE DIRECTION	>
EXISTING TELECOM	———— т ——	MESH AND GRAVEL INLET FILTER	
EXISTING GAS	G		
BUILDING FOOTPRINT		PROPOSED - ARCHITECTURE (IND	ICATIVE ONLY)
		DWELLING NUMBER	UNIT 01
PROPOSED - UTILITIES		FLOOR LEVEL	FFL 5.00
ELECTRICAL CABLE - U/G	— E – E – E – E —	BUILDING FOOTPRINT	
ELECTRICAL CABLE - O/H	О/Н О/Н О/Н		

SYMBOLS

	<u>011011</u>	<u> </u>	
PROPOSED - SWD (STORMWATER	R DRAINAGE)	PROPOSED - CIVIL	
SWD PIPE	ØXXXmm uPVC X.X% GRADE, X.XXm	CONCRETE	
(INCL. DIA/GRADE/LENGTH)		ASPHALTIC CONCRETE	
SWD PIPE - CHARGED (INCL. DIA/GRADE/LENGTH)	ØXXXmm uPVC CHARGE X.X% GRADE, X.XXm	SAND	
SWD PIT - GRATED		EARTH	
SWD - KERB INLET PIT		RIP RAP	
(INCLUDING LINTEL)		BUILDING / STRUCTURES	
SWD PIT - JUNCTION		TIMBER	
SWD LABEL	PIT XX SUR: XX.XXX	BLOCK PAVERS	
(TYPE / COVER LEVEL)	INV: XX.XXX	RETAINING WALL	
RAINWATER/REUSE TANK	OR (/////)	KERB RAMP	
GROSS POLLUTANT TRAP	GPT	VEHICULAR CROSSING	
GRATED DRAIN		FENCE	
INFILTRATION TRENCH		PROPOSED TREE	
HEADWALL		BATTER	
SUBSOIL	->>	BOLLARD - TYPE 1 (FIXED)	● B-T1
STORMWATER SWALE	->>>-	BOLLARD - TYPE 2 (REMOVABLE)	• B-T2
PIPE RISER	\circ XX	LINEMARKING - CHEVRON	
PIPE DROPPER	\sim XX \subset	PAVEMENT EXPANSION JOINT	
OVERLAND FLOW PATH	→		
		PAVEMENT CONTROL JOINT	CJ

AutoCAD Civil 3D 2021

DRAWING MUST NOT BE REPRODUCED IN ANY RAWING HAS BEEN PRODUCED FOR TH ESIGN INTENT AND SCOPE OF WORKS EQUIRED FOR THE INSTALLATION OF SERVICES S DETAILED, AND PERTAINED WITHIN THE ECIFICATION AND SHOULD BE READ IN ECIFICATION, ASSOCIATED SPECIFICAT ODES AND STANDARDS. ALL DIMENSIONS, EVELS AND EXISTING SERVICES SHALL BE STIGATED AND CONFIRMED ON SITE BY TH

OMMENCEMENT OF ANY WORKS.

HIS DRAWING IS NOT APPROVED FOR CONSTRUCTION UNLESS ENDORS B DEVELOPMENT APPLICATION ISSUE 30.08.22 S.S. A PRELIMINARY ISSUE 01.07.22 S.S. DATE APPV'D ENDO'D

MAHDI ASHURI



WALLACE INFRASTRUCTURE **DESIGN PTY LTD** PART OF WALLACE DESIGN GROUP PTY LTD PO BOX 850, WARNERS BAY, NSW 2282

CIVIL WORKS for LOT 63 SEC B DP 192768 9 WILLIAM STREET MAYFIELD NSW 2304

DRAWING TITLE: CIVIL SERVICES LEGEND, DRAWING SCHEDULE AND LOCATION PLAN

DRAWING STATUS DA APPROVAL SCALE: Α1 DESIGNED CHECKED APPROVED ENDORSED DATE DRAWN KB 30.08.22 PROJECT No. 22215 C01.01

- ENGINEERING REQUIREMENTS FOR DEVELOPMENTS.
- ALL DIMENSIONS, EASEMENTS AND LOTS SUBJECT TO REGISTRATION OF DEPOSITED PLAN. THESE DRAWINGS ARE TO BE READ IN CONJUNCTION WITH ALL ARCHITECTURAL AND CONSULTANT'S DRAWINGS AND SPECIFICATIONS, AND OTHER WRITTEN REPORTS (e.g. GEOTECHNICAL, ARBORIST, ENVIRONMENTAL, ETC.). ANY DISCREPANCY SHALL BE REFERRED TO THE ENGINEER BEFORE PROCEEDING WITH ANY WORKS.
- ALL LEVELS SHALL BE OBTAINED FROM ESTABLISHED BENCH MARKS AS DIRECTED BY THE SUPERVISOR.
- THE DEVELOPER, SHALL ENSURE ALL ASSOCIATED DOCUMENTATION (GEOTECHNICAL, LANDSCAPE, ARCHITECTURAL, ELECTRICAL, TELECOM, GAS ETC.) HAS BEEN APPROVED FOR CONSTRUCTION BEFORE COMMENCING ANY WORKS.
- THE CONTRACTOR IS RESPONSIBLE FOR THE LOCATION, PROTECTION AND ADJUSTMENT TO ALL IN GROUND AND ABOVE GROUND SERVICES. SEE HUNTER WATER'S NOTICE OF REQUIREMENTS.
- EROSION CONTROL MEASURES, DEVICES, SILT TRAPS. ETC. ARE TO BE INSTALLED BEFORE ANY SITE DISTURBANCE IN ACCORDANCE WITH COUNCIL INSPECTORS REQUIREMENTS AND SITE SEDIMENTATION AND EROSION CONTROL PLANS.
- IT IS THE CONTRACTORS RESPONSIBILITY TO ENSURE THAT ALL WORKS ARE CARRIED OUT IN ACCORDANCE WITH THE WORK HEALTH SAFETY ACT.
- VEHICULAR ACCESS AND ALL SERVICES ARE TO BE MAINTAINED AT ALL TIMES TO ADJOINING PROPERTIES AFFECTED BY CONSTRUCTION WORKS.
- ALL WASTE OR DEMOLISHED MATERIALS SHALL BE DISPOSED OF OFF SITE TO A COUNCIL
- APPROVED SITE. ALL FEES AND CHARGES SHALL BE INCLUDED IN THE CONTRACT SUM.
- CONSTRUCTION VIBRATION TO COMPLY WITH AS2760.1-2004 AND/OR NSW DEPT OF **ENVIRONMENT AND CONSERVATION NOISE REQUIREMENTS**
- EMISSIONS FROM SITE ARE NOT TO INTERFERE WITH THE AMENITY OF THE NEIGHBORHOOD.
- 13. NOISE EMISSIONS ARE TO COMPLY WITH NSW EPA NOISE CONTROL MANUAL. TIME RESTRICTIONS APPLY TO CONSTRUCTION WORKS AS FOLLOWS: 7AM TO 6PM MON-FRI; 8AM TO
- TREES & SHRUBS WHICH ARE FELLED SHALL BE SALVAGED FOR RE-USE, EITHER IN LOG FORM, OR AS A WOODCHIP MULCH FOR EROSION CONTROL AND/OR SITE REHABILITATION. NON-SALVAGEABLE MATERIAL SUCH AS ROOTS & STUMPS SHALL BE DISPOSED OF IN AN APPROVED MANNER.
- 'ESCP' REFERS TO EROSION AND SEDIMENT CONTROL PLAN, 'SWMP' REFERS TO SOIL AND WATER MANAGEMENT PLAN, AND, 'ESC' REFERS TO EROSION AND SEDIMENT CONTROL
- SEDIMENT, INCLUDES, BUT IS NOT LIMITED TO, CLAY, SILT, SAND, GRAVEL, SOIL, MUD, CEMENT AND CERAMIC WASTE.
- ANY REFERENCE TO THE BLUE BOOK REFERS TO "MANAGING URBAN STORMWATER SOILS AND CONSTRUCTION", LANDCOM, 2004.
- ANY REFERENCE TO THE IECA WHITE BOOKS (2008) REFERS TO IECA 2008, "BEST PRACTICE EROSION AND SEDIMENT CONTROL". BOOKS 1-6. INTERNATIONAL EROSION CONTROL ASSOCIATION (AUSTRALASIA), PICTON, NSW.
- ANY MATERIAL DEPOSITED IN ANY CONSERVATION AREA FROM WORKS ASSOCIATED WITH THE DEVELOPMENT SHALL BE REMOVED IMMEDIATELY BY MEASURES INVOLVING MINIMAL GROUND AND/OR VEGETATION DISTURBANCES AND NO MACHINERY. OR FOLLOWING DIRECTIONS BY COUNCIL AND/OR WITHIN A TIMEFRAME ADVISED BY COUNCIL

SURVEY NOTES

THE EXISTING SURVEY CONDITIONS SHOWN ON THESE DRAWINGS HAVE BEEN DERIVED FROM

SURVEY INFORMATION SUPPLIED BY PARKER SCANLON DATED 02/09/2021 REF NO. 14962CON-A

- THE INFORMATION SHOWN IS PROVIDED AS A BASIS FOR THE DESIGN. WALLACE DESIGN GROUP DOES NOT GUARANTEE THE ACCURACY OR COMPLETENESS OF THE SURVEY BASE OR ITS SUITABILITY AS A BASIS FOR CONSTRUCTION DRAWINGS.
- SHOULD DISCREPANCIES BE ENCOUNTERED DURING CONSTRUCTION BETWEEN THE SURVEY DATA AND ACTUAL FIELD DATA, CONTRACTOR SHALL CONTACT PARKER SCANLON
- THE CONTRACTOR SHALL ARRANGE ALL SURVEY SETOUT TO BE CARRIED OUT BY A REGISTERED SURVEYOR.

THE ESCP

- THE ESCP AND ITS ASSOCIATED ESC MEASURES SHALL BE CONSTANTLY MONITORED, REVIEWED AND MODIFIED AS REQUIRED TO CORRECT DEFICIENCIES. COUNCIL HAS THE RIGHT TO DIRECT CHANGES IF, IN ITS OPINION, THE MEASURES THAT ARE PROPOSED OR HAVE BEEN INSTALLED ARE INADEQUATE TO PREVENT POLLUTION.
- PRIOR TO ANY ACTIVITIES ONSITE, THE RESPONSIBLE PERSON(S) IS TO BE NOMINATED. THE RESPONSIBLE PERSON(S) SHALL BE RESPONSIBLE FOR THE ESC MEASURES ONSITE. THE NAME, ADDRESS AND 24 HOUR CONTACT DETAILS OF THE PERSON(S) SHALL BE PROVIDED TO COUNCIL IN WRITING. COUNCIL SHALL BE ADVISED WITHIN 48 HOURS OF ANY CHANGES TO THE RESPONSIBLE PERSON(S), OR THEIR CONTACT DETAILS, IN WRITING
- AT LEAST 14 DAYS BEFORE THE NATURAL SURFACE IS DISTRIBUTED IN ANY NEW STAGE, THE CONTRACTOR SHALL SUBMIT TO THE CERTIFIER A PLAN SHOWING ESC MEASURES FOR THAT STAGE. THE DEGREE OF DESIGN DETAIL SHALL BE BASED ON THE DISTRIBUTED AREA.
- AT ANY TIME. THE ESC MEASURES ONSITE SHALL BE APPROPRIATE FOR THE AREA OF DISTURBANCE AND ITS CHARACTERISTICS, INCLUDING SOIL TYPE (IN ACCORDANCE WITH THOSE REQUIRED FOR THE SITE AS PER THE DCP).
- THE IMPLEMENTATION OF THE ESCP SHALL BE SUPERVISED BY PERSONNEL WITH
- THE APPROVED ESCP SHALL BE AVAILABLE ON-SITE FOR INSPECTION BY COUNCIL OFFICERS WHILE WORK ACTIVITIES ARE OCCURRING.

APPROPRIATE QUALIFICATIONS AND/OR EXPERIENCE IN ESC ON CONSTRUCTION SITES.

- THE APPROVED ESCP SHALL BE UP TO DATE AND SHOW A TIMELINE OF INSTALLATION, MAINTENANCE AND REMOVAL OF ESC MEASURES.
- ALL ESC MEASURES SHALL BE APPROPRIATE FOR THE SEDIMENT TYPE(S) OF THE SOILS ONSITE. IN ACCORDANCE WITH THE BLUE BOOK, IECA WHITE BOOKS OR OTHER CURRENT
- ADEQUATE SITE DATA, INCLUDING SOIL DATA FROM A NATA APPROVED LABORATORY, SHALL BE OBTAINED TO ALLOW FOR THE PREPARATION OF AN APPROPRIATE ESCP, AND TO ALLOW FOR THE SELECTION, DESIGN AND SPECIFICATION OF REQUIRED ESC MEASURES.

RECOGNISED INDUSTRY STANDARDS PERTAINING TO ESC FOR AUSTRALIAN CONDITIONS.

- ALL WORK SHALL BE CARRIED OUT IN ACCORDANCE WITH THE APPROVED ESCP (AS AMENDED FROM TIME TO TIME) UNLESS CIRCUMSTANCES ARISE WHERE: A) COMPLIANCE WITH THE ESCP WOULD INCREASE THE POTENTIAL FOR ENVIRONMENTAL HARM B) CIRCUMSTANCES CHANGE DURING CONSTRUCTION AND THOSE CIRCUMSTANCES COULD NOT HAVE BEEN FORSEEN: OR C) COUNCIL DETERMINES THAT UNACCEPTABLE OFF-SITE SEDIMENTATION IS OCCURRING AS A RESULT OF A LAND-DISTURBING ACTIVITY. IN EITHER CASE, THE PERSON(S) RESPONSIBLE MAY BE REQUIRED TO TAKE ADDITIONAL, OR ALTERNATIVE PROTECTIVE ACTION, AND/OR
- UNDERTAKE REASONABLE RESTORATION WORKS WITHIN THE TIMEFRAME SPECIFIED BY THE COUNCIL. ADDITIONAL ESC MEASURES SHALL BE IMPLEMENTED, AND A REVISED ESCP SUBMITTED FOR APPROVAL TO THE CERTIFIER (WITHIN 5 BUSINESS DAYS OF AN SUCH AMENDMENTS) IN THE
- **EVENT THAT:** A) THERE IS A HIGH PROBABILITY THAT SERIOUS OR MATERIAL ENVIRONMENTAL HARM MAY
 - OCCUR AS A RESULT OF SEDIMENT LEAVING THE SITE; OR B) THE IMPLEMENTED WORKS FAIL TO ACHIEVE COUNCIL'S WATER QUALITY OBJECTIVES
 - SPECIFIED IN THESE CONDITIONS; OR C) SITE CONDITIONS SIGNIFICANTLY CHANGE: OR
- D) SITE INSPECTIONS INDICATE THAT THE IMPLEMENTED WORKS ARE FAILING TO ACHIEVE THE "OBJECTIVE" OF THE ESCP.
- A COPY OF ANY AMENDED ESCP SHALL BE FORWARDED TO AN APPROPRIATE COUNCIL OFFICER. WITHIN FIVE BUSINESS DAYS OF ANY SUCH AMENDMENTS

SITE ESTABLISHMENT INCLUDING CLEARING AND MULCHING

- NO LAND CLEARING SHALL BE UNDERTAKEN UNLESS PRECEDED BY THE INSTALLATION OF ADEQUATE DRAINAGE AND SEDIMENT CONTROL MEASURES. UNLESS SUCH CLEARING IS REQUIRED FOR THE PURPOSE OF INSTALLING SUCH MEASURES, IN WHICH CASE, ONLY THE MINIMUM CLEARING REQUIRED TO INSTALL SUCH MEASURES SHALL OCCUR.
- BULK TREE CLEARING AND GRUBBING OF THE SITE SHALL BE IMMEDIATELY FOLLOWED BY SPECIFIED TEMPORARY EROSION CONTROL MEASURES (E.G. TEMPORARY GRASSING OR MULCHING) PRIOR TO THE COMMENCEMENT OF EACH STAGE OF CONSTRUCTION WORKS.
- TREES AND VEGETATION CLEARED FROM THE SITE SHALL BE MULCHED ONSITE WITHIN 7 DAYS OF CLEARING.
- APPROPRIATE MEASURES SHALL BE UNDERTAKEN TO CONTROL ANY DUST ORIGINATING DUE TO THE MULCHING OF VEGETATION ONSITE.
- ALL OFFICE FACILITIES AND OPERATIONAL ACTIVITIES SHALL BE LOCATED SUCH THAT ANY EFFLUENT. INCLUDING WASH-DOWN WATER. CAN BE TOTALLY CONTAINED AND TREATED WITHIN THE SITE.
- ALL REASONABLE AND PRACTICABLE MEASURES SHALL BE TAKEN TO ENSURE STORMWATER RUNOFF FROM ACCESS ROADS AND STABILISED ENTRY/EXIT SYSTEMS DRAINS TO AN APPROPRIATE SEDIMENT CONTROL DEVICE.
- SITE EXIT POINTS SHALL BE APPROPRIATELY MANAGED TO MINIMISE THE RISK OF SEDIMENT BEING TRACKED ONTO SEALED, PUBLIC ROADWAYS.
- STORMWATER RUNOFF FROM ACCESS ROADS AND STABILIZED ENTRY/EXIT POINTS SHALL DRAIN TO AN APPROPRIATE SEDIMENT CONTROL DEVICE.
- THE APPLICANT SHALL ENSURE AN ADEQUATE SUPPLY OF ESC, AND APPROPRIATE POLLUTION CLEAN-UP MATERIALS ARE AVAILABLE ON-SITE AT ALL TIMES. ALL TEMPORARY EARTH BANKS, FLOW DIVERSION SYSTEMS, AND SEDIMENT BASIN
- 10. EMBANKMENTS SHALL BE MACHINE-COMPACTED, SEEDED AND MULCHED WITHIN 10 DAYS OF FORMATION FOR THE PURPOSE OF ESTABLISHING A VEGETATIVE COVER, OR LINED APPROPRIATELY.
- SEDIMENT DEPOSITED OFF SITE AS A RESULT OF ON-SITE ACTIVITIES SHALL BE COLLECTED AND THE AREA CLEANED/REHABILITATED AS SOON AS REASONABLE AND PRACTICABLE.
- CONCRETE WASTE AND CHEMICAL PRODUCTS INCLUDING PETROLEUM AND OIL-BASED PRODUCTS, SHALL BE PREVENTED FROM ENTERING ANY INTERNAL OR EXTERNAL WATER BODY, OR ANY EXTERNAL DRAINAGE SYSTEM, EXCLUDING THOSE ON-SITE WATER BODIES SPECIFICALLY DESIGNED TO CONTAIN AND/OR TREAT SUCH MATERIAL. APPROPRIATE

- MEASURES SHALL BE INSTALLED TO TRAP THESE MATERIALS ONSITE.
- BRICK, TILE OR MASONRY CUTTINGS SHALL BE CARRIED OUT ON A PERVIOUS SURFACE (E.G. GRASS OR OPEN SOIL) AND IN SUCH A MANNER THAT ANY RESULTING SEDIMENT-LADEN RUNOFF IS PREVENTED FROM DISCHARGING INTO A GUTTER, DRAIN OR WATER. APPROPRIATE MEASURES SHALL BE INSTALLED TO TRAP THESE MATERIALS ONSITE.
- NEWLY SEALED HARD-STAND AREAS (E.G. ROADS, DRIVEWAYS AND CAR PARKS) SHALL BE SWEPT THOROUGHLY AS SOON AS PRACTICABLE AFTER SEALING/SURFACING TO MINIMISE THE RISK OF COMPONENTS OF THE SURFACING COMPOUND ENTERING THE STORMWATER DRAINS.
- 15. STOCKPILES OF ERODIBLE MATERIAL SHALL BE PROVIDED WITH AN APPROPRIATE PROTECTIVE COVER (SYNTHETIC OR ORGANIC) IF THE MATERIALS ARE LIKELY TO BE STOCKPILED FOR MORE THAN 10 DAYS.
- 16. STOCKPILES, TEMPORARY OR PERMANENT, SHALL NOT BE LOCATED IN AREAS IDENTIFIED AS NO-GO ZONES (INCLUDING, BUT NOT LIMITED TO, RESTRICTED ACCESS AREAS, BUFFER ZONES OR AREAS OF NON-DISTURBANCE) ON THE ESCP.
- 17. NO MORE THAN 150m OF STORMWATER, SEWER LINE OR OTHER SERVICE TRENCH SHALL BE TO OPEN AT ANY ONE TIME.
- SITE SPOIL SHALL BE LAWFULLY DISPOSED OF IN A MANNER THAT DOES NOT RESULT IN ONGOING SOIL EROSION OR ENVIRONMENTAL HARM.
- WHEREVER REASONABLE AND PRACTICABLE. STORMWATER RUNOFF ENTERING THE SITE FROM EXTERNAL AREAS, AND NON-SEDIMENT LADEN (CLEAN) STORMWATER RUNOFF ENTERING A WORK AREA OR AREA OF SOIL DISTURBANCE, SHALL BE DIVERTED AROUND OR THROUGH THAT AREA IN A MANNER THAT MINIMISES SOIL EROSION AND THE CONTAMINATION OF THAT WATER FROM ALL DISCHARGES UP TO THE SPECIFIED DESIGN STORM DISCHARGE.

SITE MANAGEMENT INCLUDING DUST

- PRIORITY SHALL BE GIVEN TO THE PREVENTION, OR AT LEAST THE MINIMISATION, OF SOIL EROSION, RATHER THAN THE TRAPPING OF DISPLACED SEDIMENT. SUCH A CLAUSE SHALL NOT REDUCE THE RESPONSIBILITY TO APPLY AND MAINTAIN, AT ALL TIMES, ALL NECESSARY ESC
- MEASURES USED TO CONTROL WIND EROSION SHALL BE APPROPRIATE FOR THE LOCATION AND PREVENT SOIL EROSION AND EMISSIONS FROM SITE AT ALL TIMES. INCLUDING WORKING HOURS, OUT OF HOURS, WEEKENDS, PUBLIC HOLIDAYS, AND DURING ANY OTHER SHUTDOWN PERIODS.
- THE APPLICATION OF LIQUID OR CHEMICAL-BASED DUST SUPPRESSION MEASURES SHALL ENSURE THAT SEDIMENT-LADEN RUNOFF RESULTING FROM SUCH MEASURES DOES NOT CREATE A TRAFFIC OR ENVIRONMENTAL HAZARD.
- ALL CUT AND FILL EARTH BATTERS LESS THAN 3m IN ELEVATION SHALL BE TOPSOILED, AND GRASS SEEDED/HYDROMULCHED WITHIN 10 DAYS OF COMPLETION OF GRADING IN CONSULTATION WITH COUNCIL.
- ALL DISTURBED AREAS SHALL BE STABILISED IN ACCORDANCE WITH TIMELINES IN THE BLUE
- ALL REASONABLE AND PRACTICABLE MEASURES SHALL BE TAKEN TO PREVENT, OR AT LEAST MINIMISE, THE RELEASE OF SEDIMENT FROM THE SITE.
- SUITABLE ALL-WEATHER MAINTENANCE ACCESS SHALL BE PROVIDED TO ALL SEDIMENT CONTROL DEVICES.
- SEDIMENT CONTROL DEVICES OTHER THAN SEDIMENT BASINS SHALL BE DE-SILTED AND MADE FULLY OPERATIONAL AS SOON AS REASONABLE AND PRACTICABLE AFTER A SEDIMENT-PRODUCING EVENT. WETHER NATURAL OR ARTIFICIAL, IF THE DEVICES SEDIMENT RETENTION CAPACITY FALLS BELOW 75% OF ITS DESIGNED RETENTION CAPACITY.
- ALL EROSION AND SEDIMENT CONTROL MEASURES, INCLUDING DRAINAGE CONTROL MEASURES. SHALL BE MAINTAINED IN PROPER WORKING ORDER AT ALL TIMES DURING THEIR OPERATION LIVES.
- WASHING/FLUSHING OF SEALED ROADWAYS SHALL ONLY OCCUR WHERE SWEEPING HAS FAILED TO REMOVE SUFFICIENT SEDIMENT AND THERE IS A COMPELLING NEED TO REMOVE THE REMAINING SEDIMENT (E.G. FOR SAFETY REASONS). IN SUCH CIRCUMSTANCES, ALL REASONABLE AND PRACTICABLE SEDIMENT CONTROL MEASURES SHALL BE USED TO PREVENT, OR AT LEAST MINIMISE, THE RELEASE OF SEDIMENT INTO THE RECEIVING WATERS. ONLY THOSE MEASURES THAT WILL NOT CAUSE SAFETY AND PROPERTY FLOODING ISSUES SHALL BE EMPLOYED. SEDIMENT REMOVED FROM ROADWAYS SHALL BE DISPOSED OF IN A LAWFUL MANNER THAT DOES NOT CAUSE ONGOING SOIL EROSION OR ENVIRONMENTAL HARM.
- SEDIMENT REMOVED FROM SEDIMENT TRAPS AND PLACES OF SEDIMENT DEPOSITIONS SHALL BE DISPOSED OF IN A LAWFUL MANNER THAT DOES NOT CAUSE ONGOING SOIL EROSION OR ENVIRONMENTAL HARM.

REVEGETATION/STABILISATION

- TEMPORARY STABILISATION MAY BE ATTAINED USING VEGETATION, NON WETTABLE SOIL POLYMERS, OR PNEUMATICALLY APPLIED EROSION CONTROLS.
- ALL CUT AND FILL EARTH BATTERS LESS THAN 3m IN ELEVATION SHALL BE TOPSOILED, AND GRASS SEEDED/HYDROMULCHED WITHIN 10 DAYS OF COMPLETION OF GRADING IN CONSULTATION WITH COUNCIL.
- AT THE COMPLETION OF FORMATION IN ANY SECTION, ALL DISTRIBUTED AREAS SHALL BE STABILISED IN ACCORDANCE WITH TIME LINES IN THE BLUE BOOK
- THE COUNCIL SEED MIX SHALL BE USED UNLESS STATED ON THE ESCP/SWMP.
- THE PH LEVEL OF TOPSOIL SHALL BE APPROPRIATE TO ENABLE ESTABLISHMENT AND GROWTH OF SPECIFIED VEGETATION PRIOR TO INITIATING THE ESTABLISHMENT OF VEGETATION.
- NON REWETTABLE BINDER SHALL BE USED IN ALL HYDROMULCH/HYDROSEED POLYMER MIXES ON SLOPES OR WORKS ADJACENT TO A WATER COURSE.
- SOIL AMELIORANTS SHALL BE ADDED TO THE SOIL IN ACCORDANCE WITH AN APPROVED LANDSCAPE PLAN, VEGETATION MANAGEMENT PLAN, AND/OR SOIL ANALYSIS.
- PROCEDURES FOR INITIATING A SITE SHUTDOWN, WHETHER PROGRAMMED OR UN-PROGRAMMED, SHALL INCORPORATE REVEGETATION OF ALL SOIL DISTURBANCES UNLESS OTHERWISE APPROVED BY COUNCIL. THE STABILISATION WORKS SHALL NOT RELY UPON THE LONGEVITY OF NON-VEGETATED EROSION CONTROL BLANKETS. OR TEMPORARY SOIL BINDERS.

SITE MONITORING AND MAINTENANCE

C) WITHIN 24 HOURS OF EXPECTED RAINFALL; AND

- THE APPLICANT SHALL ENSURE THAT APPROPRIATE PROCEDURES AND SUITABLY QUALIFIED PERSONNEL ARE ENGAGED TO PLAN AND CONDUCT SITE INSPECTIONS AND WATER QUALITY
- MONITORING THROUGHOUT THE CONSTRUCTION AND MAINTENANCE PHASE. ALL ESC MEASURES SHALL BE INSPECTED AND ANY MAINTENANCE UNDERTAKEN: A) AT LEAST DAILY (WHEN WORKS IS OCCURRING ON-SITE); AND B) AT LEAST WEEKLY (WHEN WORKS IS NOT OCCURRING ON-SITE) AND
- D) WITHIN 18 HOURS OF A RAINFALL EVENT THAT CAUSES RUNOFF ON THE SITE. WRITTEN RECORDS SHALL BE KEPT ONSITE OF ESC MONITORING AND MAINTENANCE ACTIVITIES CONDUCTED DURING THE CONSTRUCTION AND MAINTENANCE PERIODS, AND BE AVAILABLE TO COUNCIL OFFICERS ON REQUEST.
- ALL ENVIRONMENTAL RELEVANT INCIDENTS SHALL BE RECORDED IN A FIELD LOG THAT SHALL REMAIN ACCESSIBLE TO ALL RELEVANT REGULATORY AUTHORITIES.
- ALL WATER QUALITY DATA, INCLUDING DATES OF RAINFALL, DATES OF TESTING, TESTING RESULTS AND DATES OF WATER RELEASE, SHALL BE KEPT IN AN ON-SITE REGISTER. THE REGISTER IS TO BE MAINTAINED UP TO DATE FOR THE DURATION OF THE APPROVED WORKS AND BE AVAILABLE ON-SITE FOR INSPECTION BY ALL RELEVANT REGULATORY AUTHORITIES ON
- AT NOMINATED INSTREAM WATER MONITORING SITES, A MINIMUM OF 3 WATER SAMPLES SHALL BE TAKEN AND ANALYSED, AND THE AVERAGE RESULT USED TO DETERMINE QUALITY

STORMWATER NOTES

- THESE DRAWINGS ARE TO BE READ IN CONJUNCTION WITH RELEVANT ARCHITECTURAL
- ALL WORKS ARE TO BE IN ACCORDANCE WITH AS3500, COUNCIL'S DEVELOPMENT CONTROL PLAN AND PROPRIETARY MANUFACTURERS RECOMMENDATIONS.
- UNLESS OTHERWISE STATED, ALL STORMWATER PIPES (INCLUDING DOWNPIPES AND RAINWATER TANK OVERFLOW PIPES) ARE TO BE uPVC SEWER GRADE, U.N.O JOINTED & INSTALLED TO MANUFACTURERS RECOMMENDATIONS.
- ALL uPVC STORMWATER LINES TO HAVE ALL JOINTS, INC. DOWNPIPE CONNECTIONS, FULLY SOLVENT WELDED, INCLUDING ANY CHARGED LINES.
- CONNECT DOWNPIPES AS REQUIRED TO NOMINATED HARVESTING TANK IN ACCORDANCE WITH APPROVED DEVELOPMENT PLANS AND HYDRAULIC ENGINEERS DESIGN.
- ALL LEVELS ARE DATUM AHD.
- ALL LEVELS ARE FINISHED PAVEMENT OR LAWN LEVELS.
- CONTRACTOR TO ALLOW FOR ALL PIPE SUPPORT SYSTEM TO SOFFIT AS PER MANUFACTURERS
- ALL CONCRETE TO BE MANUFACTURED AND SUPPLIED IN ACCORDANCE WITH AS1379.
- AT COUNCILS DISCRETION, ALL CONCRETE CAN BE SUBJECT TO PROJECT ASSESSMENT AND **TESTING TO AS1379**
- MINIMUM PIPE COVERS TO BE IN ACCORDANCE WITH AS3500.
- PITS TO BE FILLED ACCORDINGLY TO MEET INVERTS AS NEEDED.
- CONTRACTOR TO CONFIRM ALL LEVELS PRIOR TO CONSTRUCTION. ANY DISCREPANCIES ARE TO BE IMMEDIATELY REPORTED TO WALLACE DESIGN GROUP

SUBSOIL DRAINAGE NOTES

- CONSTRUCTION SHALL BE IN ACCORDANCE WITH COUNCIL'S CONSTRUCTION SPECIFICATIONS FOR SUBSURFACE DRAINAGE.
- SUBSOIL PIPE TO BE Ø100 SLOTTED PVC OR CORRUGATED CIRCULAR PLASTIC PIPE AND ENCLOSED IN SEAMLESS FILTER FABRIC SOCK
- SUBSOIL DRAINS SHALL CONSIST OF A 300 (MINIMUM) WIDE TRENCH, BACKFILLED WITH 7 OR 10mm AGGREGATE AND WRAPPED IN BIDIM A12 GEOTEXTILE FABRIC OR SIMILAR. LAPPED AT THE TOP. DEPTH OF TRENCH TO EXTEND 450 (MINIMUM) IN ROCK OR 600 (MINIMUM) IN EARTH BELOW FINISHED SUB-GRADE LEVEL. INVERT OF TRENCH SHOULD ALSO BE LOWER THAN THE INVERT OF ANY SERVICE CROSSINGS.

ROAD/DRIVEWAY PAVEMENT NOTES

DRIVEWAY PAVEMENT TO BE CONSTRUCTED IN ACCORDANCE WITH NEWCASTLE COUNCIL STANDARD A1300.

RETAINING WALL NOTES

ALL RETAINING WALLS SHOWN ON THESE PLANS SHALL BE DESIGNED BY A REGISTERED PROFESSIONAL STRUCTURAL ENGINEERING AT TIME OF CONSTRUCTION CERTIFICATE STAGE

AutoCAD Civil 3D 2021

RAWING MUST NOT BE REPRODUCED IN A WING HAS BEEN PRODUCED FOR SIGN INTENT AND SCOPE OF WORL QUIRED FOR THE INSTALLATION OF SERVICES DETAILED, AND PERTAINED WITHIN TH CIFICATION AND SHOULD BE READ CIFICATION, ASSOCIATED SPECIFICAT DDES AND STANDARDS. ALL DIMENSIC VELS AND EXISTING SERVICES SHALI STIGATED AND CONFIRMED ON SITE BY

HIS DRAWING IS NOT APPROVED FOR CONSTRUCTION UNLESS ENDORS 30.08.22 S.S. B DEVELOPMENT APPLICATION ISSUE A PRELIMINARY ISSUE 01.07.22 S.S. APPV'D DESCRIPTION DATE ENDO'D



MAHDI ASHURI




WALLACE INFRASTRUCTURE **DESIGN PTY LTD** PART OF WALLACE DESIGN GROUP PTY LTD

9 WILLIAM STREET PO BOX 850, WARNERS BAY, NSW 2282 MAYFIELD NSW 2304 phone: (02) 49 294 109

CIVIL WORKS for LOT 63 SEC B DP 192768

DRAWING TITLE: CIVIL SERVICES **GENERAL NOTES**

DRAWING STATUS DA APPROVAL ORIG. SIZE SCALE: N.T.S. A1 APPROVED ENDORSED DATE DRAWN DESIGNED CHECKED SS ΚB SS 30.08.22 PROJECT No. 22215 C02.01

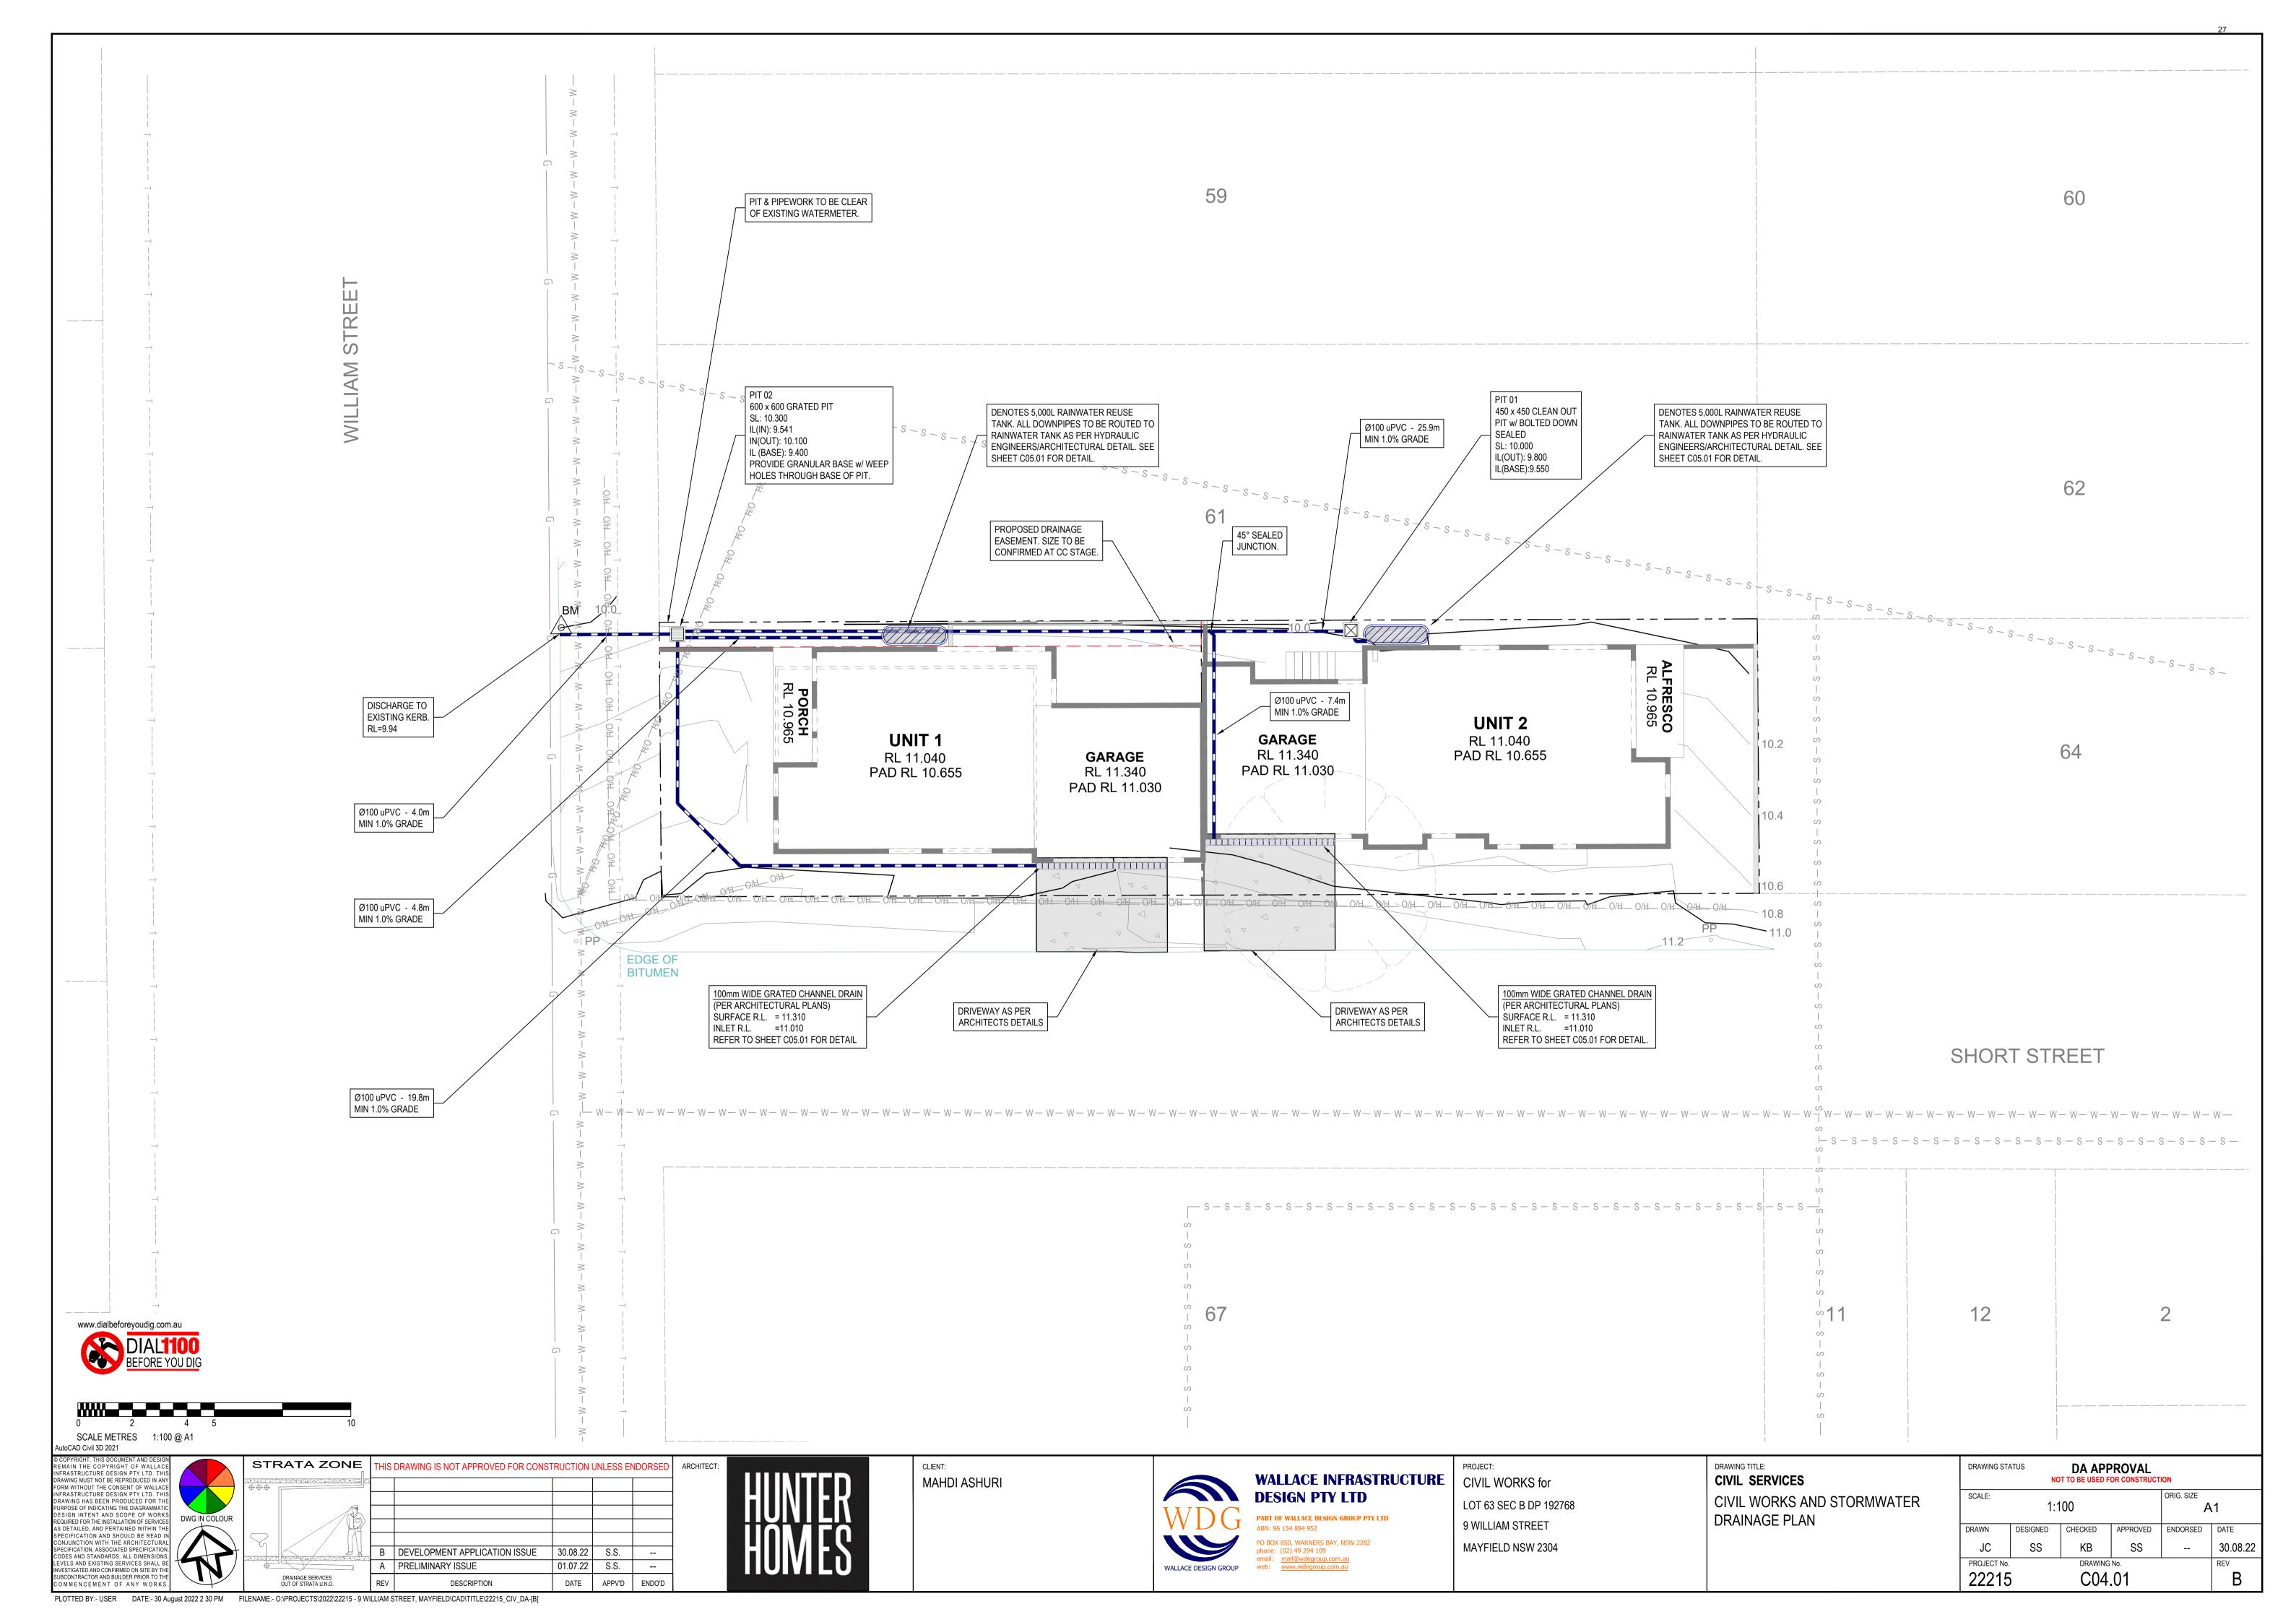

GENERAL RAINWATER TANK NOTES:

- ALL UNITS ARE TO BE CONNECTED TO THE SPECIFIED RAINWATER REUSE/STORAGE TANK AS NOTED ON THE STORMWATER DRAINAGE PLAN SHEET.
- DAVEY RAINBANK MAINS SWITCHOVER (OR EQUIVALENT) AND RAINWATER TANK TO BE INSTALLED PER MANUFACTURERS SPECIFICATIONS.
- VOLUMES SHOWN FOR REUSE ARE PROVIDED TO COMPLY WITH MINIMUM SIZE REQUIREMENTS PER COUNCIL GUIDELINES AND DO NOT INCLUDE THE PERMANENT VOLUME REQUIRED FOR OPERATION OF THE PUMP.

DETENTION FOR SMALL SITES CITY OF NEWCASTLE COUNCIL

TOTAL SITE AREA

285 m² (in accordance with AS3500 Part 3) TOTAL IMPERVIOUS AREA OTHER IMPERVIOUS AREA 9 m² (pavement + other site concrete areas) % IMPERVIOUS AREA 73 % (assumed per Council Guidelines)

NCC STORAGE REQUIREMENTS PER Newcaste DCP Section 7.06

Site of Less than 50% Impervious Cover, 12mm of storage of site area Site between 50% an 100% Impervious Cover, by linear interpolation of storage depth

Site of 100% Impervious Cover, 25mm of storage of site area


SITE DISCHARGE CONTROLS

OSD STORAGE REQUIREMENTS PER 7.06 DCP

TOTAL IMPERVIOUS AREA 294 m² (Effective roof area plus other impervious area) 17.9 mm STORAGE DEPTH REQUIRED


5.2 m³ VOLUME REQUIRED

 $6.0 \,\mathrm{m}^3$ (2 tanks at 3kL per unit) RWT VOL PROVIDED

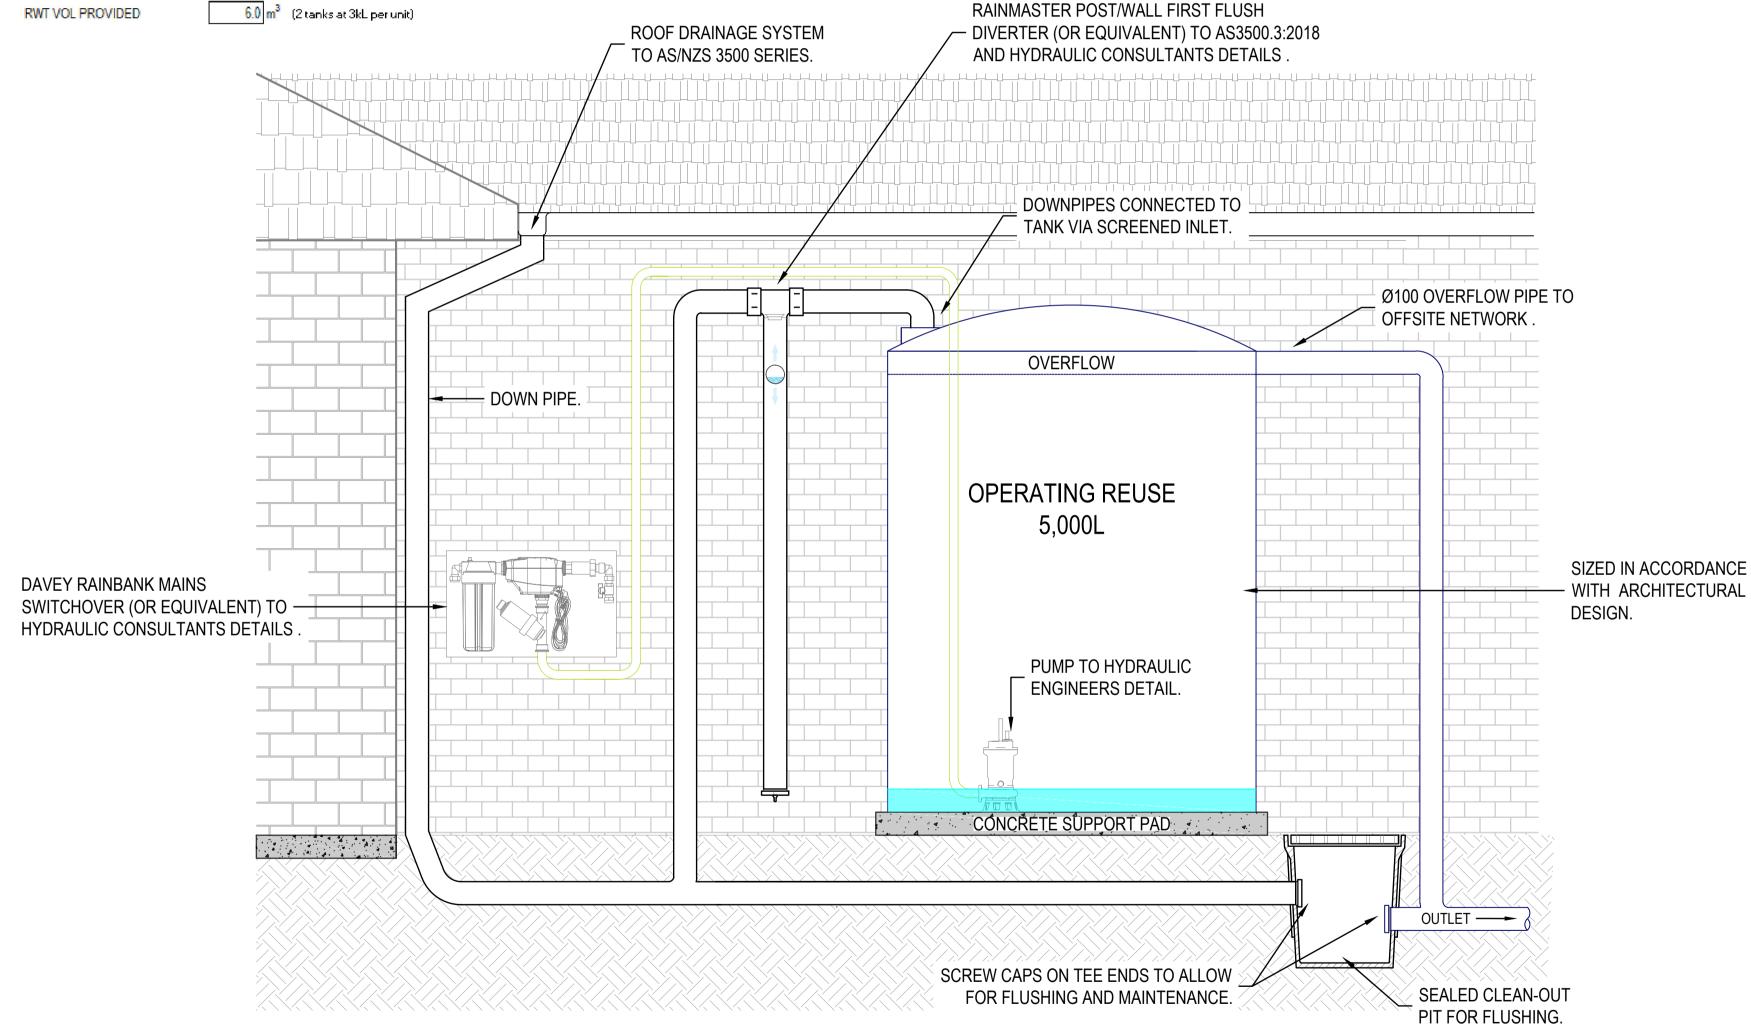


TYPICAL DETAIL


RAINWATER REUSE TANK

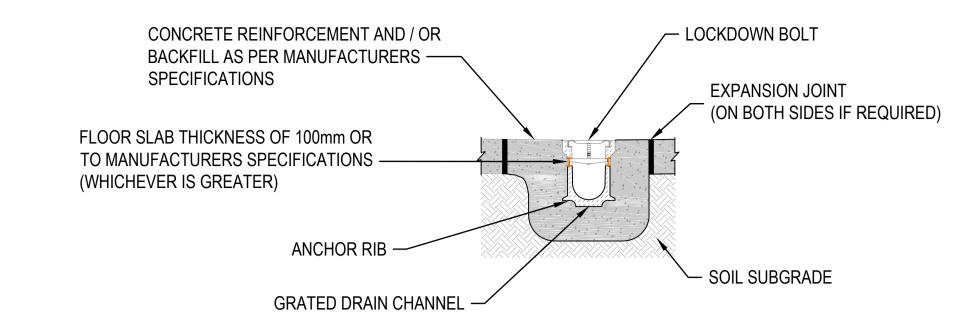

TYPICAL SECTION GRATED DRAIN (CONCRETE SURROUNDS) NOT TO SCALE

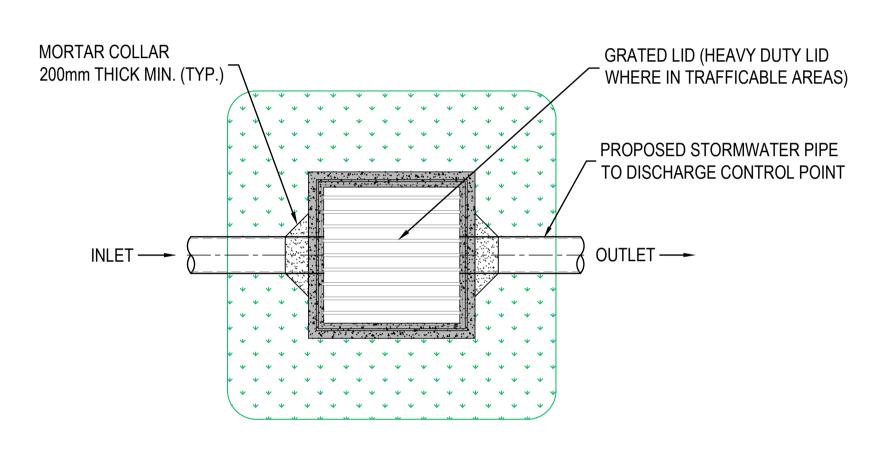

PLAN STORMWATER DRAINAGE PIT

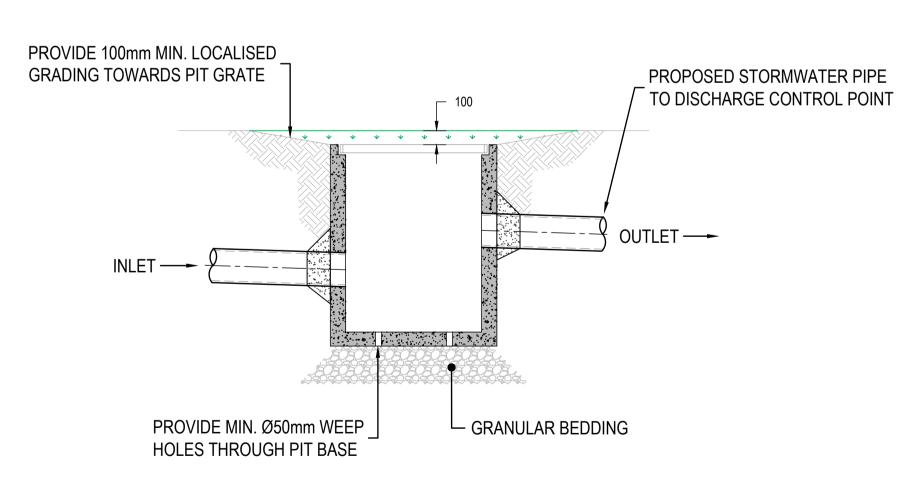

SECTION STORMWATER DRAINAGE PIT (WITH 300mm SUMP)



www.dialbeforeyoudig.com.au

SCALE METRES 1:25 @ A1

RAWING MUST NOT BE REPRODUCED IN AN

AWING HAS BEEN PRODUCED FOR TI

SIGN INTENT AND SCOPE OF WORKS

QUIRED FOR THE INSTALLATION OF SERVICES DETAILED, AND PERTAINED WITHIN THE

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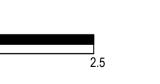
CIFICATION, ASSOCIATED SPECIFICATION

STIGATED AND CONFIRMED ON SITE BY TH

OMMENCEMENT OF ANY WORKS

ODES AND STANDARDS. ALL DIMENSION EVELS AND EXISTING SERVICES SHALL E

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HIS DRAWING IS NOT APPROVED FOR CONSTRUCTION UNLESS ENDORS B DEVELOPMENT APPLICATION ISSUE 30.08.22 S.S. A PRELIMINARY ISSUE 01.07.22 S.S. DATE APPV'D ENDO'D



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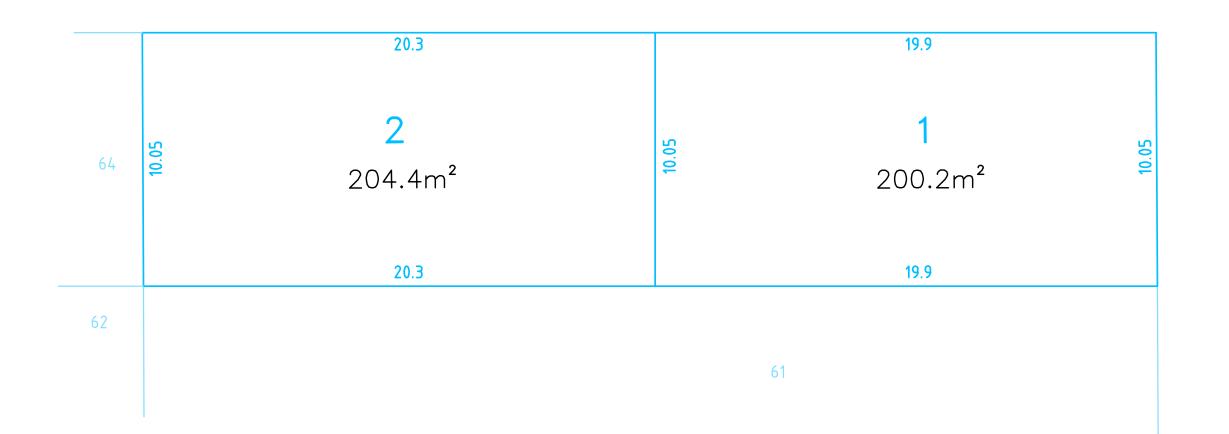
CIVIL WORKS for LOT 63 SEC B DP 192768 9 WILLIAM STREET MAYFIELD NSW 2304

DRAWING TITLE: **CIVIL SERVICES** TYPICAL SECTIONS AND DETAILS

DRAWING STATUS DA APPROVAL ORIG. SIZE SCALE: AS SHOWN Α1 APPROVED ENDORSED DATE DRAWN DESIGNED CHECKED SS ΚB 30.08.22 JC PROJECT No. 22215 C05.07

SHORT STREET





NOTE:
FINAL BEARINGS, DIMENSIONS AND AREAS ARE SUBJECT TO FINAL SURVEY.

ш0	1.0	2.0	3.0	4.0	2.0			10.0	15.0m
						SCALE	1 : 150		

	REV	DETAILS & AMENDMENTS	DATE	PLAN OF PROPOSED SU	BDIVISION	17
	В	AMENDED PLAN	18/05/2022	ADDRESS:	CLIENT:	
	C	AMENDED PLAN	24/08/2022	9 WILLIAM STREET, MAYFIELD	HUNTER HOMES - 0009WILL	
	D	AMENDED PLAN	30/08/2022	TITLE DETAILS: LOT 63 OF SEC B IN DP192768		Em
\ 		REF No: B2176SUB-D SHEET 1 OF 1	А3	DATUM: SOURCE: N/A N/A	PARKER SCANLON CONTACT: SURVEYED/DRAWN/CHECKED: LISA BLANDFORD/JM/LB	LII

7 William Street HAMILTON NSW 2303 PO Box 986 HAMILTON NSW 2303 Ph: 4969 6995 www.parkerscanlon.com.au mail: surveys@parkerscanlon.com.au ABN 36124 624 022



ATTACHMENTS DISTRIBUTED UNDER SEPARATE COVER

DAC 15/12/2022 – 9 WILLIAM STREET MAYFIELD – DA2022/00532 - DUAL OCCUPANCY - INCLUDING DEMOLITION OF EXISTING STRUCTURES

ITEM-21 Attachment B: Draft Schedule of Conditions

DRAFT SCHEDULE OF CONDITIONS



Application No: DA2022/00532

Land: Lot 63 Sec B DP 192768

Property Address: 9 William Street Mayfield NSW 2304

Proposed Development: Dual occupancy - including demolition of existing structures

SCHEDULE 1

Approved Documentation

 The development is to be implemented in accordance with the plans and supporting documents set out in the following table except where modified by any conditions of this consent.

Plan No / Supporting	Reference / Version	Prepared by	Dated	
Document				
Landscape Plan	WD03 Issue 8	Hunter Homes	12/10/22	
Site Plan	WD04 Issue 8	Hunter Homes	12/10/22	
Demolition Plan	WD05 Issue 8	Hunter Homes	12/10/22	
Unit 1	WD09 - 14 Issue 8	Hunter Homes	12/10/22	
Unit 2	WD15 – 20 Issue 8	Hunter Homes	12/10/22	
Civil Works and	C01.01, 02.01, 04.01,	Wallace Infrastructure	30/08/22	
Stormwater Plan	05.01 Rev B	Design		
Draft Plan of Subdivision	Sheet 1 Rev D	Parker Scanlon	30/08/22	
BASIX	1273764M_02	Building Sustainability Assessments	16/05/22	

In the event of any inconsistency between conditions of this development consent and the plans/supporting documents referred to above, the conditions of this development consent prevail.

CONDITIONS TO BE SATISFIED PRIOR TO THE ISSUE OF A CONSTRUCTION CERTIFICATE

- 2. The car parking and vehicular access are to be designed to comply with the relevant provisions of AS/NZS 2890 Parking facilities. Details are to be included in documentation for a Construction Certificate application.
- 3. All proposed driveways, parking bays, loading bays and vehicular turning areas are to be constructed with a basecourse of a depth to suit design traffic and be sealed with either bitumen seal, asphaltic concrete, concrete or interlocking pavers. Details are to be included in documentation for a Construction Certificate application.
- 4. Two street trees are required to be planted. A fee, to be determined by contacting Council's City Greening Services, is to be paid to CN for the required compensatory planting and evidence of the payment of the required fee is to be included in the

documentation for a Construction Certificate application.

NOTE: The tree selection and location of the required compensatory tree will be determined by CN's City Greening Section in accordance with Newcastle City Council Street Tree selection manual. The location of the compensatory tree planting may not be in the immediate proximity of the site.

5. In accordance with the City of Newcastle Section 7.11 Development Contributions Plan 2021-2036 (the Plan), the following monetary contributions shall be paid to the City of Newcastle to cater for the increased demand for transport and social infrastructure resulting from the development:

Description	Contribution (\$)
Transport	\$3009.86
Open Space and Recreation	\$12934.01
Community Facilities	\$2392.69
Plan Preparation and Administration	\$457.75
TOTAL	\$18794.31

If the contributions are not paid within the financial quarter that this consent is granted, the contributions payable will be adjusted in accordance with the provisions of the Plan and the amount payable will be calculated on the basis of the contribution rates applicable at the time of payment

The contributions shall be paid to the City of Newcastle:

- (i) prior to the issue of the Subdivision Certificate where the development is for subdivision; or
- (ii) prior to the issue of the first Construction Certificate where the development is for building work; or
- (iii) prior to issue of the Subdivision Certificate or first Construction Certificate, whichever occurs first, where the development involves both subdivision and building work: or
- (iv) prior to the works commencing where the development does not require a Construction Certificate or Subdivision Certificate.
- 6. Roof water from the proposed new work is to be directed to the proposed water tank with a minimum capacity of 4000-litres and being reticulated to any new toilet cisterns and cold water washing machine taps, with a mains water top up being installed to maintain between 10% and 15% of the tank capacity. Alternatively, an electronically activated mechanical valve device is to be installed to switch any new toilet cisterns and laundry taps to mains water when the tank falls below 10% capacity. The water tank and plumbing is to be designed in accordance with the Plumbing Code of Australia (National Construction Code Volume 3). Full details are to be included in documentation for a Construction Certificate application.
- 7. All proposed planting and landscape elements indicated on the submitted landscape concept plan or otherwise required by the conditions of this consent are to be detailed on a comprehensive landscape plan and specification. The plan and specification are to be prepared in accordance with the provisions of Newcastle Development Control Plan 2012 and is to include details of the following:
 - a) cross sections through the site
 - b) proposed contours or spot levels
 - c) botanical names
 - d) quantities and container size of all proposed trees

- e) shrubs and ground cover
- f) details of proposed soil preparation
- g) mulching and staking
- h) treatment of external surfaces and retaining walls where proposed
- i) drainage, location of taps and
- j) maintenance periods.

The plan and specification are to be prepared by a qualified landscape designer and be included in documentation for a Construction Certificate application.

- 8. The applicant is to comply with all of Hunter Water's requirements to provide your development with water supply and sewerage services. A copy of Hunter Water's compliance certificate (*Hunter Water Act 1991* Section 50) must be submitted with your Construction Certificate application.
- 9. Facilities are to be provided within the proposed individual private courtyards, or in another screened location, for the storage of garbage. Full details are to be included in documentation for a Construction Certificate application.
- 10. Erosion and sediment control measures are to be implemented prior to the commencement of works and be maintained during the period of construction in accordance with the details set out on an Erosion and Sediment Control Plan that is to be submitted for approval with the Construction Certificate application. Controls are not to be removed until the site is stable with all bare areas supporting an established vegetative cover.
- 11. A separate application is to be lodged and consent obtained from the City of Newcastle for all works within the road reserve pursuant to Section 138 of the *Roads Act 1993*. The consent is to be obtained, or other satisfactory arrangements confirmed in writing from the City of Newcastle, before the issue of a Construction Certificate.
- 12. All stormwater runoff from the proposed development is to be managed in accordance with the requirements of Section 7.06 'Stormwater' of Newcastle Development Control Plan 2012, the associated Technical Manual and AS/NZS 3500.3 Plumbing and drainage Part 3 Stormwater drainage, as indicated on the stormwater management concept plan prepared by Wallace Infrastructure Design (Drg. No. C04.01, dated 30/08/22). Details are to be included in documentation for a Construction Certificate application.

CONDITIONS TO BE SATISFIED PRIOR TO THE COMMENCEMENT OF WORK AND DURING THE CONSTRUCTION PHASE

- 13. A residential vehicular crossing is to be constructed across the road reserve, in accordance with the following criteria:
 - a) Constructed in accordance with City of Newcastle's A1300 Driveway Crossings Standard Design Details.
 - b) The driveway crossing, within the road reserve, is to be a maximum of 5m wide, per dwelling.
 - c) Letterboxes, landscaping and any other obstructions to visibility are to be kept clear of or limited in height to 1.2m, in the 2.0m by 2.5m splay within the property boundary, each side of the driveway entrance.

- d) The proposed driveway is to be a minimum of 3.0m clear of the trunk of any tree within the road reserve.
- e) The proposed driveway is to be a minimum of 750mm clear of the centre of any pole or obstruction within the road reserve and 1.0m clear of any drainage pit.

These works are not approved until consent under Section 138 of the *Roads Act 1993* has been granted by the City of Newcastle.

- 14. During construction works, an assessment of acid sulfate soil potential is to be undertaken in the area of excavation. If acid sulfate soils are found to be present, soils are to be treated in accordance with the New South Wales Acid Sulfate Soil Management Advisory Committee's 'Acid Sulfate Soil Manual'.
- 15. Toilet facilities are to be available or provided at the work site before works begin and be maintained until the works are completed, at a ratio of one toilet plus one additional toilet for every 20 persons employed at the site.

Each toilet is to:

- a) Be a standard flushing toilet connected to a public sewer, or
- b) Have an on-site effluent disposal system approved under the *Local Government Act 1993*, or
- c) Be a temporary chemical closet approved under the Local Government Act 1993.
- 16. Building demolition is to be planned and carried out in accordance with *Australian Standard* 2601:2001 The Demolition of Structures.
- 17. A Hazardous Substances Management Plan is to be prepared by a competent person for the building(s) or parts of the building(s) proposed to be demolished in accordance with *Australian Standard 2601:2001 The Demolition of Structures*. A copy of the Hazardous Substances Management Plan is to be provided to the Council and to the demolisher prior to commencement of work.
- 18. The demolition works are to be undertaken in accordance with Australian Standard 2601:2001 The Demolition of Structures and the following requirements:
 - a) prior to commencement of demolition works a competent person shall determine the presence of hazardous substances impacted by the proposed demolition works in accordance with Section 1.6.1 of AS2601:2001 and where required produce a Hazardous Substances Management Plan
 - b) demolition works shall be conducted in accordance with any required Hazardous Substances Management Plan. A copy of the Plan shall be kept on-site for the duration of the proposed development and a copy is to be held in the possession of the landowner
 - c) the removal, handling and disposal of any asbestos material is to be undertaken only by an asbestos removal contractor who holds the appropriate class of Asbestos Licence, issued by the WorkCover Authority of NSW
 - d) a copy of all waste disposal receipts are to be kept in the possession of the landowner and made available to authorised Council Officers upon request
 - e) seven working days notice in writing is to be given to the owners/occupiers of neighbouring premises prior to the commencement of any demolition works. Such written notice is to include the date demolition will commence and details of the

name, address, contact telephone number(s) and licence details (type of licences held and licence numbers) of any asbestos removal contractor and demolition contractor, and

- f) on sites where asbestos materials are to be removed, a standard commercially manufactured sign containing the words 'DANGER ASBESTOS REMOVAL IN PROGRESS' measuring not less than 400mm x 300mm is to be erected in a prominent position during asbestos removal works.
- 19. The demolisher is to ensure that all services (ie water, telecommunications, gas, electricity, sewerage etc), are disconnected in accordance with the relevant authority's requirements prior to demolition.
- 20. Any waste containers used in association with the proposed demolition are to be located on the site where possible.

Note: Where this is not feasible, an application is to be made for the approval to position the container on the adjacent public road in accordance with the Council's adopted Building Waste Container Policy.

21. All demolition material incapable of being re-used in future redevelopment of the site is to be removed from the site and the site being cleared and levelled.

Note: Where reusable building materials are to be stored on site for use in future building works, such materials are to be neatly stacked at least 150 mm above the ground.

- 22. The demolisher is to ensure that all demolition material is kept clear of the public footway and carriageway as well as adjoining premises.
- 23. At a minimum, the following measures are to be implemented during the construction phase:
 - A waste container of at least one cubic metre capacity is to be provided, maintained and regularly serviced from the commencement of operations until the completion of the building, for the reception and storage of waste generated by the construction of the building and associated waste;
 - b) The waste container is to be, at minimum, constructed with a 'star' picket (corners) and weed control mat (sides), or equivalent. The matting is to be securely tied to the pickets;
 - c) Provision is to be made to prevent windblown rubbish leaving the site; and
 - d) Footpaths, road reserves and public reserves are to be maintained clear of rubbish, building materials and all other items.

Note: Fines may be issued for pollution/littering offences under the *Protection of the Environment Operations Act 1997*.

- 24. A rigid and durable sign is to be erected in a prominent position on any site on which building work, subdivision work or demolition work is being carried out, before the commencement of the work:
 - a) showing the name, address and telephone number of the Principal Certifier for building work and subdivision work, and
 - b) showing the name, address and telephone number of the Principal Contractor, if any, for any building work and a telephone number on which the Principal Contractor may be contacted at any time for business purposes, and

- c) stating that unauthorised entry to the work site is prohibited, and
- d) being erected in a prominent position that can be read easily by anyone in any public road or other public place adjacent to the site.

Any such sign is to be maintained while the building work, subdivision work or demolition work is being carried out, and must be removed when the work has been completed.

Note: This does not apply in relation to building work, subdivision work or demolition work carried out inside an existing building, if the work does not affect the external walls of the building, or Crown building work certified to comply with the Building Code of Australia under the Act, Part 6.

- 25. All excavations and backfilling are to be executed safely and excavations are to be properly guarded and protected to prevent them from being dangerous to life and property.
- 26. All building materials, plant and equipment is to be placed on the site of the development, to ensure that pedestrian and vehicular access in public places is not restricted and to prevent damage to the road reserve. The storage of building materials on Council reserves, including the road reserve, is not permitted.
- 27. Any alteration to natural surface levels on the site is to be undertaken in such a manner as to ensure that there is no increase in surface water runoff to adjoining properties or that runoff is impounded on adjoining properties, as a result of the development.
- 28. Construction/demolition work that generates noise that is audible at residential premises is to be restricted to the following times:
 - Monday to Friday, 7:00 am to 6:00 pm and
 - Saturday, 8:00 am to 1:00 pm.

No noise from construction/demolition work is to be generated on Sundays or public holidays.

29. Council's 'Prevent Pollution' sign is to be erected and maintained in a conspicuous location on or adjacent to the property boundary, so it is clearly visible to the public, or at other locations on the site as otherwise directed by Council, for the duration of demolition and construction work.

The sign can be obtained by presenting your development application receipt at City of Newcastle's Customer Enquiry Centre, Wallsend Library or the Master Builders Association Newcastle.

- 30. Erosion and sediment control measures are to be implemented prior to the commencement of works and maintained during the period of demolition and/or construction in accordance with the requirements of Managing Urban Stormwater: Soils and Construction 4th Edition Vol. 1 (the 'Blue Book') published by Landcom, 2004. Controls are not to be removed until the site is stable with all bare areas supporting an established vegetative cover.
- 31. Where the proposed development involves the destruction or disturbance of any survey monuments, those monuments affected are to be relocated, at no cost to the City of Newcastle, by a Surveyor registered under the *Surveying and Spatial Information Act* 2002.
- 32. All public trees that are required to be retained are to be protected in accordance with the City of Newcastle *Urban Forest Technical Manual*, Part B *Public Trees*.

The tree protection fencing is to remain in place and be maintained until all works have been completed, with no waste materials, washouts, equipment or machinery to be stored within the fenced area.

- 33. Building work must be carried out in accordance with the requirements of the Building Code of Australia./
- 34. In the case of residential building work for which the Home Building Act 1989 requires there to be a contract of insurance in force in accordance with Part 6 of that Act, that such a contract of insurance is in force before any building work authorised to be carried out by the consent commences.
- 35. If the soil conditions require it, retaining walls associated with the erection or demolition of a building or other approved methods of preventing movement of the soil are to be provided.
- 36. All roof and surface waters are to be conveyed to the street gutter by way of a sealed pipe system, extending through the footway to Council's requirements, with provision of an easement to drain water minimum 0.9m wide over Lot 1 to benefit Lot 2, in accordance with Section 7.06 'Stormwater' of Newcastle Development Control Plan 2012.
- 37. Prior to the commencement of work, a 3.0m wide all-weather vehicle access is to be provided from the kerb and gutter to the building under construction, to reduce the potential for soil erosion. Sand or soil is not to be stockpiled on the all-weather vehicle access.
- 38. All necessary measures are to be undertaken to control dust pollution from the site. These measures are to include, but are not limited to:
 - a) Restricting topsoil removal;
 - b) Regularly and lightly watering dust prone areas (note: prevent excess watering as it can cause damage and erosion);
 - c) Alter or cease construction work during periods of high wind; and erect green or black shadecloth mesh or similar products 1.8m high around the perimeter of the site and around every level of the building under construction.

CONDITIONS TO BE SATISFIED PRIOR TO THE ISSUE OF AN OCCUPATION CERTIFICATE, A SUBDIVISION CERTIFICATE OR A STRATA CERTIFICATE

- 39. Any redundant existing vehicular crossing is to be removed at no cost to the City of Newcastle. The road reserve and kerb is to be restored to the City of Newcastle's satisfaction. Works are to be completed prior to the issuing of an Occupation Certificate for the proposed development.
- 40. The water management measures as indicated on the submitted plans and Statement of Environmental Effects and/or as modified under the terms of this consent are to be implemented and the nominated fixtures and appliances are to be installed and operational prior to issue of an Occupation Certificate.
- 41. All public footways, footpaving, kerbs, gutters and road pavement damaged during the works are to be immediately repaired following the damage, to a condition that provides for safe use by pedestrians and vehicles. Full restoration of the damage is to be carried out to City of Newcastle's satisfaction prior to the completion of demolition work or prior to the issue of any Occupation Certificate in respect of development involving building work.

- 42. All commitments listed in the relevant BASIX certificate for:
 - a) BASIX development,
 - b) BASIX optional development, if the development application was accompanied by a BASIX certificate,

are to be satisfactorily completed prior to the issue of an Occupation Certificate.

Should there be any changes to the specifications of the dwelling that have implications for compliance with the approved certificate, except where restricted or excluded by any other condition of consent, an amended BASIX Certificate can be relied upon as having complied with this condition. A copy of any amended BASIX Certificate is to be provided to the Newcastle City Council with Occupation Certificate documentation.

- 43. All works within the road reserve required by this consent are to be completed prior to the issue of an Occupation Certificate.
- 44. A Landscape Practical Completion Report is to be submitted to the Principal Certifier prior to the issue of an Occupation Certificate. The report is to verify that all landscape works have been carried out in accordance with the comprehensive landscape design plan and specifications that were required to be included in documentation for a Construction Certificate application and is to verify that an effective maintenance program has been commenced.
- 45. The premises are to be identified by the provision of house numbers on the building exterior and mailbox such that they are clearly visible from the road frontage.

The minimum numeral height is to be 75mm.

- 46. An application is to be made for a Subdivision Certificate. The application is to be supported by a digital copy (pdf format) of the survey plan of subdivision, associated administration sheets and a Section 50 Certificate from the Hunter Water Corporation.
- 47. An easement for drainage is to be created, a minimum 0.9m wide over Lot 1 to benefit Lot 2 is to be created prior to the issue of an Occupation Certificate for the proposed development.

Note: All associated survey and legal work is to be undertaken by the developer at the developer's expense.

- 48. An instrument under Section 88B of the *Conveyancing Act 1919*, setting out the terms of easements as required by this consent, along with related notations on the plan of subdivision, are to be submitted to the City of Newcastle for certification. The City of Newcastle is to be identified as a party whose consent is required to release, vary or modify easements.
- 49. The approved dual occupancy development on the site is to be completed to at least lock-up stage prior to the issue of the Subdivision Certificate.

Lock-up stage is taken to mean the stage at which a building's external wall cladding and roof covering is fixed, and external doors and windows are fixed (even if those doors and windows are only temporary).

CONDITIONS TO BE SATISFIED DURING THE OPERATION AND USE THE DEVELOPMENT

50. The premise/s is/are allocated the following street address/es in accordance with City of Newcastle's *House Numbering Policy* and the *Surveying and Spatial Regulation*.

ADDRESS SCHEDULE

Unit/ Dwelling/ Lot	Council Allocated Street Addresses				
Number on plan	House Number	Street Name	Street Type	Suburb	
Unit 1	9	William	Street	Mayfield	
Unit 2	9A	William	Street	Mayfield	

ADVISORY MATTERS

- It is recommended that, prior to commencement of work, the free national community service 'Dial before you Dig' be contacted on 1100 or by fax on 1200 652 077 regarding the location of underground services in order to prevent injury, personal liability and even death. Inquiries should provide the property details and the nearest cross street/road.
- Any necessary alterations to public utility installations are to be at the developer/demolisher's expense and to the requirements of the City of Newcastle and any other relevant authorities. City of Newcastle and other service authorities should be contacted for specific requirements prior to the commencement of any works.
- It is an offence under the provisions of the *Protection of the Environment Operations Act* 1997 to act in a manner causing, or likely to cause, harm to the environment. Anyone allowing material to enter a waterway or leaving material where it can be washed off-site may be subject to a penalty infringement notice (i.e. 'on-the-spot fine') or prosecution.
- Failure to comply with the conditions of consent constitutes a breach of the Environmental Planning and Assessment Act 1979, which may be subject to a penalty infringement notice (i.e. 'on-the-spot fine') or prosecution.
- Retaining walls not clearly noted on the approved plans or outside of the parameters of 'exempt development', as specified in State Environmental Planning Policy (Exempt and Complying Development Codes) 2008, are to be subject to a separate development application. An application in this regard is to be approved prior to any works relating to such a retaining wall taking place.
- An application is to be submitted to the City of Newcastle for the removal or pruning of any trees located more than three metres from the dwelling wall, measured from the centre of the trunk to the footings of the dwelling, excluding carports and pergolas.
- Any approval for fences on side boundaries, common to other private properties, is independent of any consent or agreement which may be required from any adjoining owner under the provisions of the *Dividing Fences Act 1991*.
- Prior to commencing any building works, the following provisions of Division 6.2 of the Environmental Planning and Assessment Act 1979 are to be complied with:
 - a) A Construction Certificate is to be obtained; and
 - b) A Principal Certifier is to be appointed for the building works and Newcastle City Council is to be notified of the appointment; and
 - c) Newcastle City Council is to be given at least two days notice of the date intended for commencement of building works.
- Prior to the occupation or use of a new building, or occupation or use of an altered portion of, or an extension to an existing building, an Occupation Certificate is to be obtained from the Principal Certifier appointed for the proposed development. An application for an Occupation Certificate must contain the information set out in Section

37 of the Environmental Planning and Assessment (Development Certification and Fire Safety) Regulation 2021 (NSW).

END OF CONDITIONS

SCHEDULE 2

REASONS FOR THE DETERMINATION & CONSIDERATION OF COMMUNITY VIEWS

The determination decision was reached for the following reasons:

- The proposed development, subject to the recommended conditions, is consistent with the objectives of the applicable environmental planning instruments, being *Newcastle Local Environmental Plan 2012* (NLEP) and applicable State Environmental Planning Policies.
- The proposed development is, subject to the recommended conditions, consistent with the objectives of the Newcastle Development Control Plan 2012 (NDCP).
- The proposed development is considered to be of an appropriate scale and form for the site and the character of the locality.
- The proposed development has appropriate management and mitigation of impacts through conditions of consent.
- The proposed development, subject to the recommended conditions, will not result in unacceptable adverse impacts upon the natural or built environments.
- The proposed development is a suitable and planned use of the site, and its approval is within the public interest.
- Newcastle City Council has considered and accepted the proposed development standard variation made under Clause 4.6 of the Newcastle Local Environmental Plan 2012. The proposed 12.6% variation is considered acceptable in the particular circumstances of this case as the variation is relates to the provision of additional car parking and will not significantly impact upon neighbouring properties.

REASONS WHY THE CONDITIONS HAVE BEEN IMPOSED

The following conditions are applied to:

- Confirm and clarify the terms of Council's determination;
- Identify modifications and additional requirements that will result in improved compliance, development and environmental outcomes;
- Prevent, minimise, and/or offset adverse environmental impacts including economic and social impacts;
- Set standards and measures for acceptable environmental performance; and
- Provide for the ongoing management of the development.

ATTACHMENTS DISTRIBUTED UNDER SEPARATE COVER

DAC 15/12/2022 – 9 WILLIAM STREET MAYFIELD – DA2022/00532 - DUAL OCCUPANCY - INCLUDING DEMOLITION OF EXISTING STRUCTURES

ITEM-21 Attachment C: Processing Chronology

THE CITY OF NEWCASTLE Report to Development Applications Committee Meeting on 15 November 2022



PROCESSING CHRONOLOGY

DA2022/00532 - 9 William Street Mayfield

05 May 2022	-	Application lodged
27 May - 10 June 2022	-	Application notified in accordance with CN's Community Participation Plan (CPP)
06 June 2022		External referrals commenced: Ausgrid
13 July 2022	-	Request for additional information issued
31 August 2022	-	Additional information received from applicant
12 October 2022	-	Further additional information received from applicant