# **DEVELOPMENT APPLICATIONS COMMITTEE MEETING**

9 April 2019

# ATTACHMENTS DISTRIBUTED UNDER SEPARATE COVER

# **REPORTS BY COUNCIL OFFICERS**

Attachment A - Plans DA2018/00948 - 25 Marshall Street New Lambton

Heights

Demolition of dwelling, erection of four two storey

dwellings

**DISTRIBUTED UNDER SEPARATE COVER** 

# DEVELOPMENT APPLICATION

MULTI DWELLING HOUSING 25 MARSHALL STREET, NEW LAMBTON HEIGHTS



VIEW FROM MARSHALL STREET

# Schedule of Drawings

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DA000	COVER PAGE
DA001	PERSPECTIVES
DA002	SITE ANALYSIS PLAN
DA003	SITE PLAN
DA004	SITE COVERAGE PLAN
DA005	SHADOW DIAGRAMS
DA006	DEMOLITION PLAN
DA008	NEIGHBOUR SHADOW ANALYSIS
DA009	POSSIBLE SUBDIVISION
DA010	BUSHFIRE BAL OVERLAY PLAN
DA100	OVERALL PLANS
DA101	GROUND FLOOR - UNITS 1-2
DA102	GROUND FLOOR - UNITS 3-4
DA103	FIRST FLOOR - UNITS 1-2
DA104	FIRST FLOOR - UNITS 3-4
DA105	ROOF PLAN
DA300	ELEVATIONS
DA301	ELEVATIONS
DA303	ELEVATIONS FOR BASIX
DA304	ELEVATIONS FOR BASIX
DA350	EXTERNAL FINISHES
DA400	SECTIONS
DA401	SECTIONS
DA900	SEDIMENT CONTROL



SITE LOCATION



**SUBJECT SITE** 

Survey By A. McLeod Reference: 4381A 13/11/2017

FOR AUTHORITY APPROVAL ONLY NOT FOR CONSTRUCTION





VIEW FROM MARSHALL STREET



AERIAL VIEW FROM MARSHALL STREET



VIEW FROM NORTH BOUNDARY



VIEW OF UNIT 3 FROM NORTH BOUNDARY



VIEW FROM NORTH



AERIAL VIEW UP DRIVWAY



VIEW FROM SOUTH WEST CORNER



AERIAL VIEW OF UNIT 1 FRONT FACADE



VIEW OF UNIT 4 REAR YARD

PO Box 601 Kotara NSW 2289 Ph 49524425 Nominated Architect: Daniel Hadley 8209

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Issue
P1
P2
P3
P4
A
B

ue Description

Consultant Coordination
Hunter Water + Mines Issue
Coordination
Coordination
Development Application
RFI Amendments

Date

17-04-18
30-07-18
02-08-18
20-08-18
27-08-18
12-02-19

Multi Dwelling Housing
Location
25 Marhsall Road

New Lambton Heights
Client
BINNIE

Drawing PERSPECTIVES

Scale
As Shown @ A2

DRAWN CT

Date @ A2 12/02/2019

> QA CHECKED **SV**


Drawing Number
DA001


Issue
B







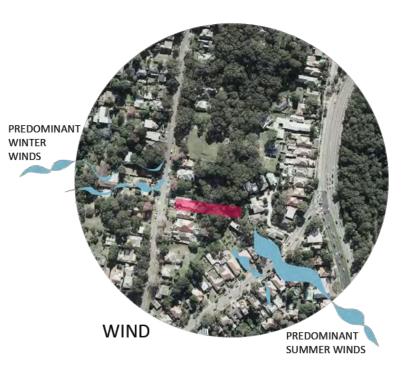

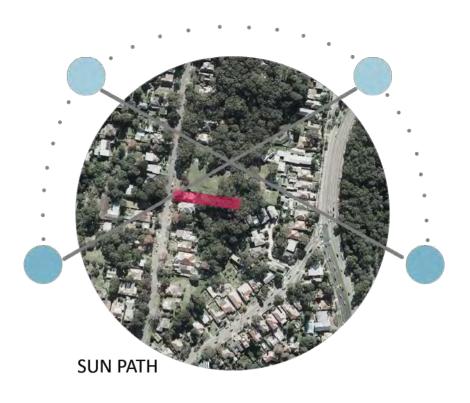



NEW LAMBTON HEIGHTS INFANTS SCHOOL





THE SITE WITH WEST **VIEWS** 



POINTS OF INTEREST

PO Box 601 Kotara NSW 2289 Ph 49524425 Nominated Architect: Daniel Hadley 8209

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1	Issue
П	P2
П	P3
П	P4
П	P5
J	Α

Description Consultant Coordination Hunter Water + Mines Issue Coordination Coordination Development Application RFI Amendments

Date 17-04-18 30-07-18 02-08-18 20-08-18 27-08-18

Project Multi Dwelling Housing 25 Marhsall Road

**New Lambton Heights** Client **BINNIE** 

SITE ANALYSIS PLAN

As Shown @ A2


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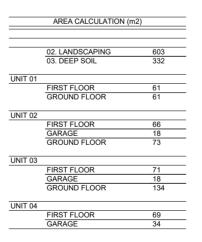
12/02/2019 QA CHECKED **SV** DRAWN


BLACKBUTT RESERVE


Drawing Number **DA002** Issue **B** 





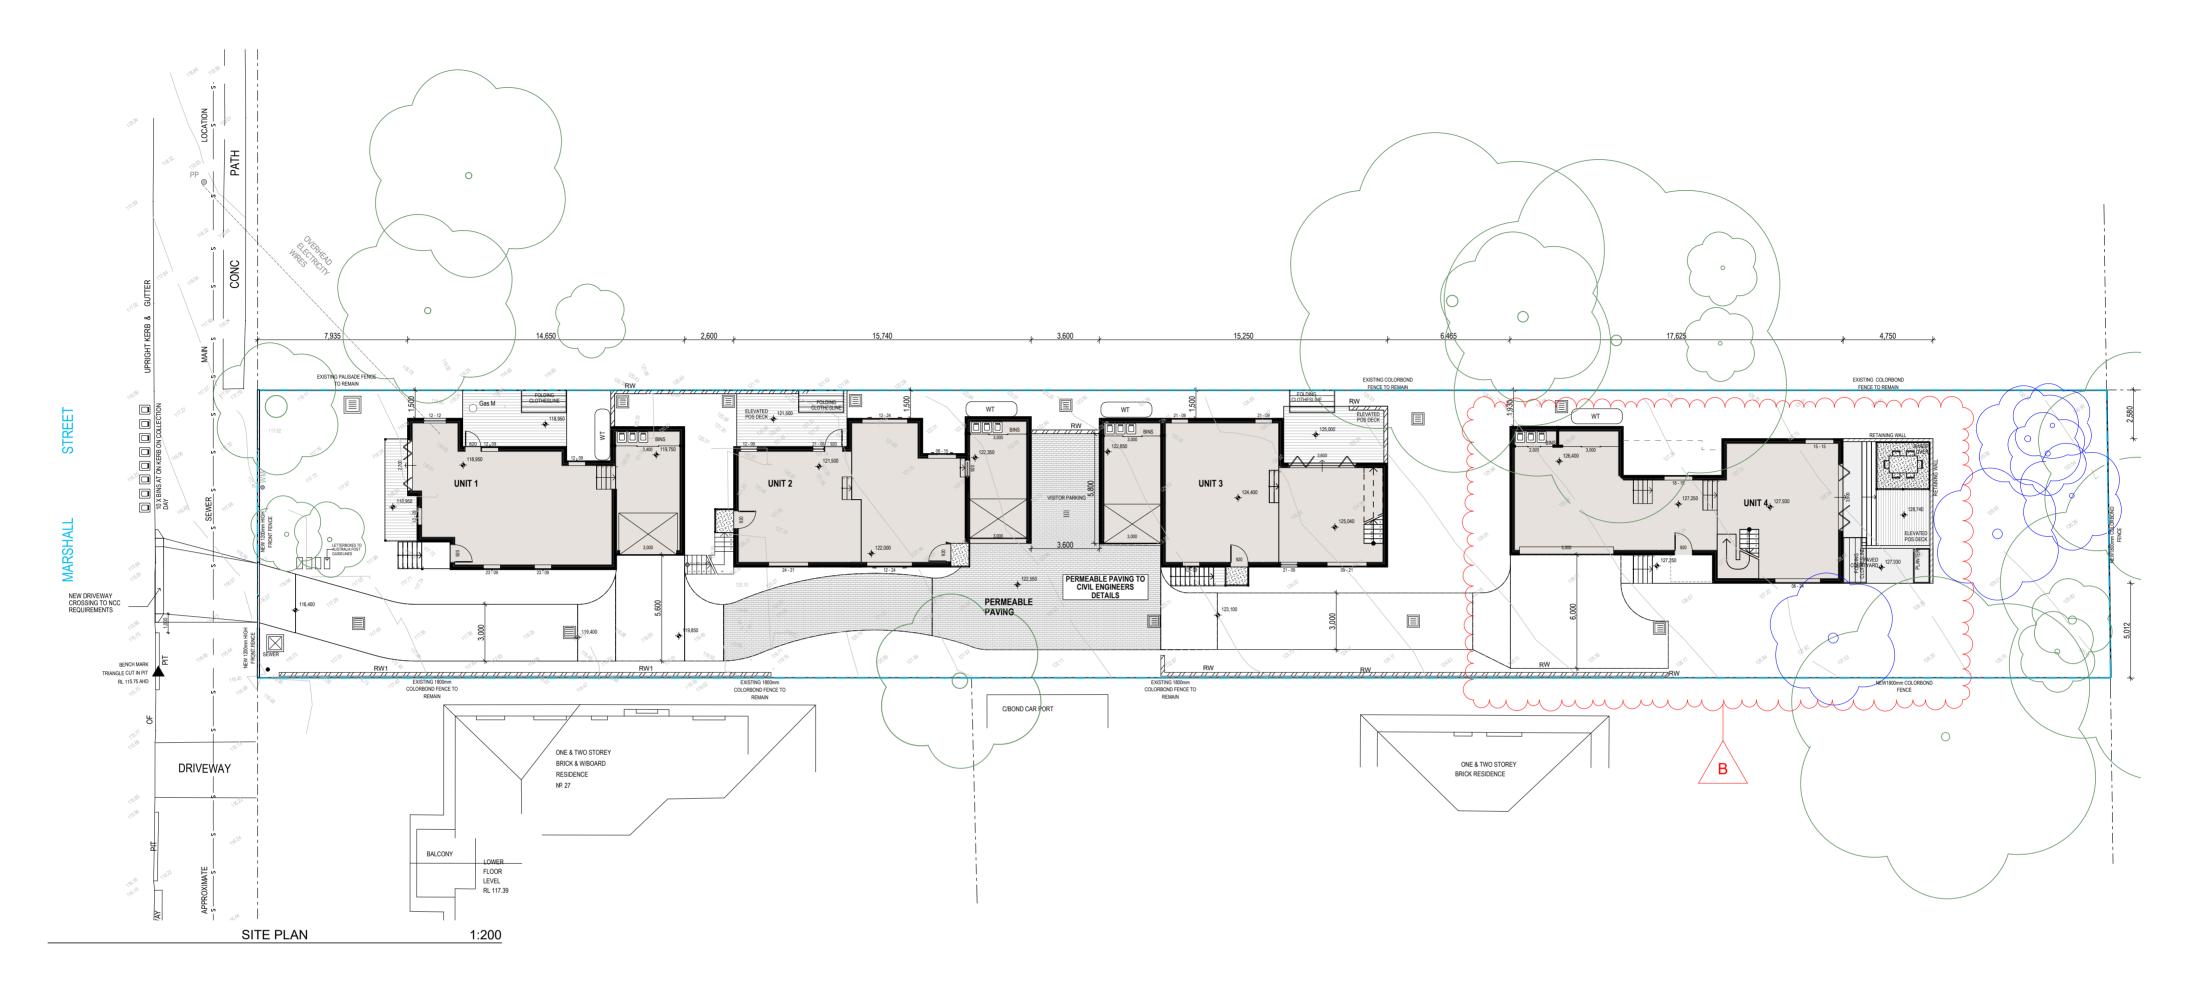

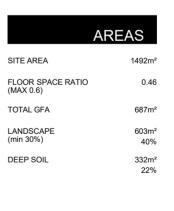

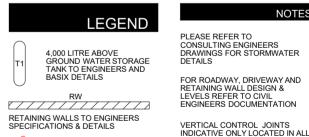

EXISTING TREE TO BE DEMOLISHED

EXISTING TREE TO BE RETAINED

BUILDING FOOTPRINT

--- TO BE DEMOLISHED

VERTICAL CONTROL JOINTS
INDICATIVE ONLY LOCATED IN ALL
EXTERNAL WALLS 5000-6000mm
CTS MAX AS PER ENGINEERS
SPECIFICATIONS TO AS/NZS 4773.2
8 TN 61.(BUILDER TO CONFIRM
LOCATIONS)

NOTES

DOWNPIPE POSITIONS ARE INDICATIVE ONLY, POSITION OF DOWNPIPES TO BE CONFIRMED BY BUILDER.

FOR LANDSCAPE DESIGN & FENCE LOCATIONS REFER TO LANDSCAPE DESIGNERS DOCUMENTATION

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Description Issue Consultant Coordination P3 P4 P5 Hunter Water + Mines Issue Coordination Coordination Development Application RFI Amendments

Date 17-04-18 30-07-18 02-08-18 20-08-18 27-08-18 12-02-19

Project Multi Dwelling Housing 25 Marhsall Road

New Lambton Heights Client **BINNIE** 

Drawing SITE PLAN

DRAWN


CT

12/02/2019 As Shown @ A2

SV

QA CHECKED

Drawing Number **DA003** В

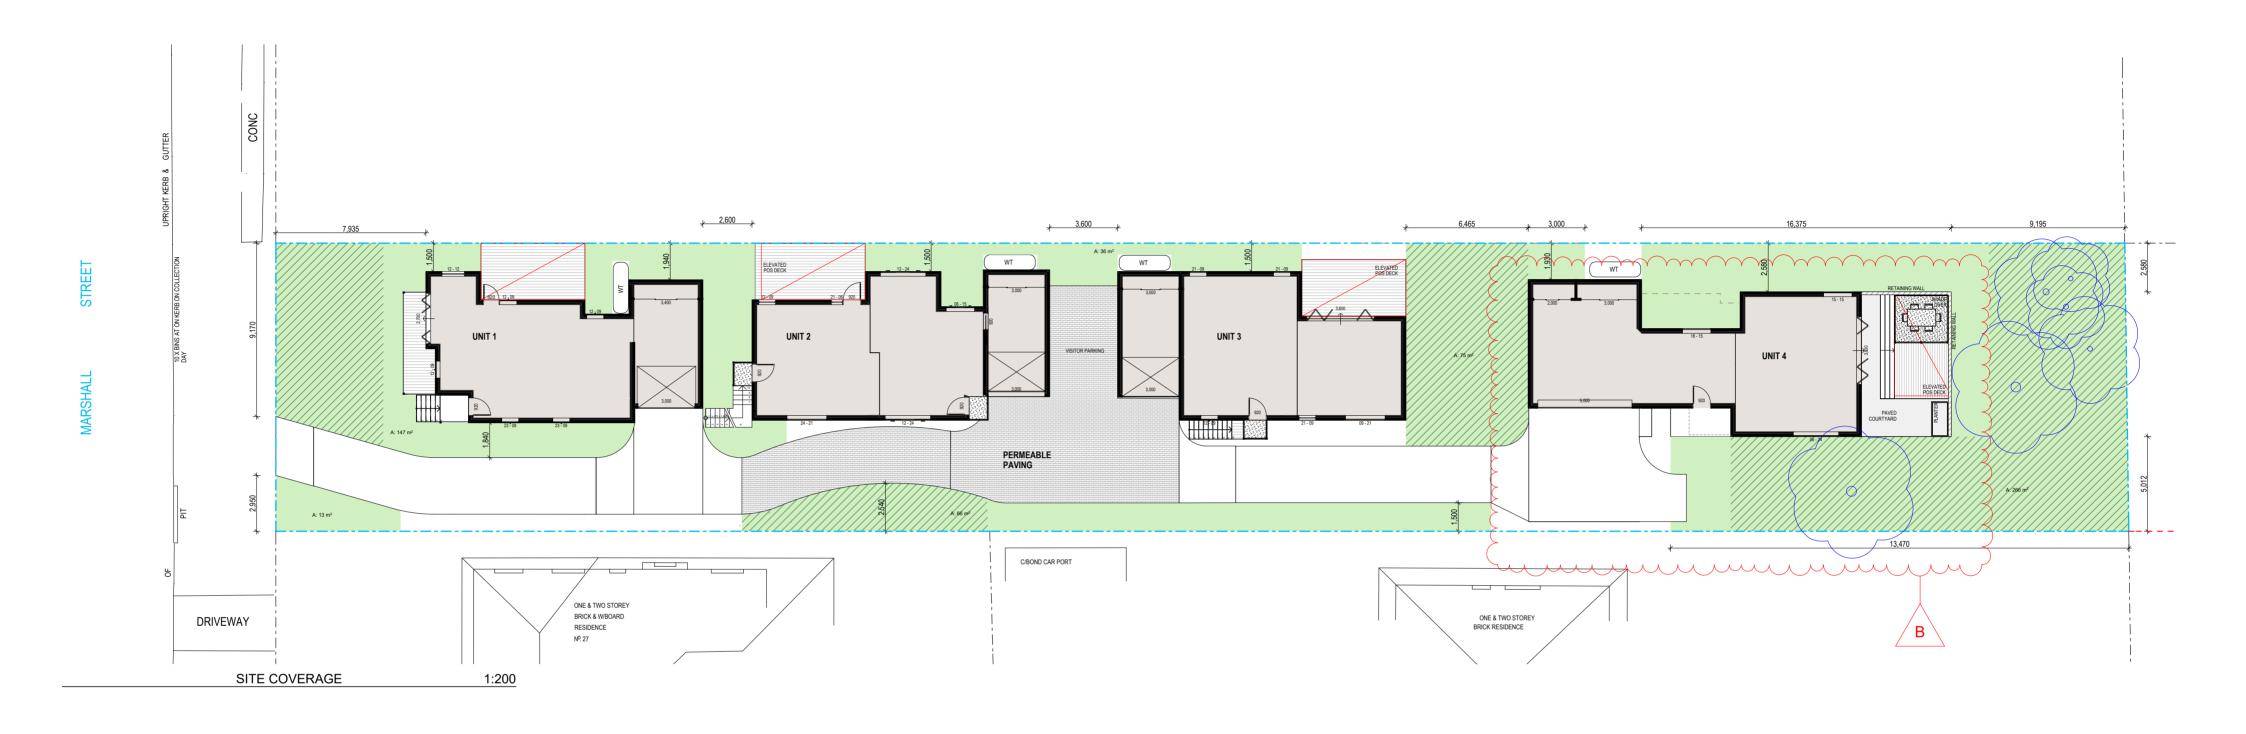



LEGEND

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FOR AUTHORITY APPROVAL ONLY NOT FOR CONSTRUCTION

Date Issue Description 30-07-18 02-08-18 20-08-18 Hunter Water + Mines Issue Coordination Coordination 23-08-18 27-08-18 Coordination Development Application RFI Amendments

P4 P5 P6

Project Multi Dwelling Housing 25 Marhsall Road **New Lambton Heights** Client **BINNIE** 

SITE COVERAGE PLAN

DRAWN

CT

12/02/2019 As Shown @ A2

QA CHECKED


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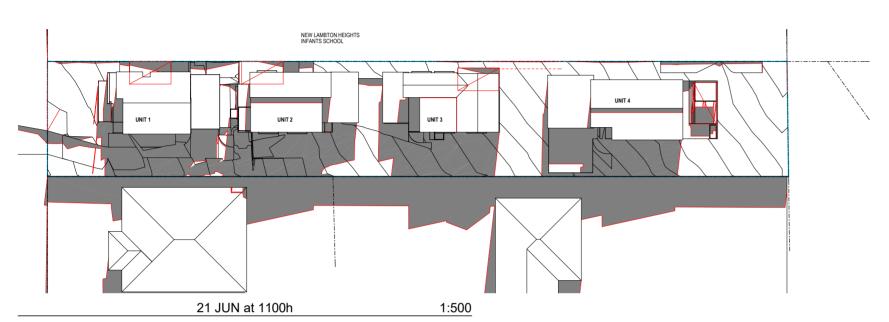
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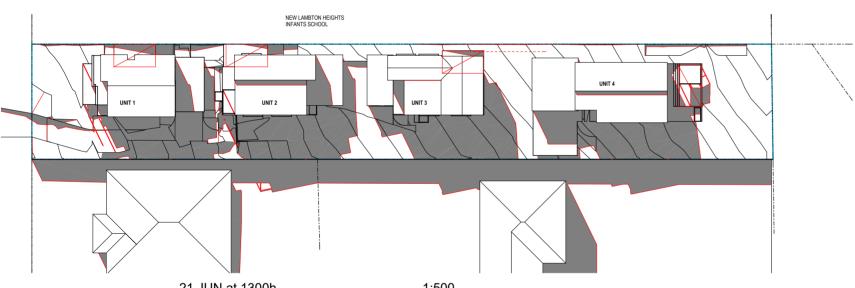
Project Number


17129

FOR LANDSCAPE DESIGN & FENCE LOCATIONS REFER TO LANDSCAPE DESIGNERS DOCUMENTATION







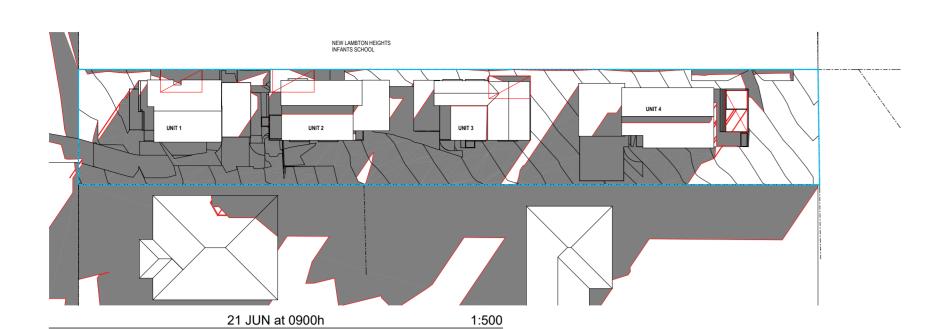


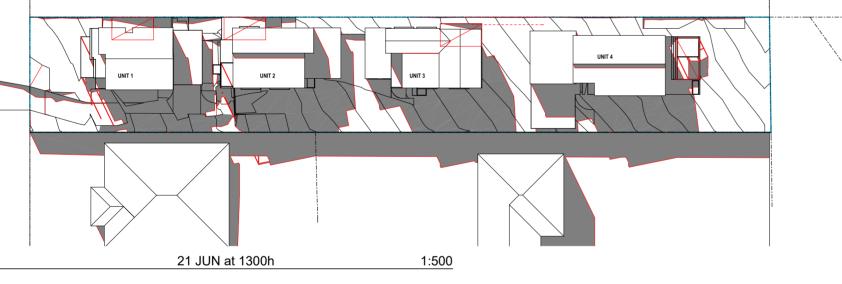




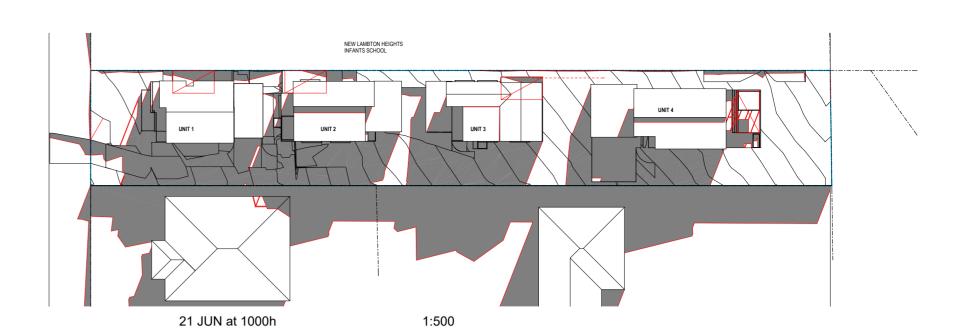

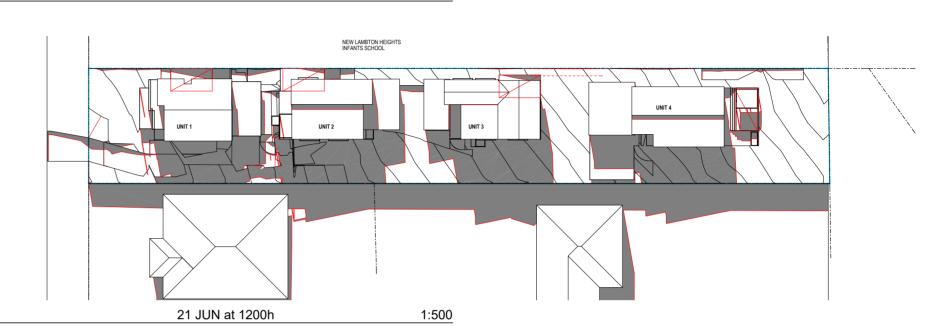

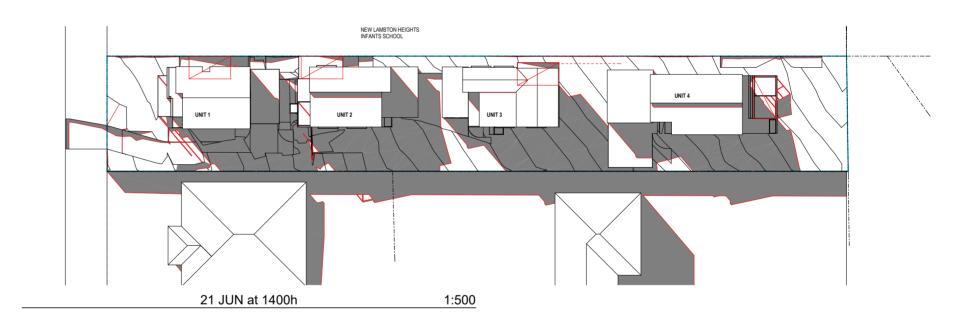

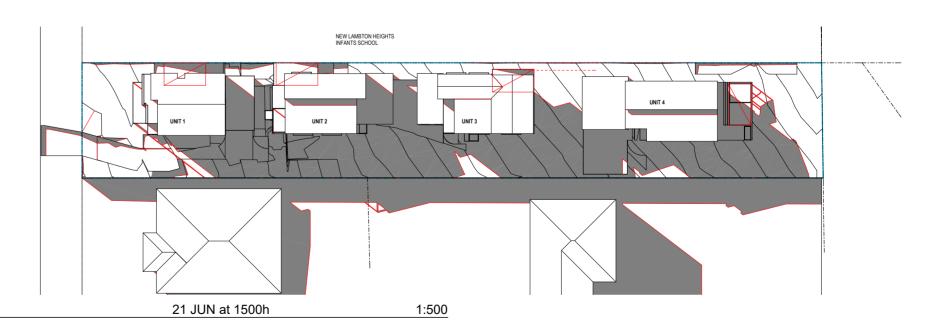

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Description Issue Consultant Coordination Hunter Water + Mines Issue Coordination Coordination Development Application RFI Amendments

Date 20-08-18 27-08-18

Project 17-04-18 30-07-18 02-08-18 Multi Dwelling Housing 25 Marhsall Road **New Lambton Heights** Client **BINNIE** 

DRAWN


CT


SHADOW DIAGRAMS

As Shown @ A2 12/02/2019 QA CHECKED **SV** 

Drawing Number **DA005** Issue **B** 



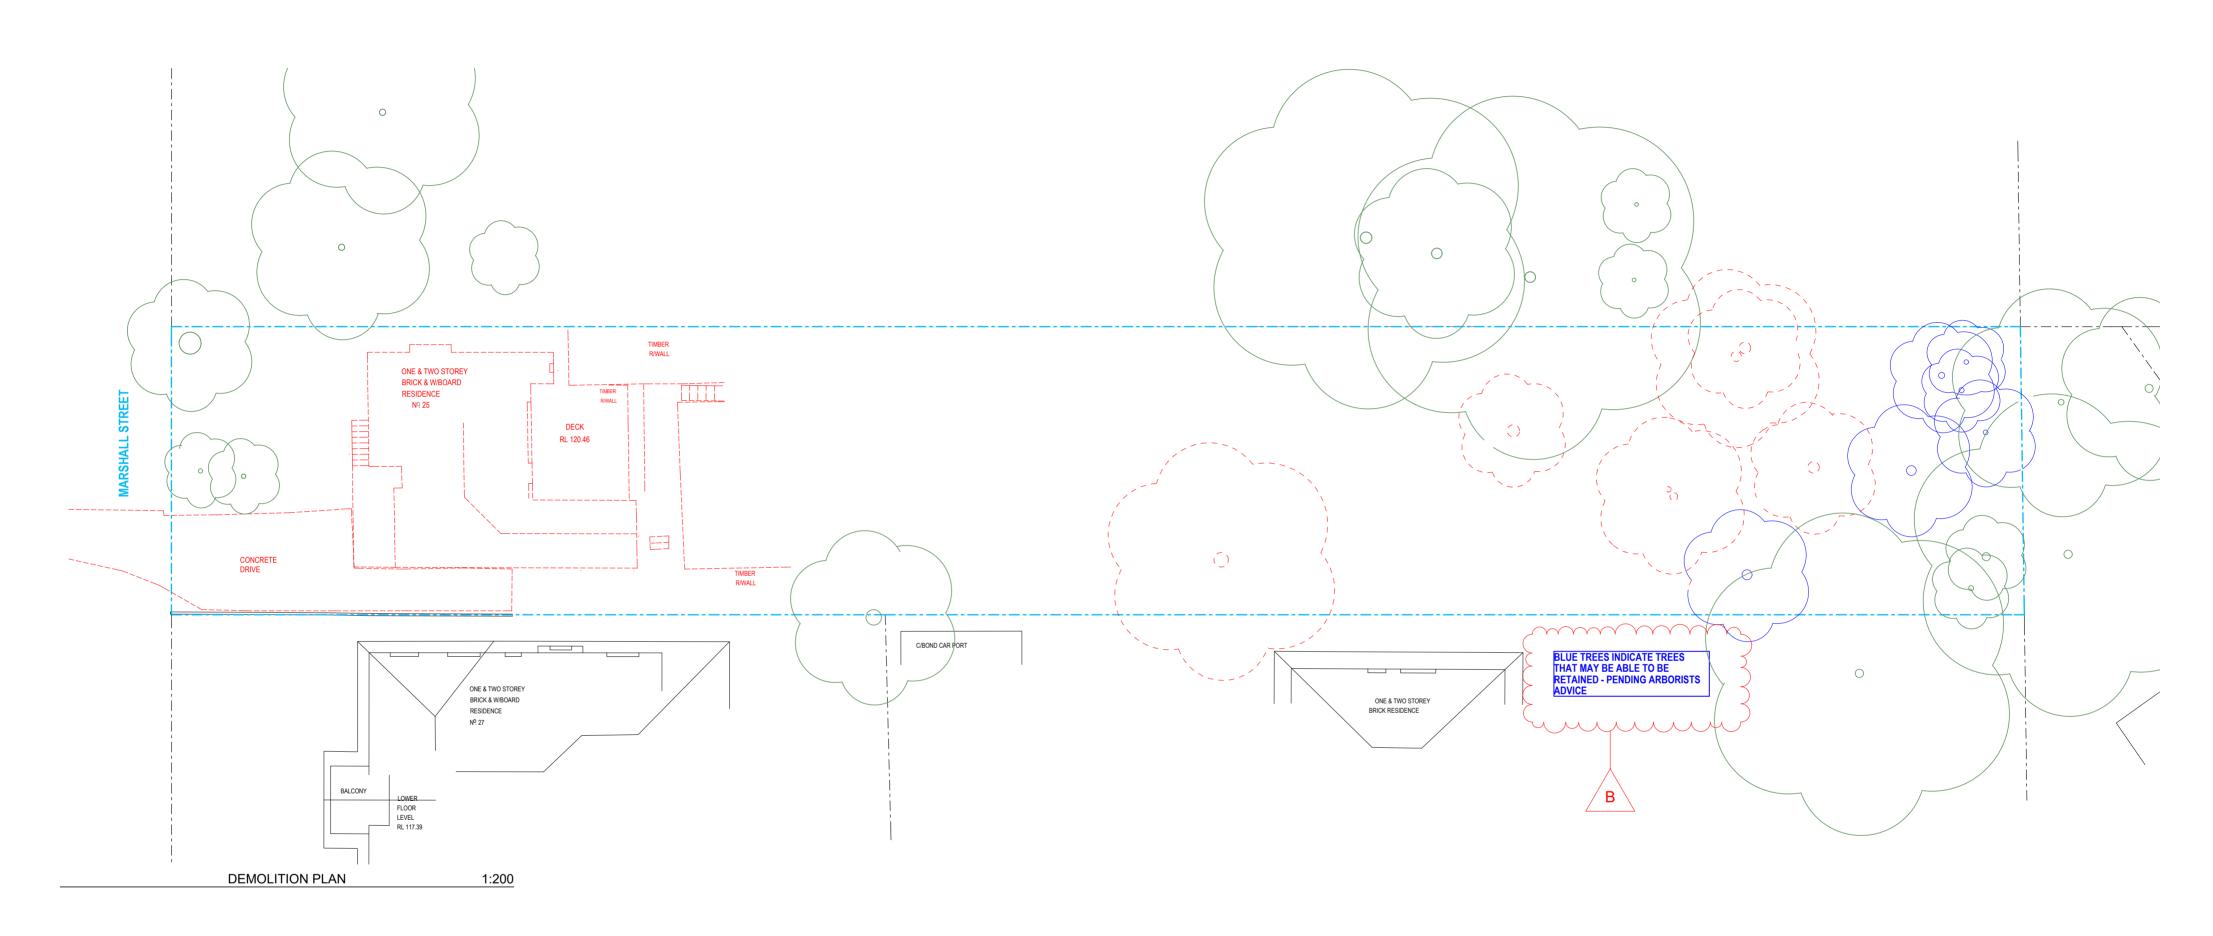

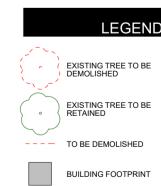

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NSW 2289 Ph 49524425
Nominated Architect: Daniel Hadley 8209

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Issue Description

P1 Hunter Water + Mines Issue
P2 Coordination
P3 Coordination
A Development Application
B RFI Amendments

Date 30-07-18 02-08-18 20-08-18 27-08-18 12-02-19

Multi Dwelling Housing
Location
25 Marhsall Road
New Lambton Heights

Client **BINNIE** 

Scale
As Show

DRAWN
CT

Drawing

DEMOLITION PLAN

Scale Date
As Shown @ A2 12/02/2019


DA006

QA CHECKED **SV** 









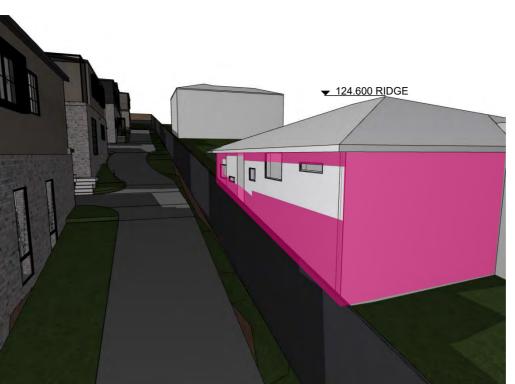

**NEIGHBOUR SHADOWS 11AM** 

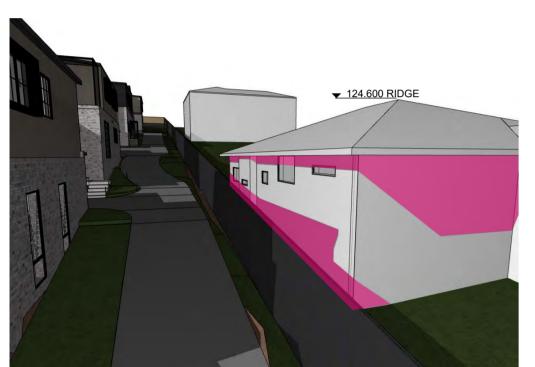




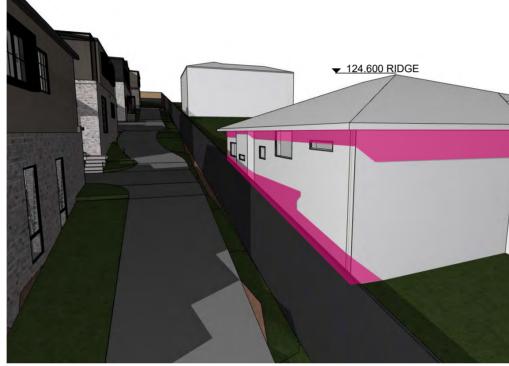

**NEIGHBOUR SHADOWS 1PM** 



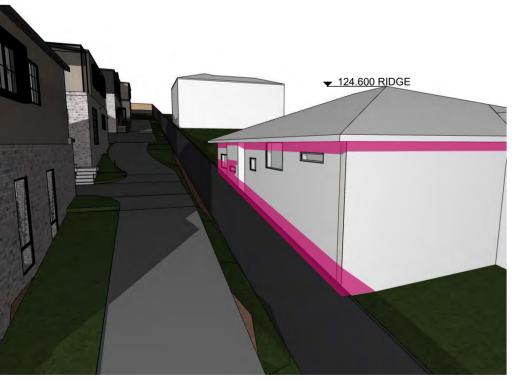

**NEIGHBOUR SHADOWS 3PM** 

**SUMMARY: PROPOSED DEVELOPMENT AT 25** MARSHALL STREET **IMPACTS ON NEIGHBOUR'S** WINDOW SOLAR ACCES AT 9AM ONLY.

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Description Issue Town Planner Review RFI Amendments

Date 19-11-18 12-02-19

Multi Dwelling Housing 25 Marhsall Road **New Lambton Heights** 

Client **BINNIE** 

**NEIGHBOUR SHADOW** ANALYSIS


12/02/2019 As Shown @ A2 DRAWN QA CHECKED CT

Drawing Number **DA008** Issue Α Project Number 17129

**EXTENT OF** 

**SHADOWS** 



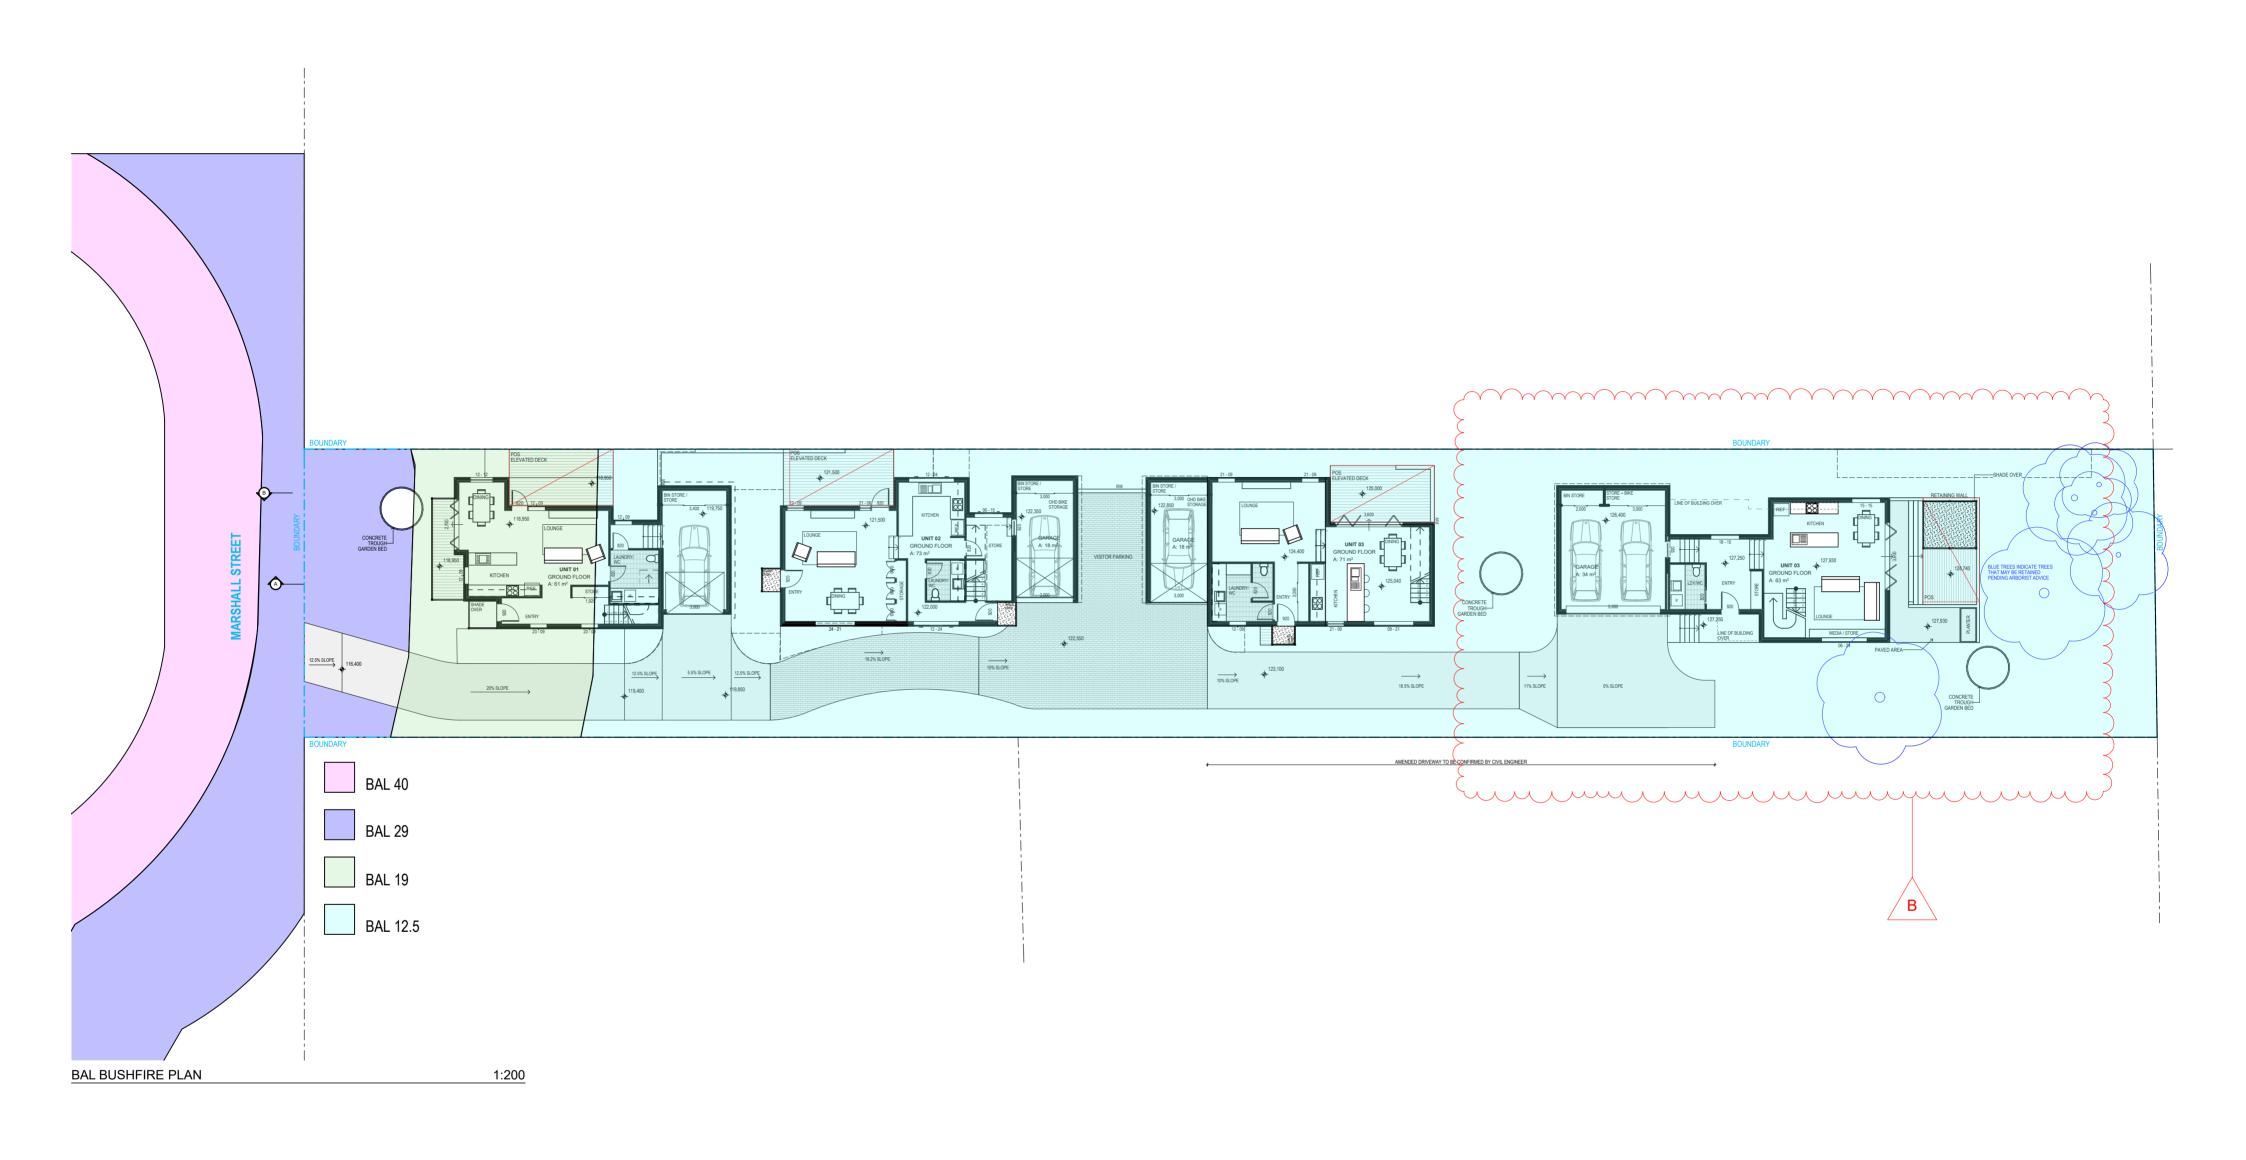





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Description Issue Hunter Water + Mines Issue Coordination Coordination P3 P4 A Development Application RFI Amendments

Date 30-07-18 02-08-18 20-08-18 27-08-18 12-02-19

Project Multi Dwelling Housing 25 Marhsall Road **New Lambton Heights** Client **BINNIE** 

Drawing **BUSHFIRE BAL OVERLAY** PLAN Scale As Shown @ A2

DRAWN

CT

Drawing Number 12/02/2019


QA CHECKED

SV

**DA010** Issue **B** Project Number 17129





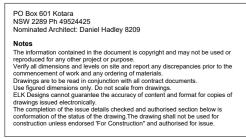



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Description Issue Coordination Coordination
Development Application
Remove Unit 5 RFI Amendments

Date 02-08-18 20-08-18 27-08-18 10-01-19 12-02-19

Project Multi Dwelling Housing 25 Marhsall Road **New Lambton Heights** 

Client **BINNIE** 


Drawing **OVERALL PLANS** 


CT

12/02/2019 As Shown @ A2 QA CHECKED **SV** DRAWN

Drawing Number **DA100** Issue **B** 



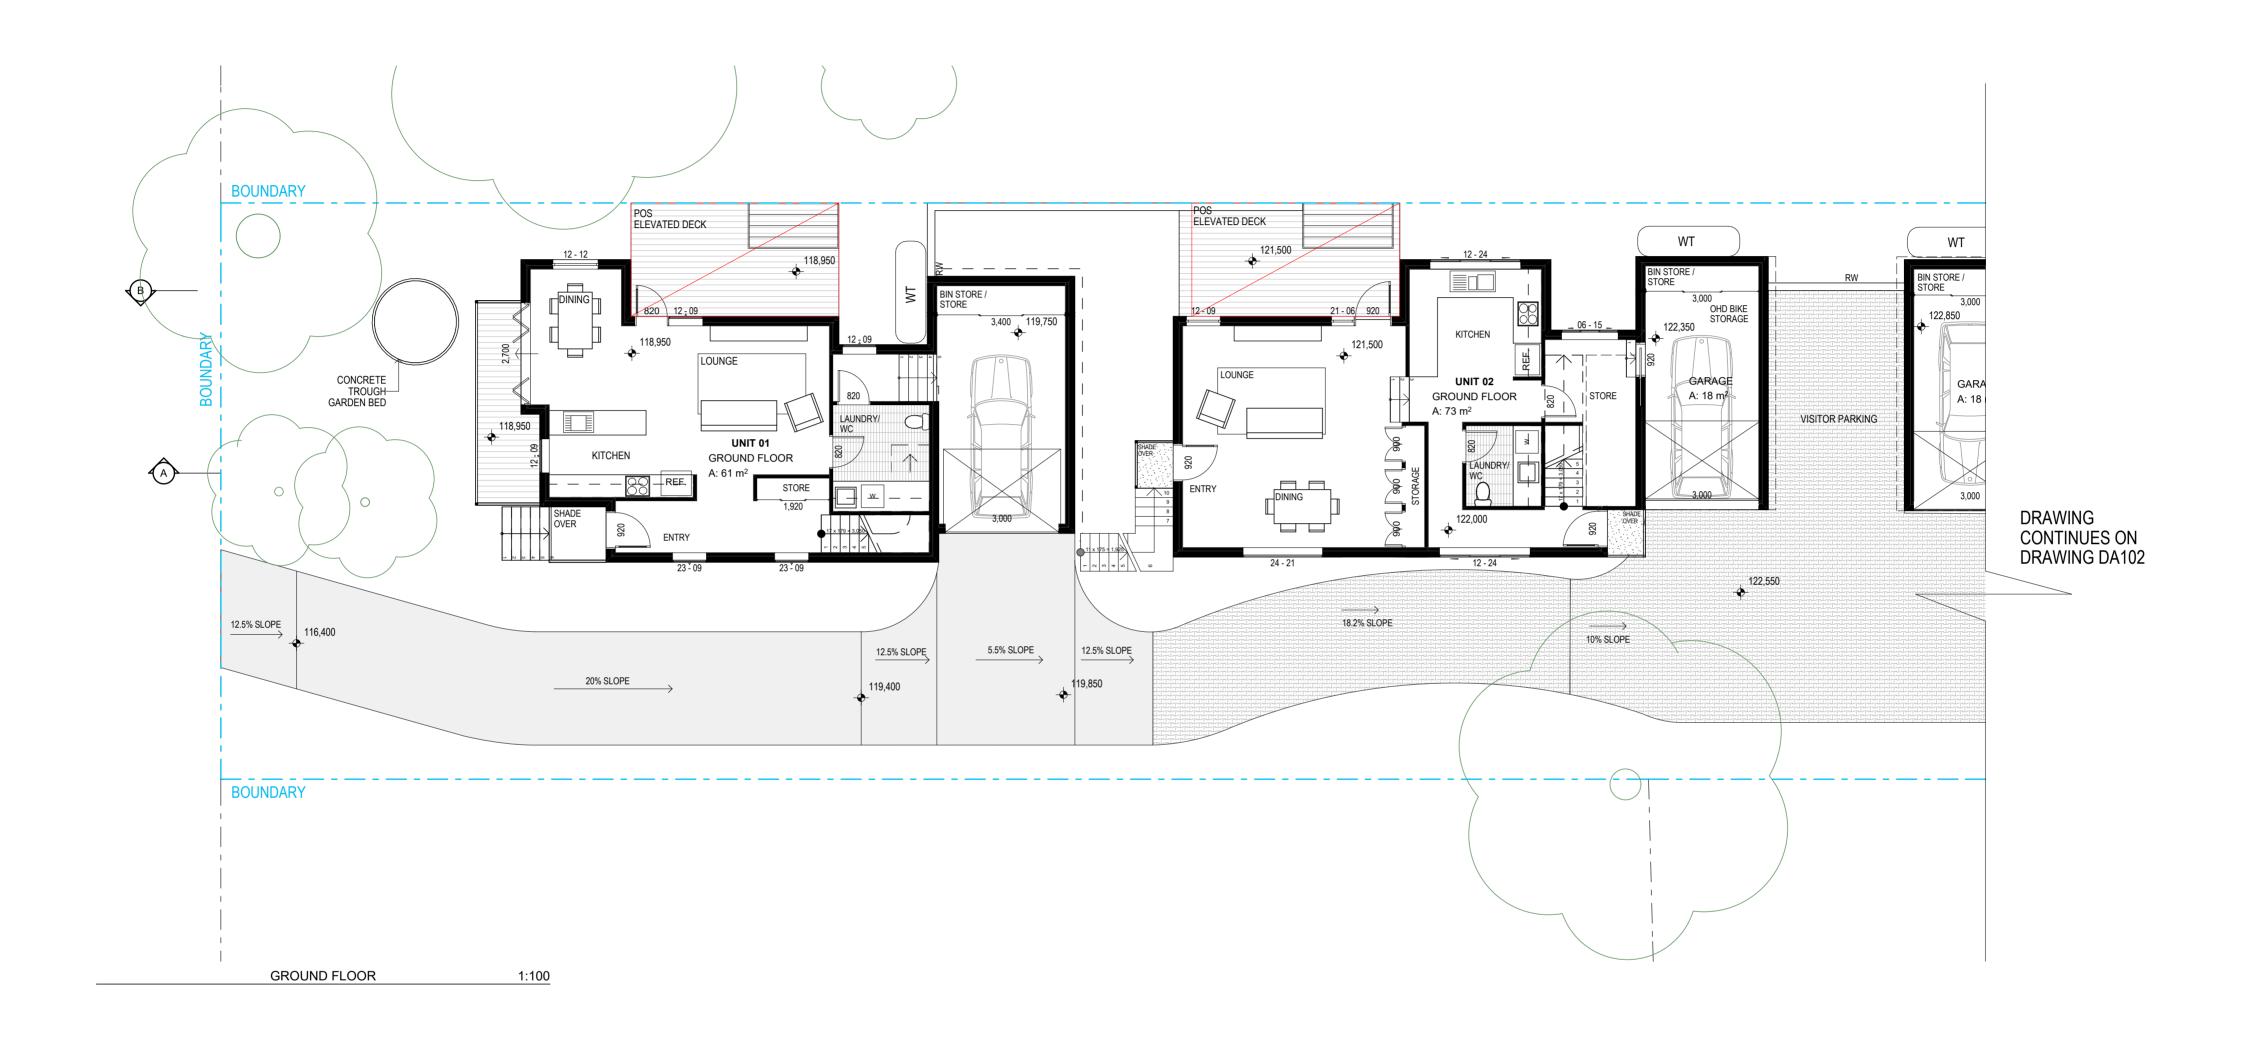

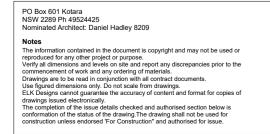



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Issue Description Coordination Development Application Town Planner Review A P9 P10 Remove Unit 5 RFI Amendments

Date Project Multi Dwelling Housing 20-08-18 27-08-18 19-11-18 10-01-18 25 Marhsall Road 12-02-19 **New Lambton Heights** Client **BINNIE** 

DRAWN

CT


GROUND FLOOR - UNITS 1-2 DA101 As Shown @ A2 12/02/2019

SV

Issue **B** Project Number QA CHECKED 17129

Drawing Number



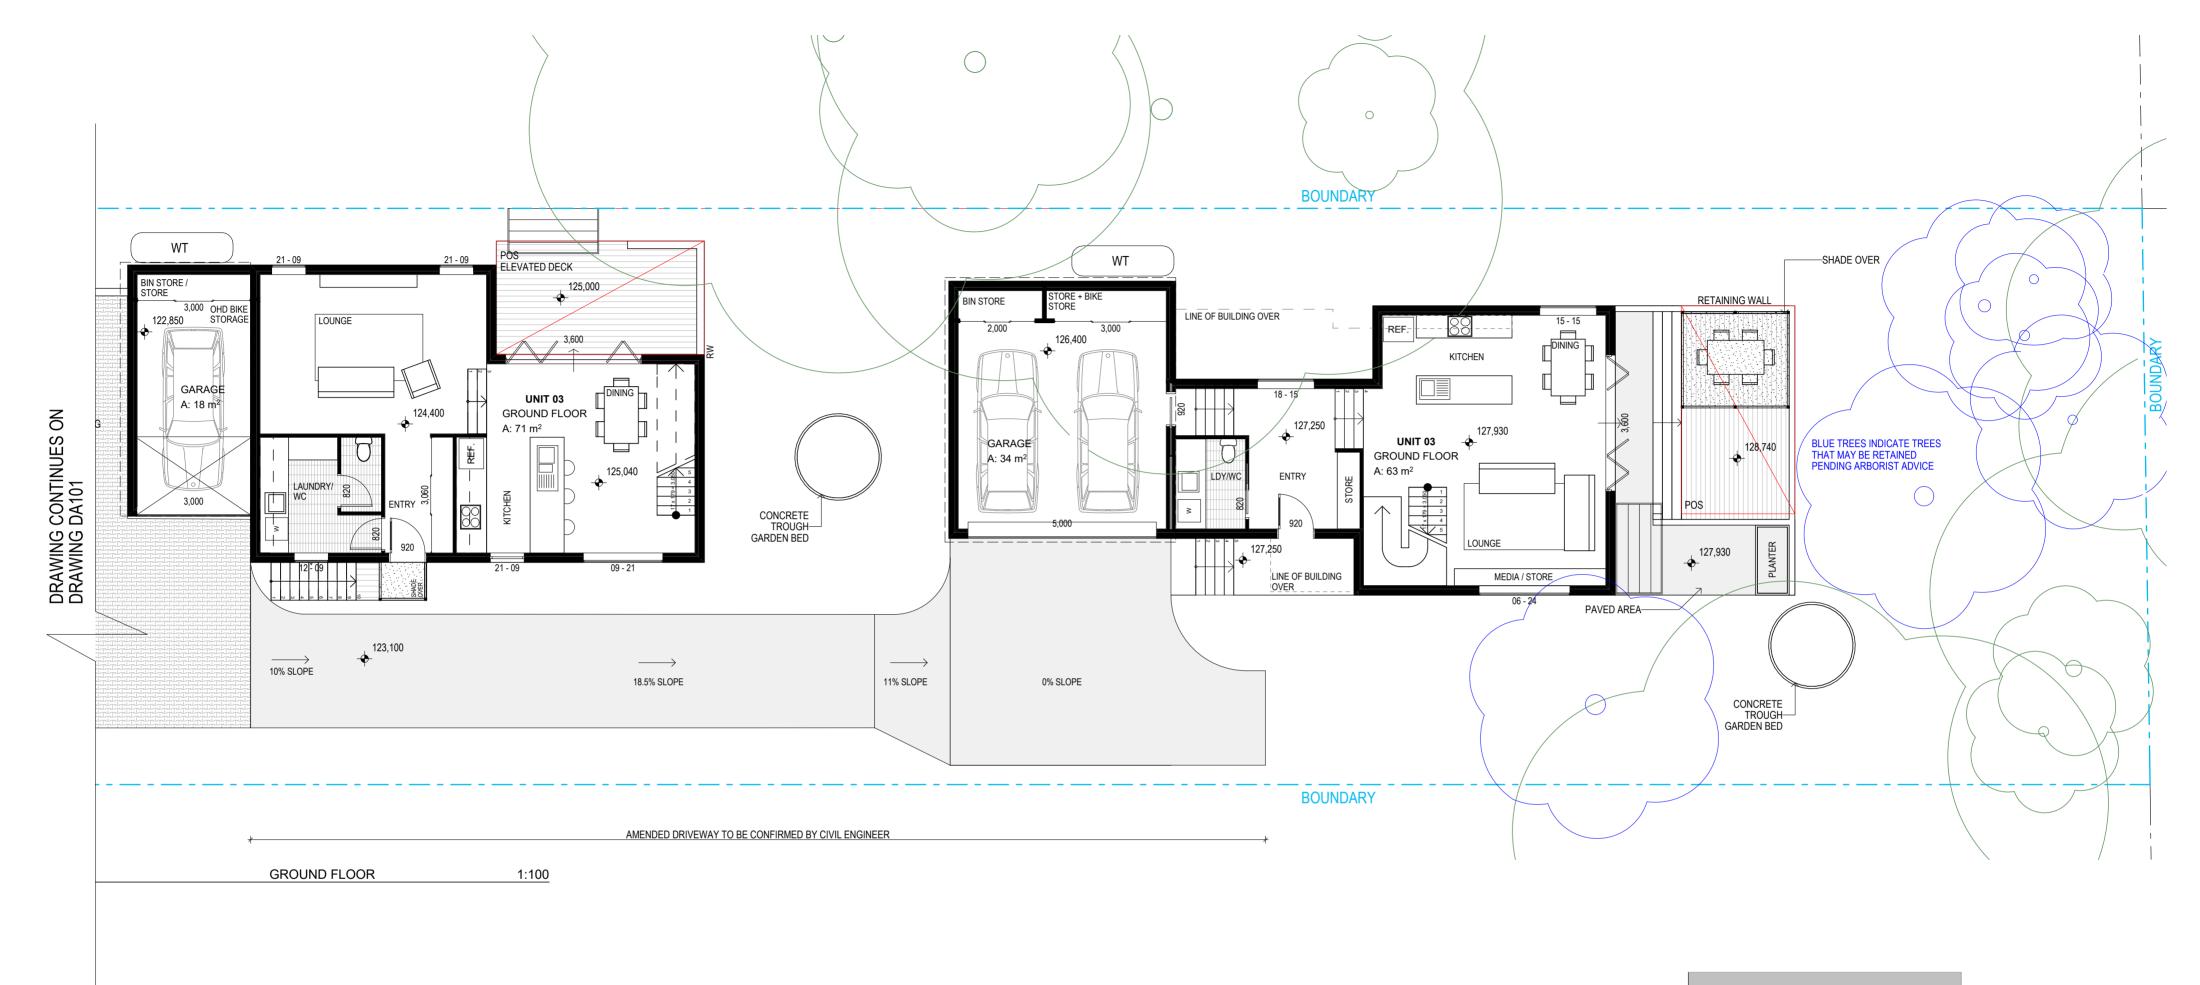

OVERHEAD BIKE STORAGE SECTION

Drawing Number

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Description Issue Coordination Coordination Development Application Remove Unit 5 RFI Amendments

Date 02-08-18 20-08-18 27-08-18 10-01-19 12-02-19

Project Multi Dwelling Housing 25 Marhsall Road

**New Lambton Heights** Client **BINNIE** 

**GROUND FLOOR - UNITS 3-4** 

CT

**DA102** Issue **B** 12/02/2019 As Shown @ A2 Project Number DRAWN QA CHECKED 17129

SV





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NSW 2289 Ph 49524425
Nominated Architect: Daniel Hadley 8209

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Issue Description

P7 Coordination

P8 Coordination

A Development Application

P9 Remove Unit 5

B RFI Amendments

Project
Multi Dwelling Housing
Location
25 Marhsall Road
New Lambton Heights
Client
BINNIE

Date

02-08-18 20-08-18 27-08-18

10-01-19

12-02-19

FIRST FLOO

Scale
As Shown @ A2

DRAWN

CT

FIRST FLOOR - UNITS 1-2

Scale Date

QA CHECKED

SV

Drawing Number

17129

ELK

**BOUNDARY** 

DASHED LINE OF ROOF OVER LINE OF BULDING BELOW LINE OF GARAGE ROOF BELOW 130,980 UNIT 04
FIRST FLOOR
A: 69 m<sup>2</sup> OBSCURE GLASS-PRIVACY SHROUD TO ALL BEDROOM WINDOWS (TYPICAL) -OBSCURE GLASS

FIRST FLOOR

1:100

**BOUNDARY** 

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NOT FOR CONSTRUCTION

Description Issue Coordination Remove Unit 5 RFI Amendments Date 12-02-19

Multi Dwelling Housing 25 Marhsall Road **New Lambton Heights** Client **BINNIE** 

FIRST FLOOR - UNITS 3-4

**DA104** 12/02/2019

Drawing Number

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DRAWING CONTINUES ON DRAWING DA103

FOR AUTHORITY APPROVAL ONLY


Coordination
Development Application

02-08-18 20-08-18 27-08-18 10-01-19

DRAWN CT

As Shown @ A2 QA CHECKED SV

Issue **B** Project Number 17129

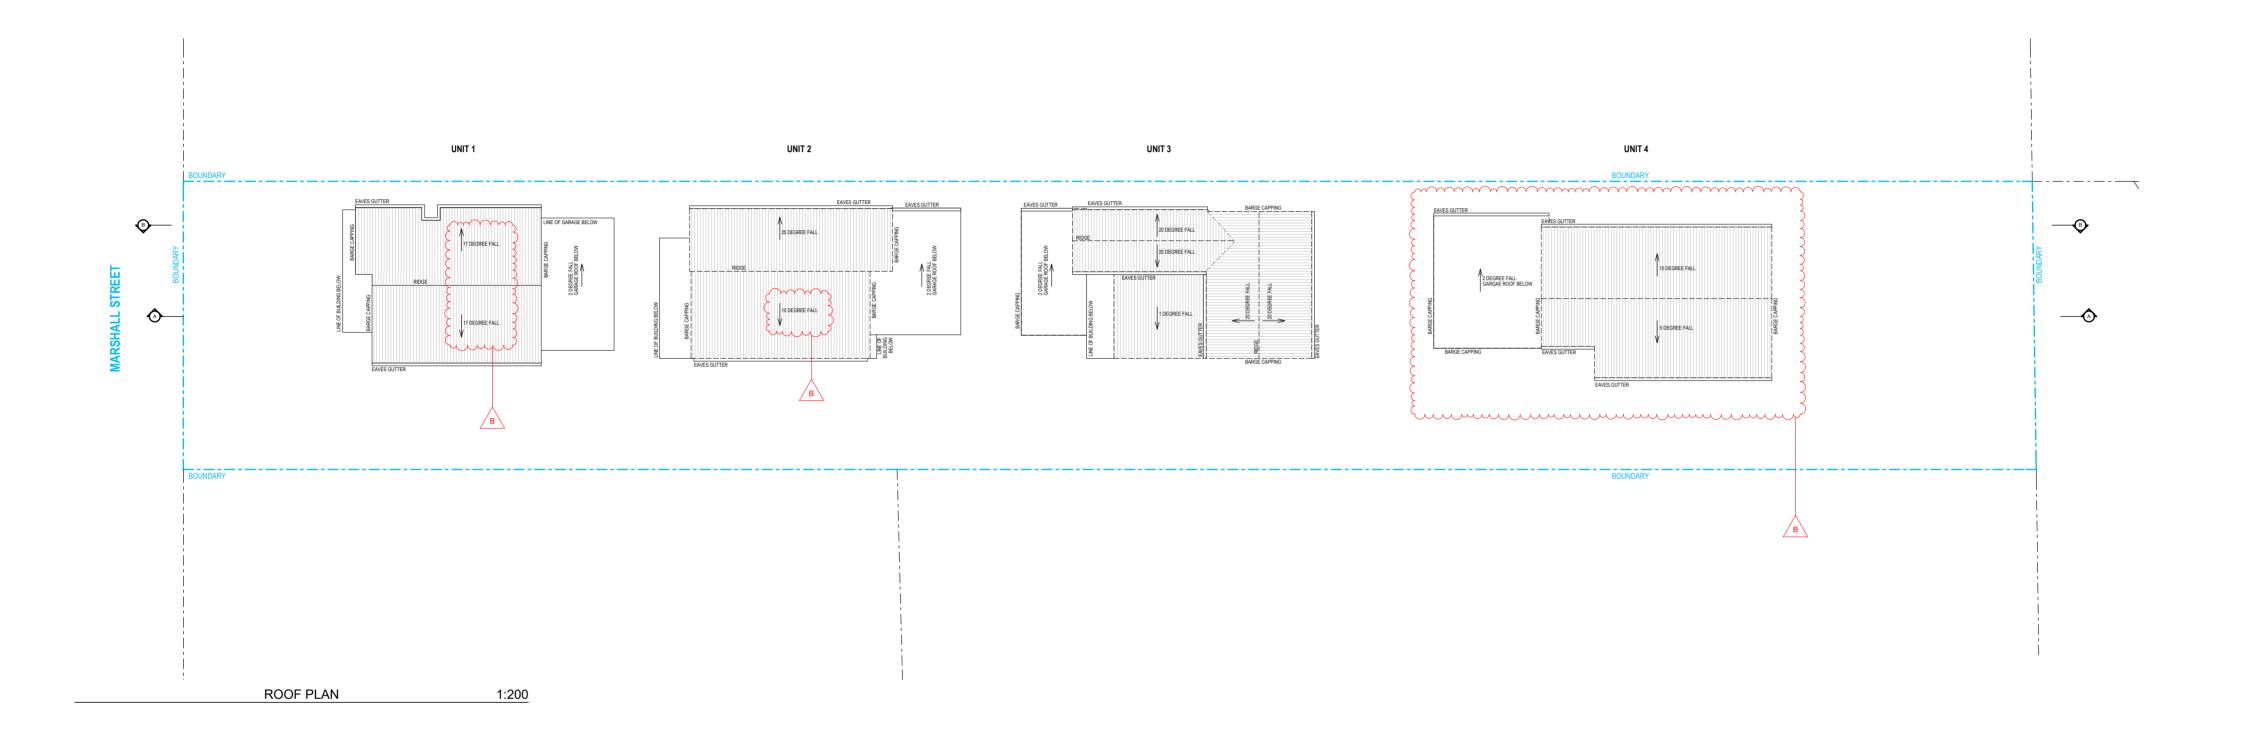

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Description Issue P2 P3 P4 A Hunter Water + Mines Issue Coordination Coordination Development Application RFI Amendments

Project 30-07-18 02-08-18 20-08-18 27-08-18 Multi Dwelling Housing 25 Marhsall Road 12-02-19 **New Lambton Heights** Client **BINNIE** 

Date

Drawing **ROOF PLAN** As Shown @ A2 DRAWN

CT


12/02/2019 QA CHECKED **SV** 

Drawing Number **DA105** Issue **B** Project Number


17129





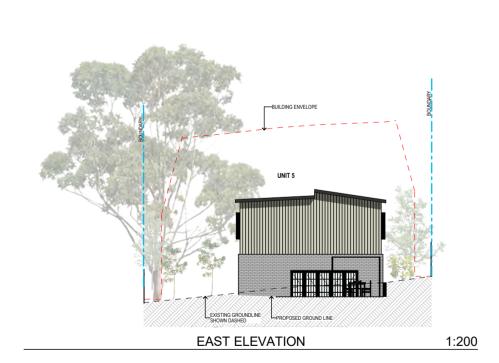



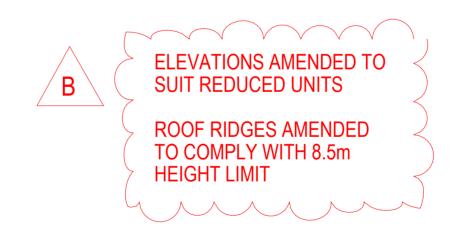

VERTICAL CONTROL JOINTS INDICATIVE ONLY LOCATED IN ALL EXTERNAL WALLS 5000-6000mm CTS MAX AS PER ENGINEERS SPECIFICATIONS TO AS/NZS 4773.2 & TN 61. (BUILDER TO CONFIRM LOCATIONS)

DOWNPIPE POSITIONS ARE INDICATIVE ONLY, POSITION OF DOWNPIPES TO BE CONFIRMED BY BUILDER.

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Description Issue Hunter Water + Mines Issue P4 P5 A Coordination Coordination Development Application RFI Amendments

Date 30-07-18 02-08-18 20-08-18 27-08-18 12-02-19

Project Multi Dwelling Housing Location 25 Marhsall Road

**New Lambton Heights** Client **BINNIE** 

Drawing **ELEVATIONS** 

DRAWN

CT

12/02/2019 As Shown @ A2 QA CHECKED

SV

Drawing Number **DA300** В Project Number

17129







VERTICAL CONTROL JOINTS INDICATIVE ONLY LOCATED IN ALL EXTERNAL WALLS 5000-6000mm CTS MAX AS PER ENGINEERS SPECIFICATIONS TO AS/NZS 4773.2 & TN 61. (BUILDER TO CONFIRM LOCATIONS)

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Issue Description Hunter Water + Mines Issue P3 P4 A Coordination Coordination Development Application RFI Amendments

Date 30-07-18 02-08-18 20-08-18 27-08-18 12-02-19

Project Location

Multi Dwelling Housing 25 Marhsall Road **New Lambton Heights** Client **BINNIE** 

**ELEVATIONS** As Shown @ A2 DRAWN

CT

Drawing

12/02/2019 QA CHECKED

SV

Drawing Number **DA301** В Project Number 17129





SAME MATERIALS USED FOR ALL UNITS IN DIFFERENT LOCATIONS

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Issue Description

P2 Hunter Water + Mines Issue
P3 Coordination
P4 Coordination
A Development Application
B RFI Amendments

Date
30-07-18
02-08-18
20-08-18
27-08-18
12-02-19

Project

Multi Dwelling Housing

Location

Solution

Solution

Location

Solution

Multi Dwelling Housing

Location

Solution

Location

Multi Dwelling Housing

25 Marhsall Road
New Lambton Heights
Client
BINNIE

Drawing
EXTERNAL FINISHES

CT

Scale Date
As Shown @ A2 12/02/2019

DRAWN QA CHECKED

SV

Drawing Number
DA350

Issue
B









REFER TO CONSULTING ENGINEERS DRAWINGS FOR STORMWATER DETAILS

VERTICAL CONTROL JOINTS INDICATIVE ONLY LOCATED IN ALL EXTERNAL WALLS 5000-6000mm CTS MAX AS PER ENGINEERS SPECIFICATIONS TO ASINZS 4773.2 & TN 61. (BUILDER TO CONFIRM LOCATIONS)

FOR LANDSCAPE DESIGN & FENCE LOCATIONS REFER TO LANDSCAPE DESIGNERS DOCUMENTATION

PO Box 601 Kotara NSW 2289 Ph 49524425 Nominated Architect: Daniel Hadley 8209

Notes

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Issue Description Hunter Water + Mines Issue Coordination Coordination P4 P5 A Development Application RFI Amendments

Date 30-07-18 02-08-18 20-08-18 27-08-18 12-02-19

Project Multi Dwelling Housing 25 Marhsall Road **New Lambton Heights** 

Client **BINNIE** 

**SECTIONS** As Shown @ A2 DRAWN


Drawing

CT

Issue **B** 12/02/2019 QA CHECKED **SV** 

Drawing Number **DA400** Project Number 17129



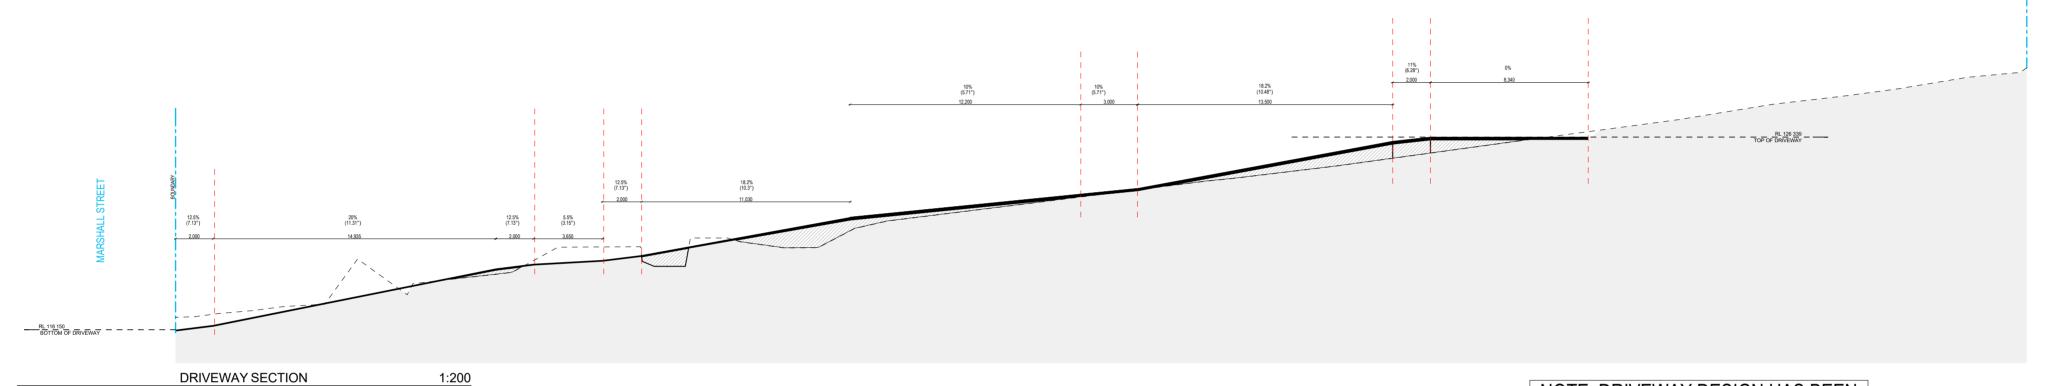

NOTE: DRIVEWAY DESIGN HAS BEEN AMENDED TO SUIT REDUCED UNITS - DESIGN BE CONMFIRMED WITH CIVIL **ENGINEER** 



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Date 30-07-18 02-08-18 20-08-18 27-08-18 12-02-19

Project Multi Dwelling Housing 25 Marhsall Road **New Lambton Heights** Client **BINNIE** 

**SECTIONS** As Shown @ A2 DRAWN CT

Drawing

12/02/2019 QA CHECKED **SV** 

Drawing Number **DA401** Issue **B** Project Number 17129



# Sediment and erosion control

All erosion and sediment control measures to be installed prior to site disturbance.

The project manager to inform all contractors and sub-contractors of their obligations under the erosion and sediment control plan.

Topsoil from all areas that will be disturbed to be stripped and stockpiled at the nominated site.

All sediment control structures to be inspected by site supervisor after each rainfall event for structural damage and all trapped sediment to be removed to a nominated stockpile site.

Sediment and erosion control shall be effectively maintained at all times during the course of construction and shall not be removed until the site has been stabilised or landscaped to the superintendent's satisfaction.

A single all weather access way will be provided at the front of the property consisting of 50-75 aggregate or similar material at a minimum thickness of 150 laid over needle-punched geotextile fabric and constructed prior to commencement of works.

The contractor shall ensure that no spoil or fill encroaches upon adjacent areas for the duration of works.

The contractor shall ensure that kerb inlets and drains receiving stormwater shall be protected at all times during development. Kerb inlet sediment traps shall be installed along the immediate vicinity along the street frontage.

Sediment fencing shall be secured by post (where metal star pickets are used plastic safety caps shall be used) at 3000 intervals with geotextile fabric embedded 200 in soil.

All topsoil stripped from the site and stockpiled does not interfere with drainage lines and stormwater inlets and will be suitably covered with an impervious membrane material and screened by sediment fencing.

# Soil conservation

Prior to commencement of construction provide 'sediment fence,' 'sediment trap' and washout area to ensure the capture of water borne material generated from the site.


Maintain the above during the course of construction, and clear the 'sediment trap after each storm.


# Sediment trap

1000 x 1000 wide 500 deep pit, located at the lowest point to the trap sediment.

# Sediment fence

Provide sediment fence on down slope boundary as shown on plan. Fabric to be buried below ground at lower edge.

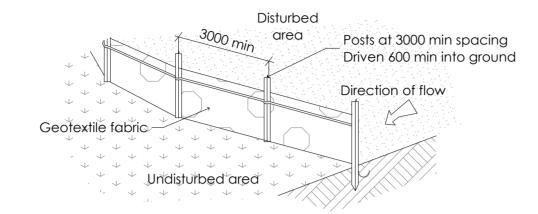


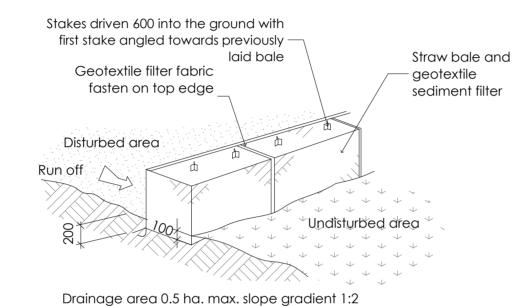

# Washout area


max. slope length 50m.

to be 1800 x 1800 allocated for the washing of tool and equipment

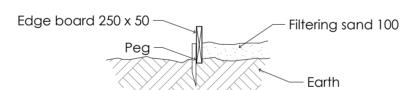


# Vehicle access to site

Vehicle access to the building site should be restricted to a single point so as to reduce the amount of soil deposited on the street pavement.

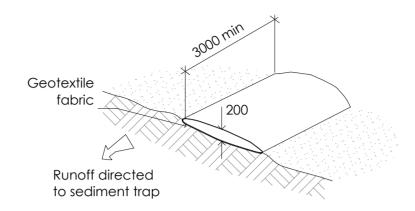


# **Building material stockpiles**

All stockpiles of building material such as sand and soil must be protected to prevent scour and erosion. they should never be placed in the street gutter where they will wash away with the first rainstorm.

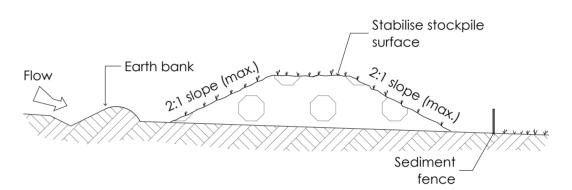

# Sandbag kerb sediment trap

In certain circumstances extra sediment trapping may be needed in the street gutter.

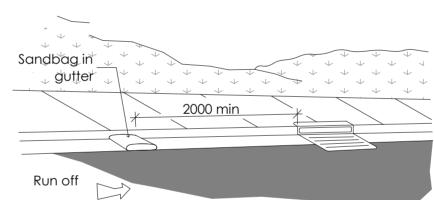

PO Box 601 Kotara NSW 2289 Ph 49524425 Nominated Architect: Daniel Hadley 8209

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# RESIDENTIAL APARTMENTS 25 MARSHALL STREET NEW LAMBTON HEIGHTS



#### DRAWING SCHEDULE

DRG No. DRAWING TITLE

DA00 COVER SHEET AND DRAWING SCHEDULE

A01 CONCEPT EROSION AND SEDIMENT CONTROL PLAN – SHEET 1
A02 CONCEPT EROSION AND SEDIMENT CONTROL PLAN – SHEET 2

DA03 CONCEPT EROSION AND SEDIMENT CONTROL DETAILS

DA04 CONCEPT CIVIL AND STORMWATER PLAN – SHEET 1
DA05 CONCEPT CIVIL AND STORMWATER PLAN – SHEET 2

DAG6 TYPICAL DETAILS AND STORMWATER SUMMARY

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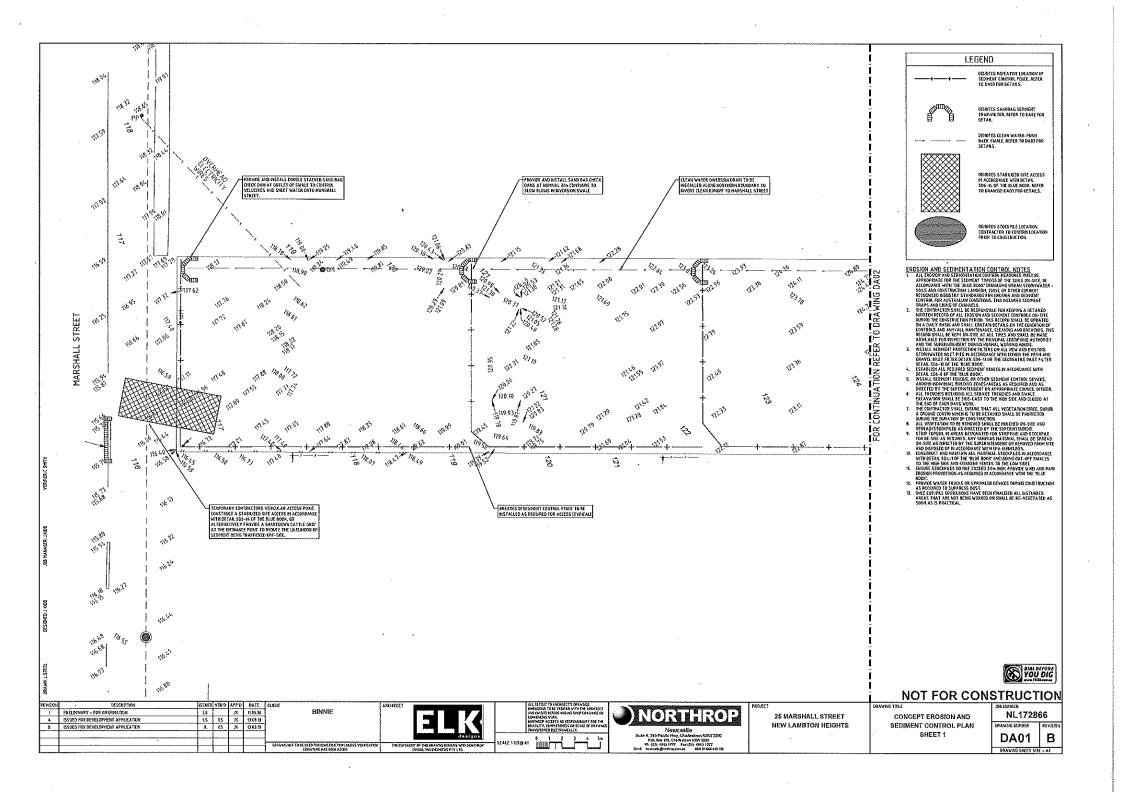
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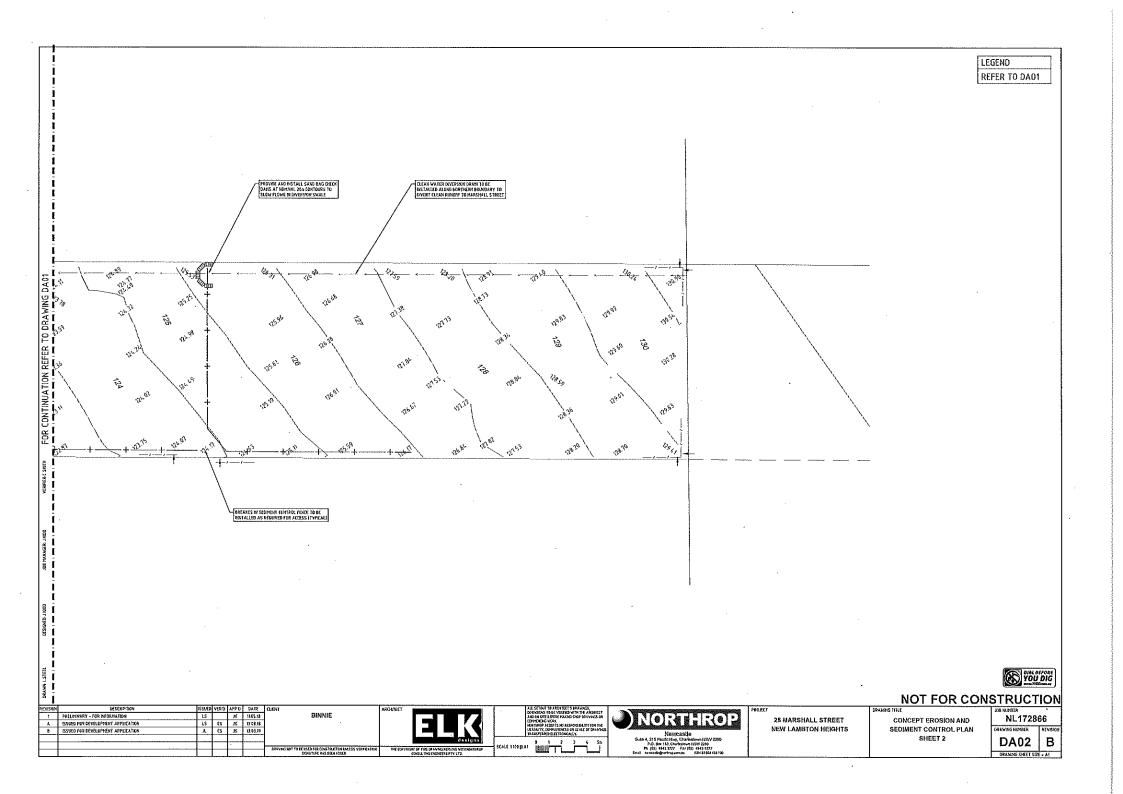
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25 MARSHALL STREET NEW LAMBTON HEIGHTS COVER SHEET AND DRAWING SCHEDULE

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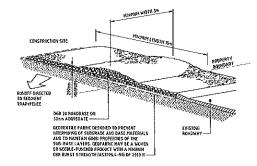




- CONSTRUCTION NOTES

  1. PLACE STOCKPALE MORE THAN 2: IPREFERABLY S=) FROM EXISTING VEGETATION, CONCENTRATED WATER FLOW, ROADS AND MAZARD MERCAS.
- CONSTRUCT ON THE CONTOUR AS LOW, PLAT, ELUNGATED MORNDS.
   WHERE THERE IS SUFFICIENT AREA, TOPSOL, STOCKPALES SHALL BE LESS THAN 2% BY HEIGHT.
- WHERE THEY ARE TO BE EXPLACE FOR MORE THAN 19 DAYS, STABLISE FOLLOWING THE APPROVED ESCO OR SWAP TO REDUCE THE C-FACTOR TO LESS THAN 0.19.
- CONSTRUCT EARTH BANKS ISTANDARD DRAWING 5-5) ON THE UPSLOPE SDE TO DIVERT WATER AROUND STOCKPRES AND SECRETH FENCES (STANDARD DRAWING 6-0) 1 TO 2n DOWNSLOPE.


#### STOCKPILES (SD 4-1)



- CONSTRUCTION NOTES

  1. STRP THE TOPSOR, LEYEL THE SITE AND COMPACT THE SUBGRADE.
- COVER THE AREA WITH NEEDLE-PLANCHED GEOTEXTALE.
- CONSTRUCT A 200- THICK PAR OVER THE GEDTEXTILE USING ROAD BASE OR 30-A AGGREGATE.
- CHOURT THE STRUCTURE IS AT LEAST IS METRES LONG OR TO BUILDING ALAGMENT AND AT CEAST 3 METRES
  MOVE.
- niere a sedrent fence jous bitto the stabbised access, construct a milp by the stabbised access to divert water to the sedicent fence.

#### STABILISED SITE ACCESS (SD 6-14)

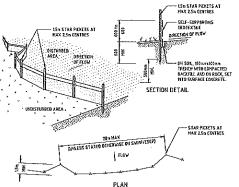

- CONSTRUCTION HOTES:

  LONSTRUCT SEPHENT FRANCE AS CLOSE AS POSSALE TO BROW PARALLE, TO THE CONTOURS OF THE SITE, BUT WITH SHALL RETURNS AS SHOWN IN THE ORANGE TO LEAT THE CALOPERT AREA OF ANY DOS. SETTION, THE CALOPERT AREA OF ANY DOS. SHALL REMOVED TO LINEAR ANY ANY DOS. SHALL REMOVED.
- 2. CUT A 150mm DEEP TRENCH ALONG THE UPSLOPE LINE OF THE FENCE FOR THE BOYTON OF THE FABRY. TO BE
- OF INSTANCE, THE COURS TAR PERETS ON IS GROWN AT 2.5 PETRE INTERVALS PIAXI AT THE CONNISCIONE EIGHT.

  ON THE TRENCH DOSDER ANY TARP PROCESS. THE FITTION WITH AREPTY CAPS.

  IN SELF-SHOPPING GEOFFICIAL TO THE UPPLOYE SOUTH THE POSTS CHINENES OF GREES TO THE BASK OF THE POSTS CHINENES FOR DECENTARIES WITH HAVE THE SOR AS RELOVEDURDE BY THE MANDARATISHER, ONLY USE COLDITATE STRUCKLAULTH PROCESSOR OF STRUCKS.

  THE PROPERTY CAPACITY PROCESSOR OF STRUCKS THE SUBJECT OF COURT COURT FOR THE SERVING THE STRUCKS.


  THE PROPERTY CAPACITY PROCESSOR OF STRUCKS THE SUBJECT OF COURT COURT FOR THE SERVING THE STRUCKS.

DESCRIPTION

1 PREI IMNARY - FOR INFORMATION


S. DON SECTIONS OF FABRIC AT A SUPPORT POST WITH A 150km OVERLAP.
 BALDIFEL THE TREYNLOWER THE BASE OF THE FABRIC AND COMPACT IT THOROUGHLY GIVEN THE GEDTEXTILE.

### SEDIMENT FENCE (SD 6-8)

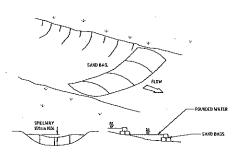

CONSTRUCTION MOTES
1. DISURE CHANCE IS GET ENOUGH TO PREVENT WATER BEING UNSAFELY DIVERTED OUT OF DRAW ONCE SAID BAGS ARE RISTALLED. NOTE: SPACING OF CHECK BAHS ALONG CENTRELIXE AND SCHOOL STORY BACH CHECK DAH TO BE SPECIFIED ON SWMP/ESCP

#### SANDBAG CHECK DAM

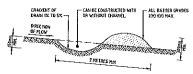


- CONSTRUCTION NOTES

  L. BULD WITH GRADIENTS BETWEEN 1 AND 5 PERCENT.
- AYOU REMOVES TREES AND SHRUBS IF POSSIBLE WORK AROUND THEM
- ENSURE THE STRUCTURES ARE FREE OF PROJECTIONS OR OTHER PREGULARITIES THAT COULD INSEDE WATER
- BULD THE DRAINS WITH CIRCULAR, PARABOLIC OR TRAPEZOIDAL CROSS SECTIONS, NOT Y SHAPED.
- S. ENSURE THE BANKS ARE PROPERLY COMPACTED TO PREVENT FAR URE.

  6. COMPLETE PERMANENT OR TEMPORARY STABLISATION WITHIN 10 DAYS OF CONSTRUCTION.

NOTE: ONLY TO BE USED AS TEMPORARY BANK WHERE MAXISHUPSTOPE LENGTHS TO HETRES.

EARTH BANK - LOW FLOW (SD 5-5)

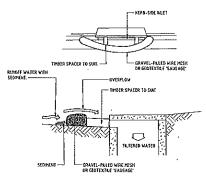

- CONSTRUCTION NOTES

  L. RISTALL FLITERS TO KERB PRIETS DRAY AT SAG PRINTS.
- 2. FABRICATE A SLEEVE HADE FROM GEOTEXTIES ON WIRE MESH LONGER THAN THE LENGTH OF THE MILET PIT AND TALL IT MITH 1500 TO SPORZE GRAVIEL. 3. FORM AND LIGHTELAL GROSS-SECTION ABOUT 15000 HIGHLY 10000 WIDE.
- PLACE THE FOLTER AT THE OPENING LEAVING AT LEAST A MOTIO SPACE BETWEEN IT AND THE KERB INLET, HAINTAIN THE OPENING WITH SPACER DLOCKS
- FORM A SEAL WITH THE KERB TO PREVENT SECRECAT BYPASSING THE FILTER.
- SANDBAGS PALED WITH DRAYEL CAN SUBSTITUTE FOR THE MESH OR GEOLECTILE PROVIDING THEY ARE PLACED SO THAT THEY FRINLY ABUT EACH OTHER AND SEDMENT-LADEN WATERS CANNOT PASS BETWEEN

MESH AND GRAVEL INLET FILTER (SD 6-11)



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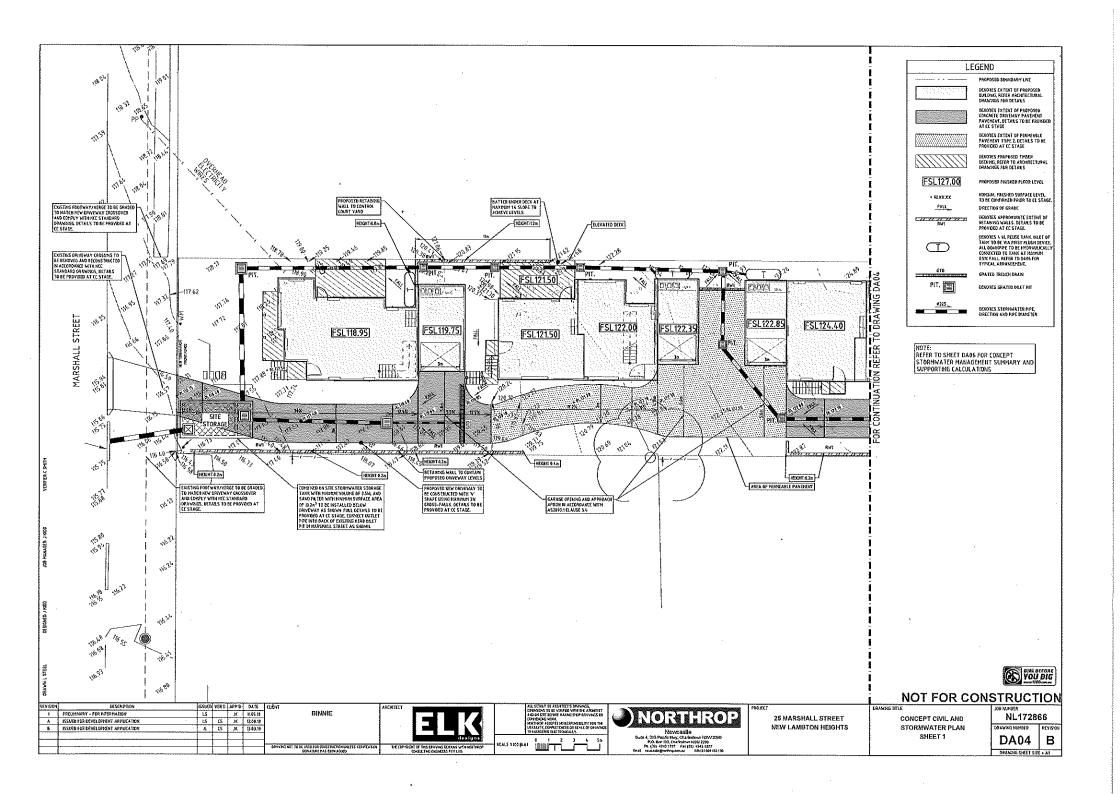


25 MARSHALL STREET **NEW LAMSTON REIGHTS** 

CONCEPT FROSION AND SEDIMENT CONTROL DETAILS


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NOTE: REFER TO SHEET DAGG FOR CONCEPT STORMWATER MANAGEMENT SUMMARY AND SUPPORTING CALCULATIONS





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25 MARSHALL STREET NEW LAMBYON HEIGHTS GRAVAG TITLE


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STORMWATER PLAN

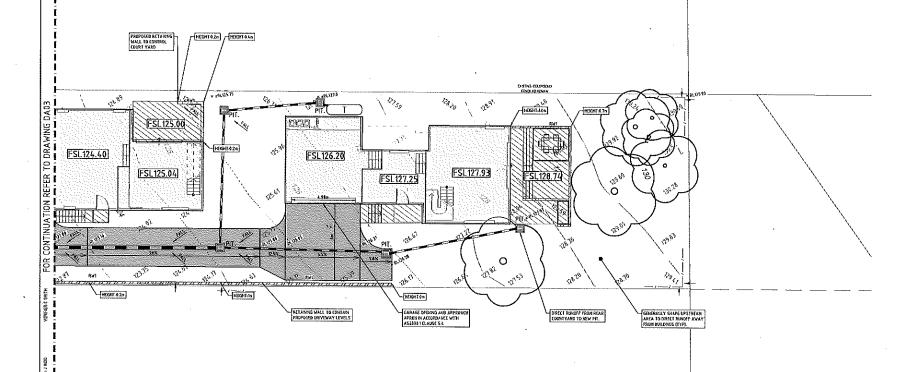
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SITE STORAGE AND DISCHARGE TANK



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25 MARSHALL STREET **NEW LAMBTON HEIGHTS** 

TYPICAL DETAILS AND STORMWATER SUMMARY
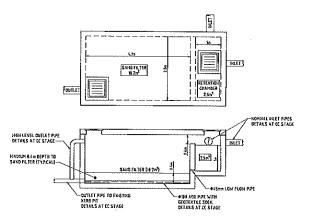
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#### CONCEPT STORMWATER MANAGEMENT SUMMARY

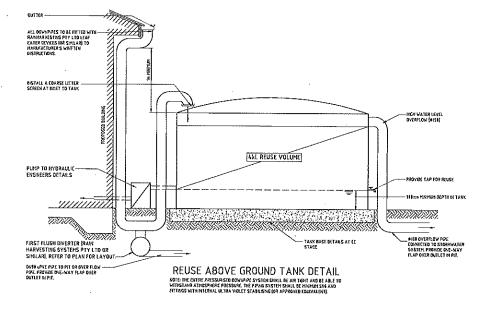LGA: NEWCASTLE CITY COUNCY, INCC.

northog cousu, timb endiners have prepared a cincept stormyater dramage describe the proposed resolution. Beylcopphilt at 13 habital, street, now langton regains. The proposed stormyater namaginal fluxs have been duclored in accordance with the NCC 2010 does, section 3 of arm the MCC 2015 Stormyater and water epigency clopkers, mannal, in accordance with the NCC 2010 does, section 3 of arm the MCC 2015 Stormyater and water epigency clopkers, mannal, in accordance with the NCC 2010 does.

THE DOSTING LOT HAS AN APPROXIMATE TOTAL AREA OF 1492 M2 AND CURRENTLY CONTAINS A SONCE RESPONDED COMPLISM, OFF-STREET CAR PARGON, INFERTOR CAREET THAN SO A WISTERY ASSECT THAT GRADES TOWARDS AND ASSECT THAT GRADES TOWARD ASSECT THAT AS A PROPERTY OF A MATERIAL STREET. THE PROPERTY DEST'S A MEDIT OFF A MATERIAL STREET, THE PROPERTY DEST'S AND ASSECT THAT WALL PROPERTY DEST'S AND ASSECT THAT ASSECT TH

- PERMEABLE PAYING WALL BE INCORPORATED BYTO A PORTION OF THE PROPOSED DRIVEWAY. ALL PERMEABLE PAYEMENT HAS BEEN
  ASSUMED TO BE PERVIOUS IN ACCORDANCE WITH INCE 2012 DEP, SECTION 781.
- . PROVISION OF A CKL RAIN WATER TANK FOR EACH OWELLING
- PROVISION OF A SAND FILTER TO TREAT STORMWATER RUNOFF CAPTURED FROM THE DRIVEWAY PAVERENT

IT IS landerstood the existing divelling wal be demolished to make way for the proposed units and driveway. For the purpose of the below calculations, the existing site has been adopted as been hatural state with no parryous areas.

#### 1. STORAGE REQUIREMENTS

. TOTAL SITE ASEA = 1.492m2 TOTAL ROOF AREA ~ 535 n² . PAVED PIPERYDUS AREA = 2105<sup>2</sup> TOTAL PERVIOUS AREA
 LANGSCAPED AREA 2 74 613<sup>2</sup> 2 6270<sup>2</sup> PER PER ARIE PAVNG = 110m2 PERCENTAGE DEPERVIOUS. = 50%

PACCESSABLE WITH THE MCC 2012 DCP, SECTION 2.06 ISTORYWATER), FIGURE 1, A MARKUM OF 12 MININGAL OF RANGALL IS TO BE CAPTURED FROM THE STIESS OPERVIOUS AREA TO MAKAGE PEAK RUNGEF.

TOYAL SITE STORAGE REQUIREMENT = 12ma/m² x 146m² = 9.0 KL

#### 2. ONSITE HARVESTING/REUSE

#### 3. STORMWATER QUALITY

ALTHOUGH THE PROPOSED REUSE VOLUME EXCEEDS THE SITE STORAGE REQUIREMENT, ADDITIONAL TREATMENT WAL BE REQUIRED FOR THE DRIVEWAY DEPENDING AREAS.

a samb fater has been proposed to poash bixoff from the paved saface areas of the dyvicophont. This system has been solid by accordance with section 4.3 of the rics terdocal parada, and consults an approximate 2000<sup>2</sup> that insection concepts the samb expect accordance to the concepts of the samb expect.

RETENTION CHANGER VOLUME SAKO FR TER AREA ([1275/100] X 0.8H<sup>2</sup>] v 10.26<sup>3</sup>

#### 4. SITE DISCHARGE

THE PROPOSED STORMWATER RETWORK FOR THE DEVILOPMENT WAL CONNECT INTO COUNCES EXISTING STORMWATER KERR INLET PIT LOCATED IN MARSHALL STREET, THE INVERT OF THE EXISTING STORMWATER PIPE IS AT APPROXIMATELY RETRIED TO BE COMPRISED CO.

# **DEVELOPMENT APPLICATIONS COMMITTEE MEETING**

9 April 2019

# ATTACHMENTS DISTRIBUTED UNDER SEPARATE COVER

# **REPORTS BY COUNCIL OFFICERS**


Attachment A - Plans DA2017/00629 - 52 Parker Street & 9 Everett Street


Carrington


Alterations and additions to existing industrial buildings, erection of associated weigh bridge, siteworks and rail spur to be used as a freight


transport facility

**DISTRIBUTED UNDER SEPARATE COVER** 

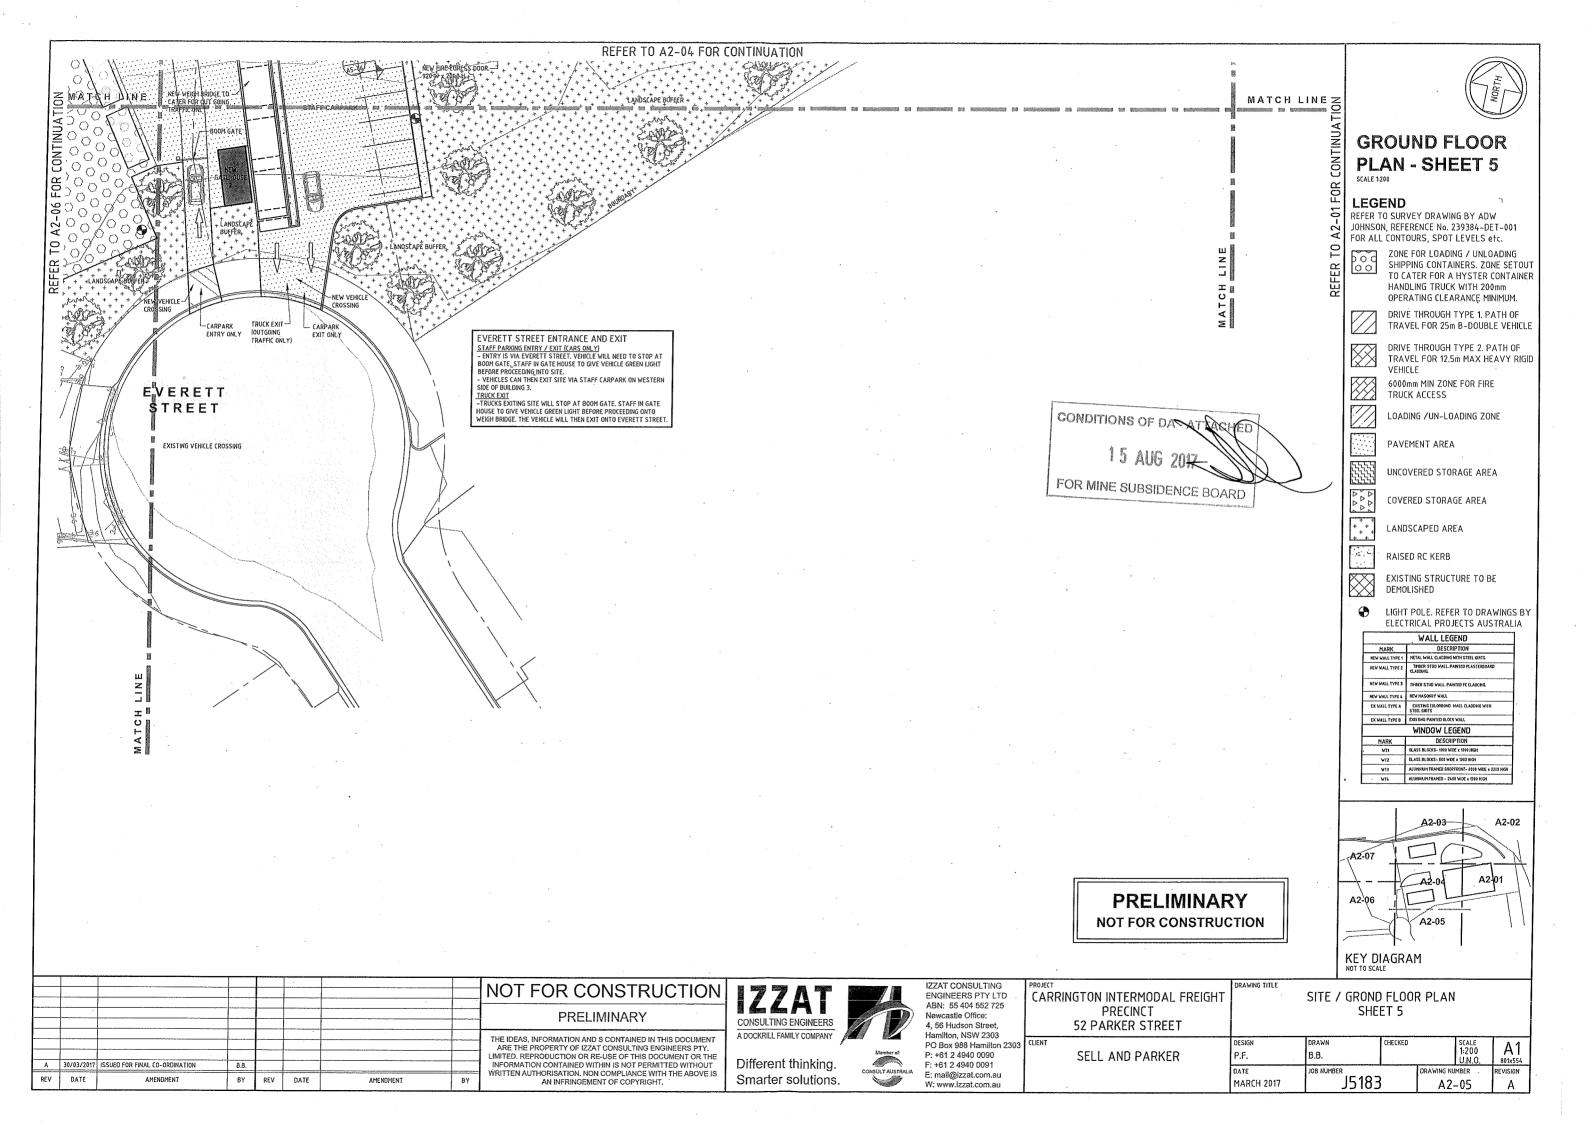

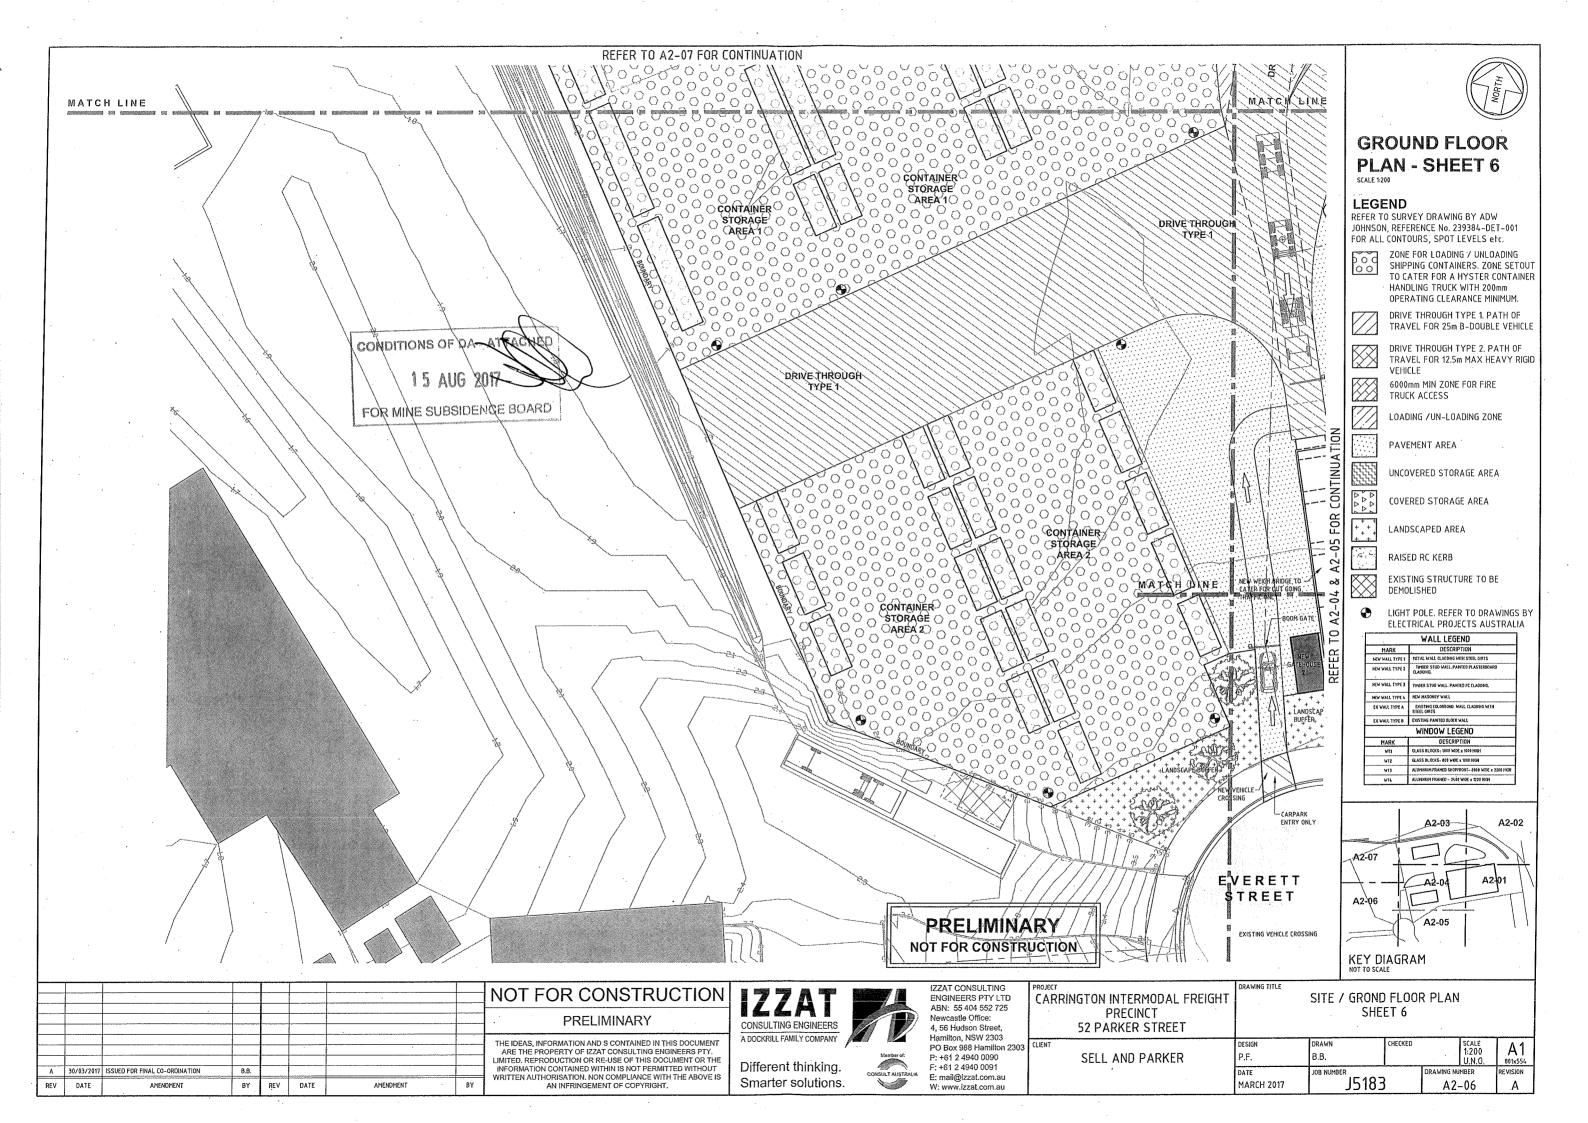

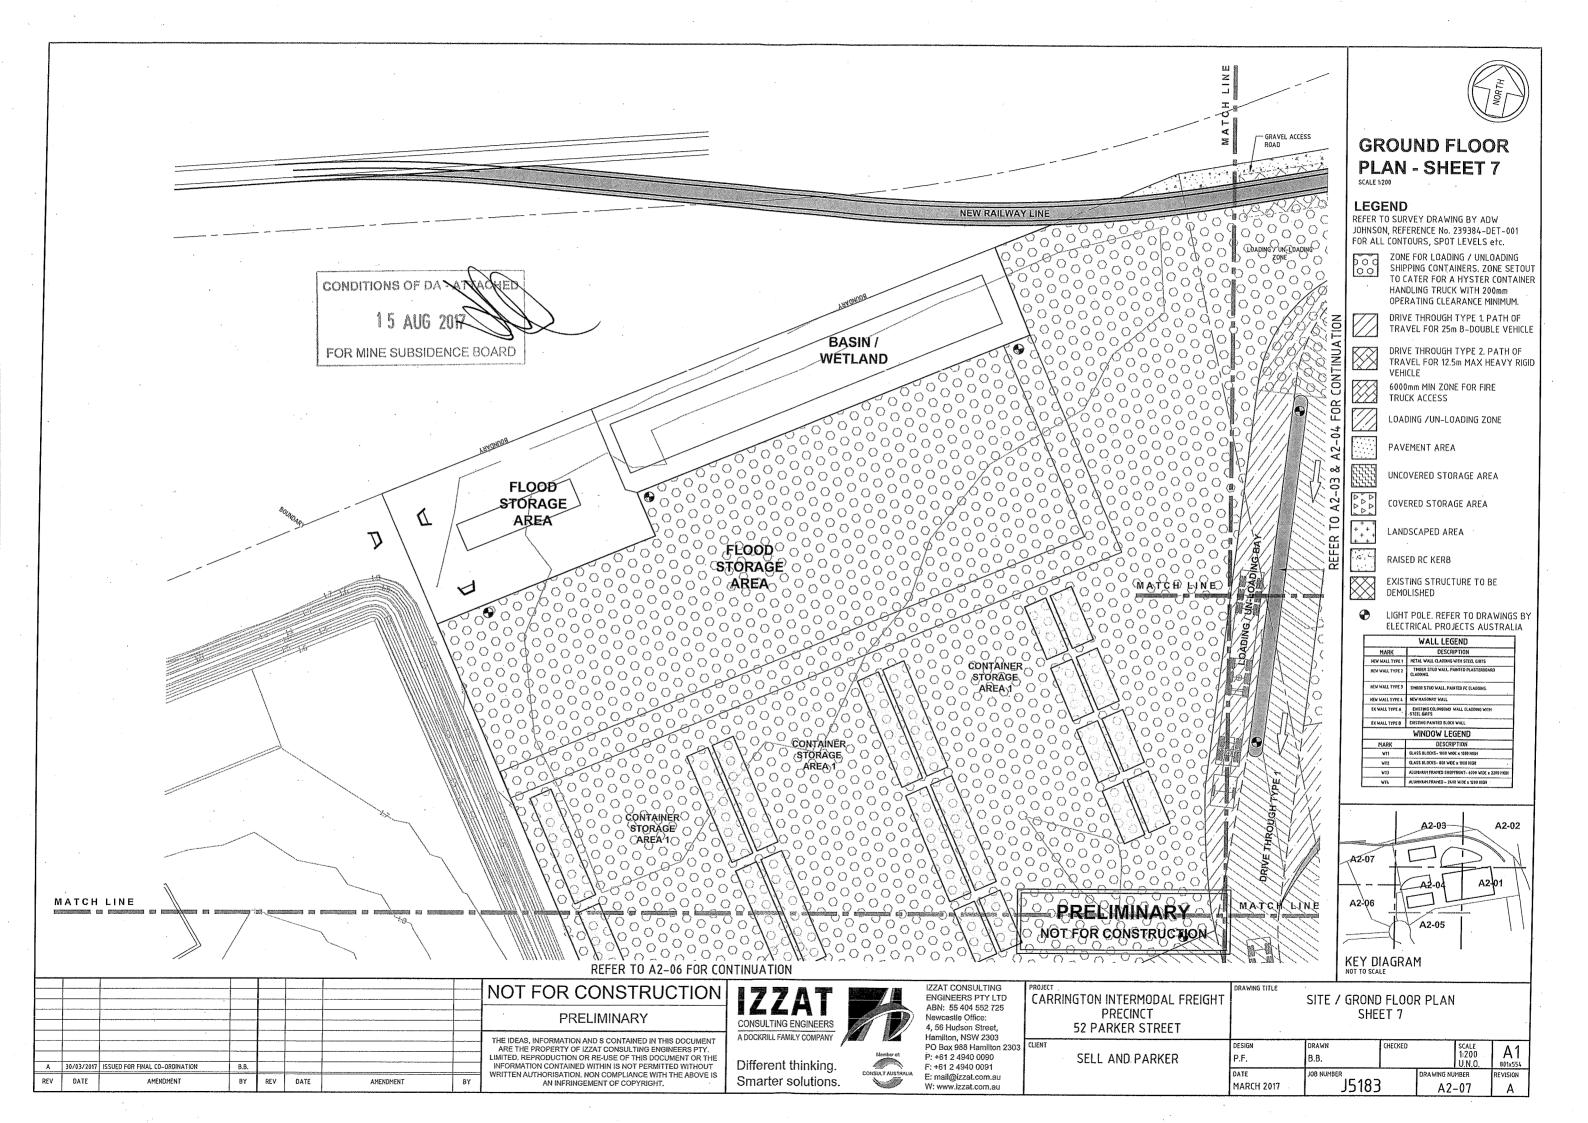

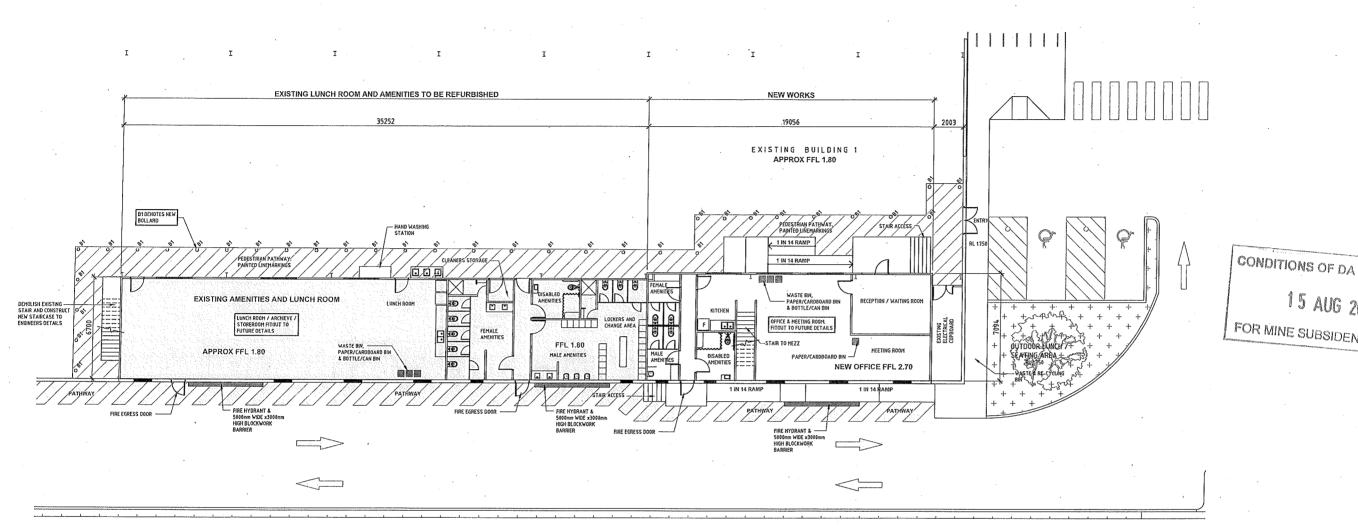

CONDITIONS OF DA 15 AUG 201 FOR MINE SUBSIDENCE BOARD



OFFICE AND LUNCH ROOM PLAN (BUILDING 1)

# **PRELIMINARY** NOT FOR CONSTRUCTION

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A	20/12/2016	ISSUED FOR PRE-DA DISCUSSION	8.8.					THE INFORMATION CONTAINED WITHIN IS NOT PERMITTED WITHOUT
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CTION CONSULTING ENGINEERS.

Different thinking.

Smarter solutions.




IZZAT CONSULTING ENGINEERS PTY LTD ABN: 55 404 552 725 Newcastle Office: 4, 56 Hudson Street, Hamilton, NSW 2303 PO Box 988 Hamilton 2303 P: +61 2 4940 0090 F: +61 2 4940 0091 E: mail@izzat.com.au W: www.izzat.com.au

PROJECT
CARRINGTON INTERMODAL FREIGHT
PRECINCT
52 PARKER STREET

**BUILDING 1 OFFICE** AND AMENITIES PLANS

SELL AND PARKER

						l
ESIGN P.F.	DRAWN B.B.	CHECKED	- 1	SCALE 1:125 U.N.O.	A1 801x554	
ATE 1ARCH 2017	JOB NUMBER	83	DRAWING NUM		REVISION	

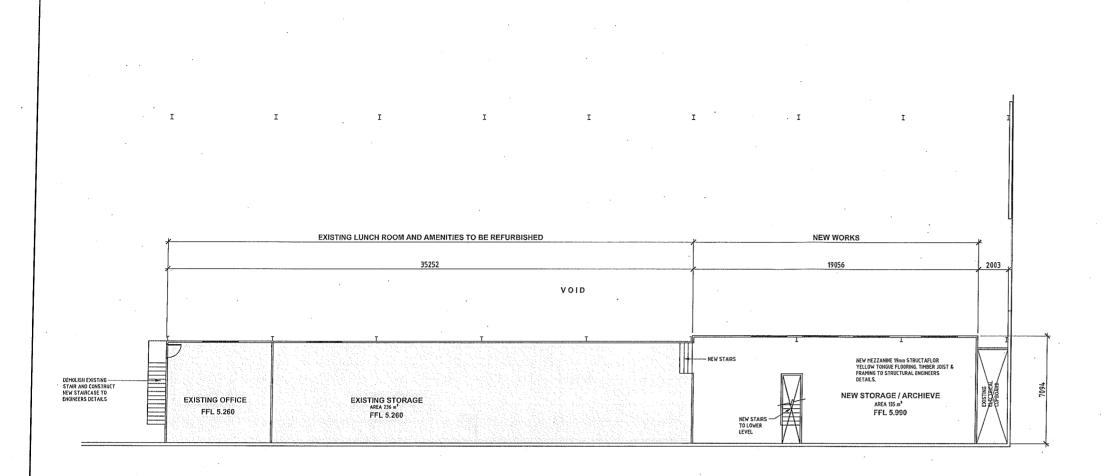

CONDITIONS OF DA - A FOR MINE SUBSIDENCE BOARD



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CONSULTING ENGINEERS A DOCKRILL FAMILY COMPANY

Smarter solutions.




IZZAT CONSULTING ENGINEERS PTY LTD ABN: 55 404 552 725 Newcastle Office: 4, 56 Hudson Street, 4, 56 Hudson Street, Hamilton, NSW 2303 PO Box 988 Hamilton 2303 P: +61 2 4940 0090 F: +61 2 4940 0091 E: mail@izzat.com.au W: www.izzat.com.au


CARRINGTON INTERMODAL FREIGHT PRECINCT 52 PARKER STREET


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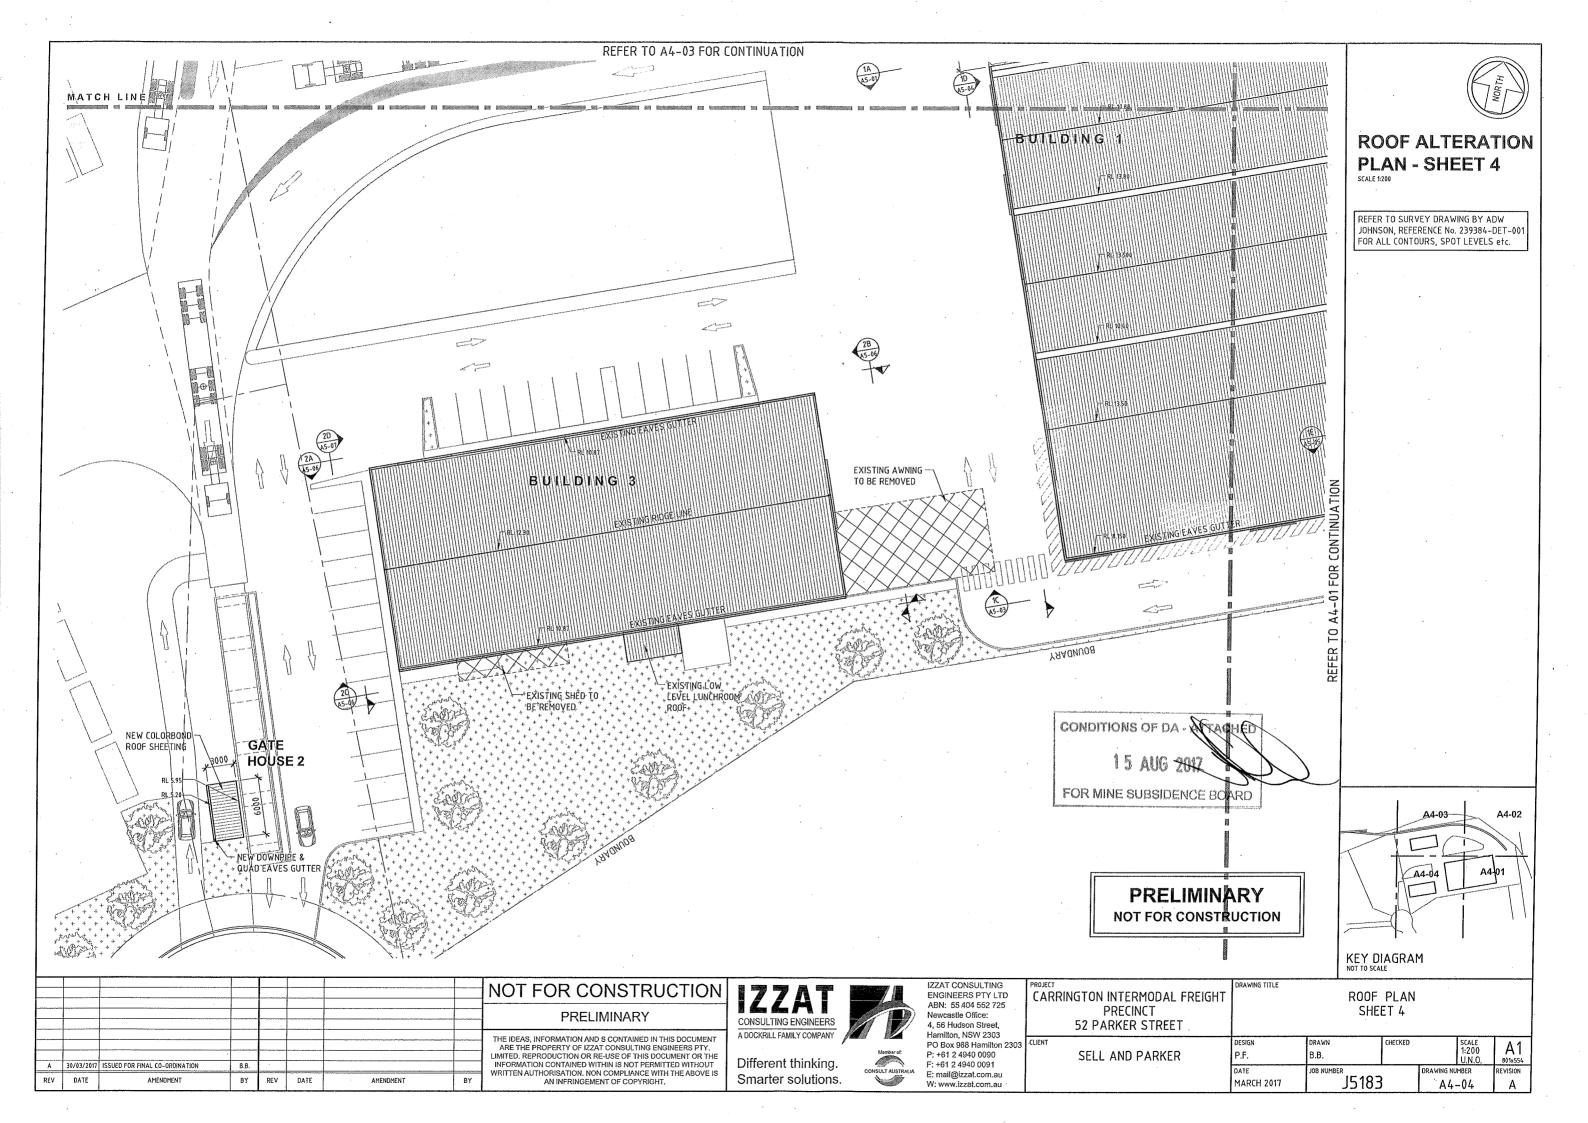
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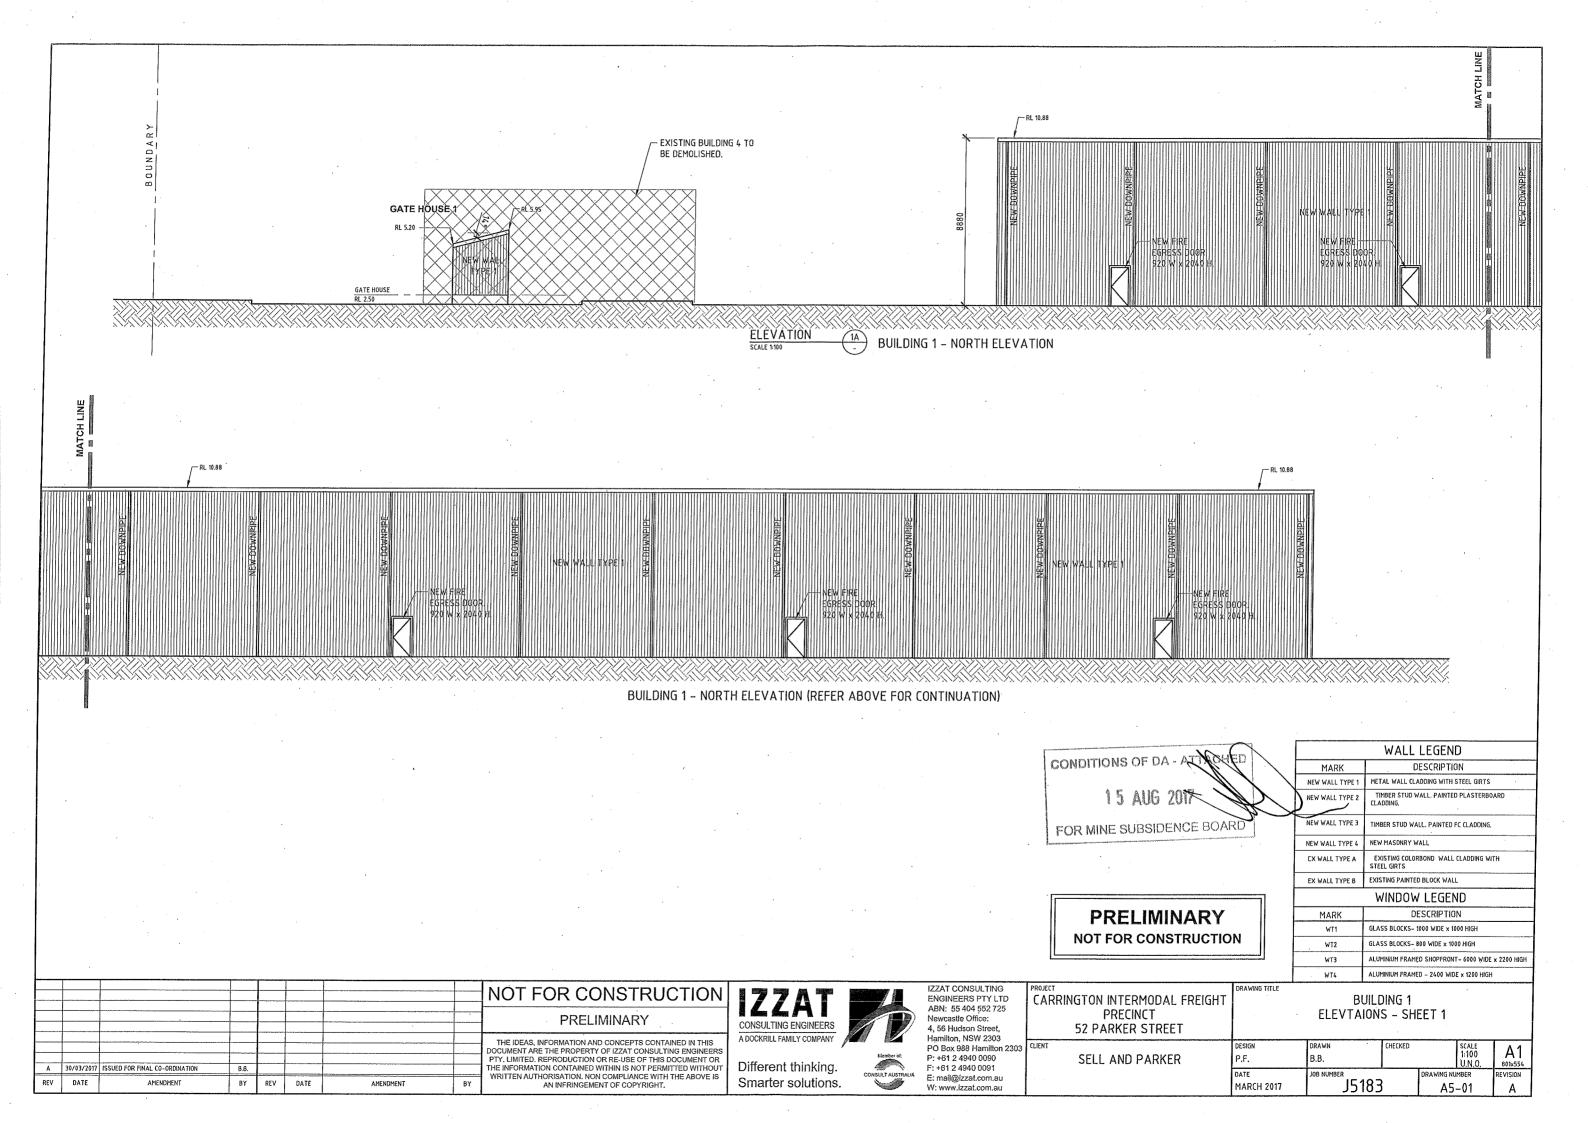
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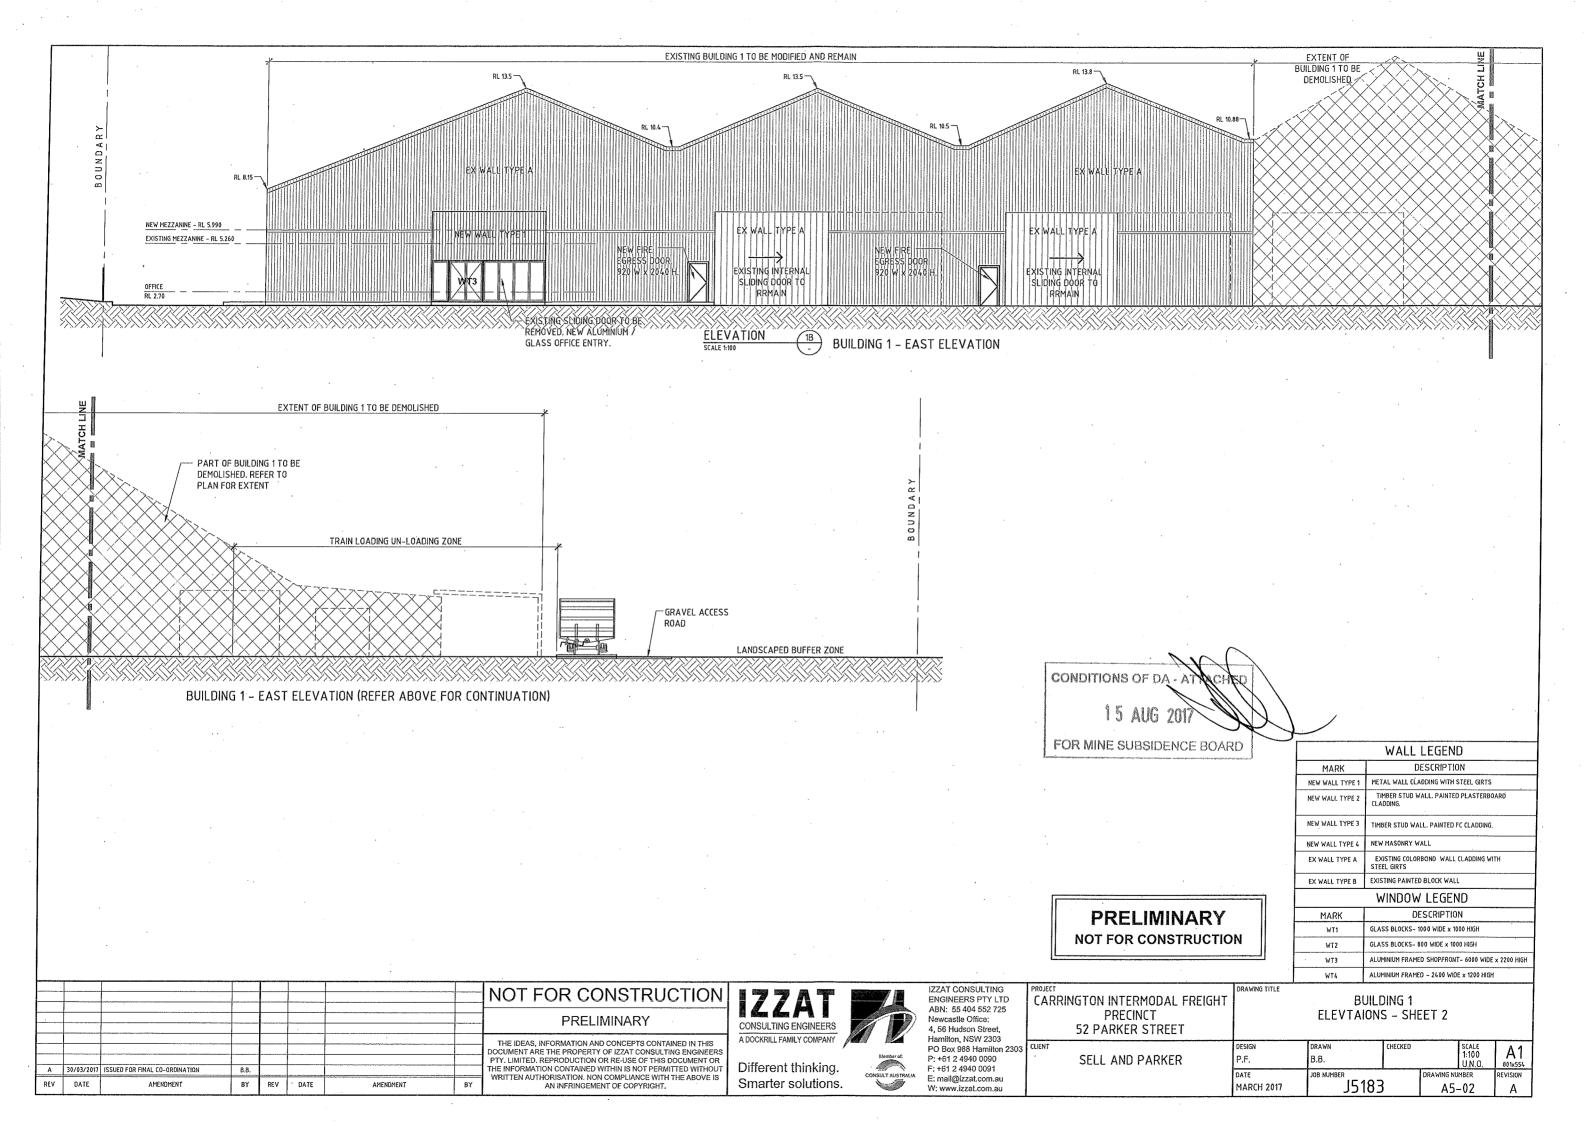








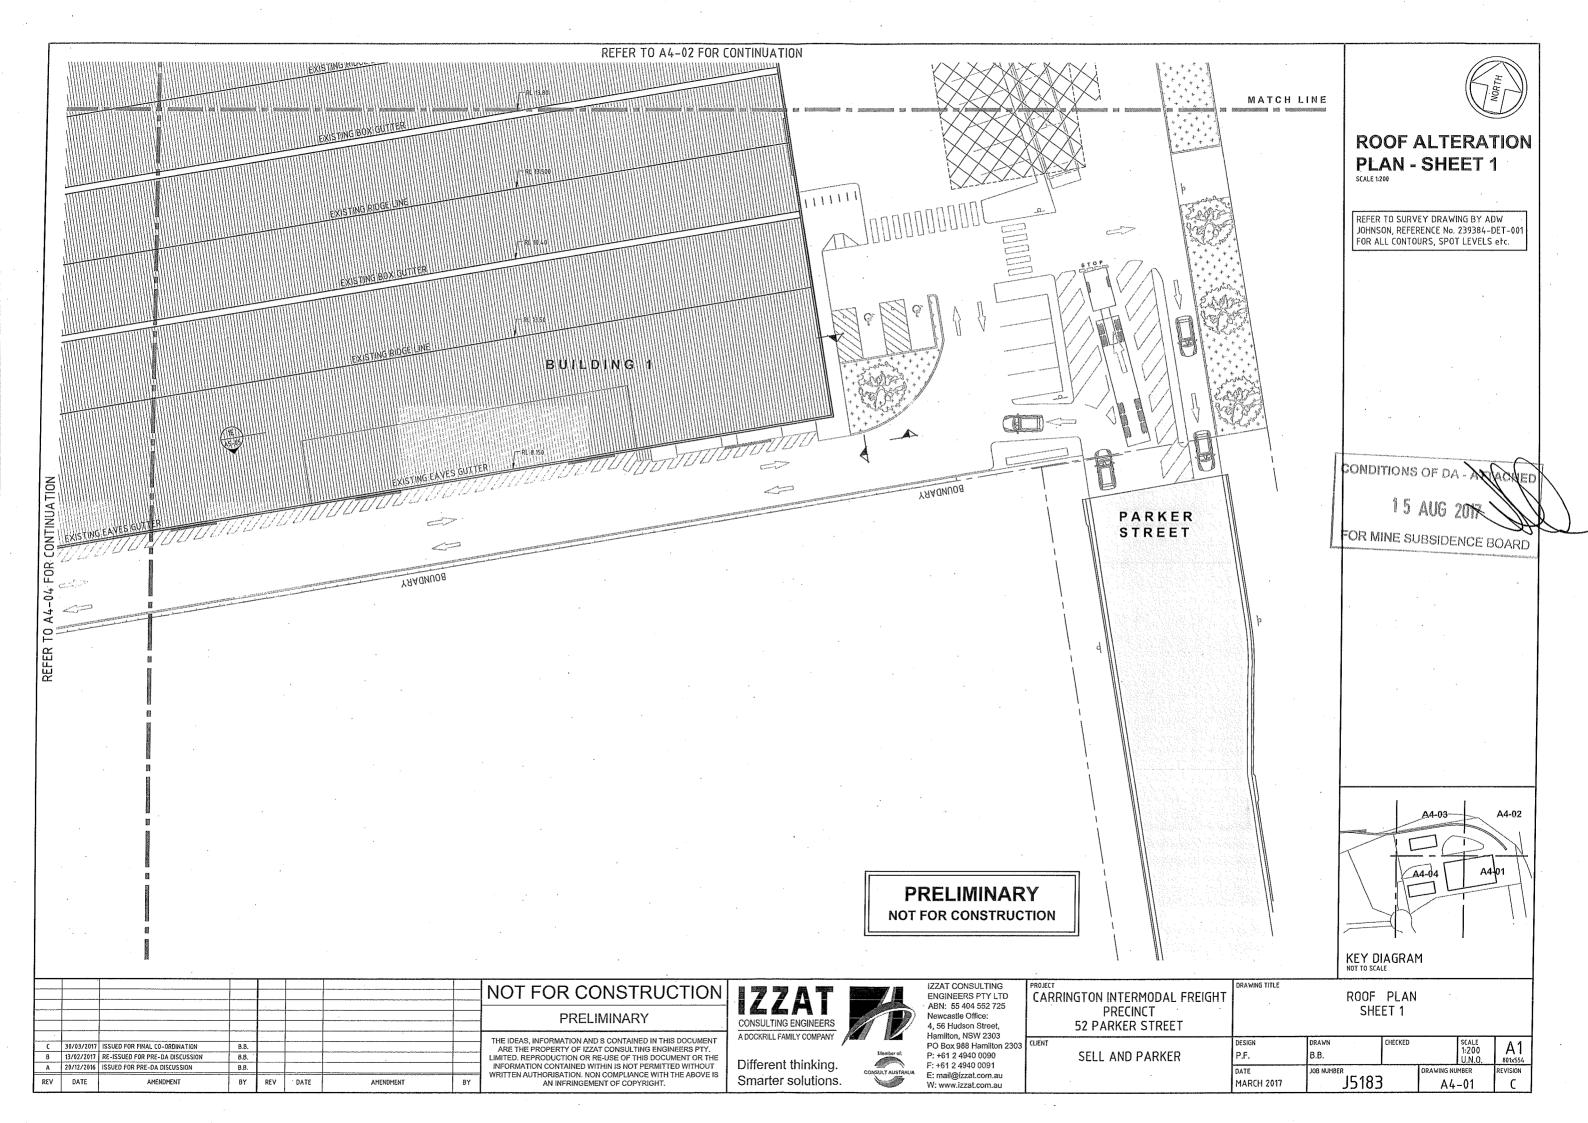


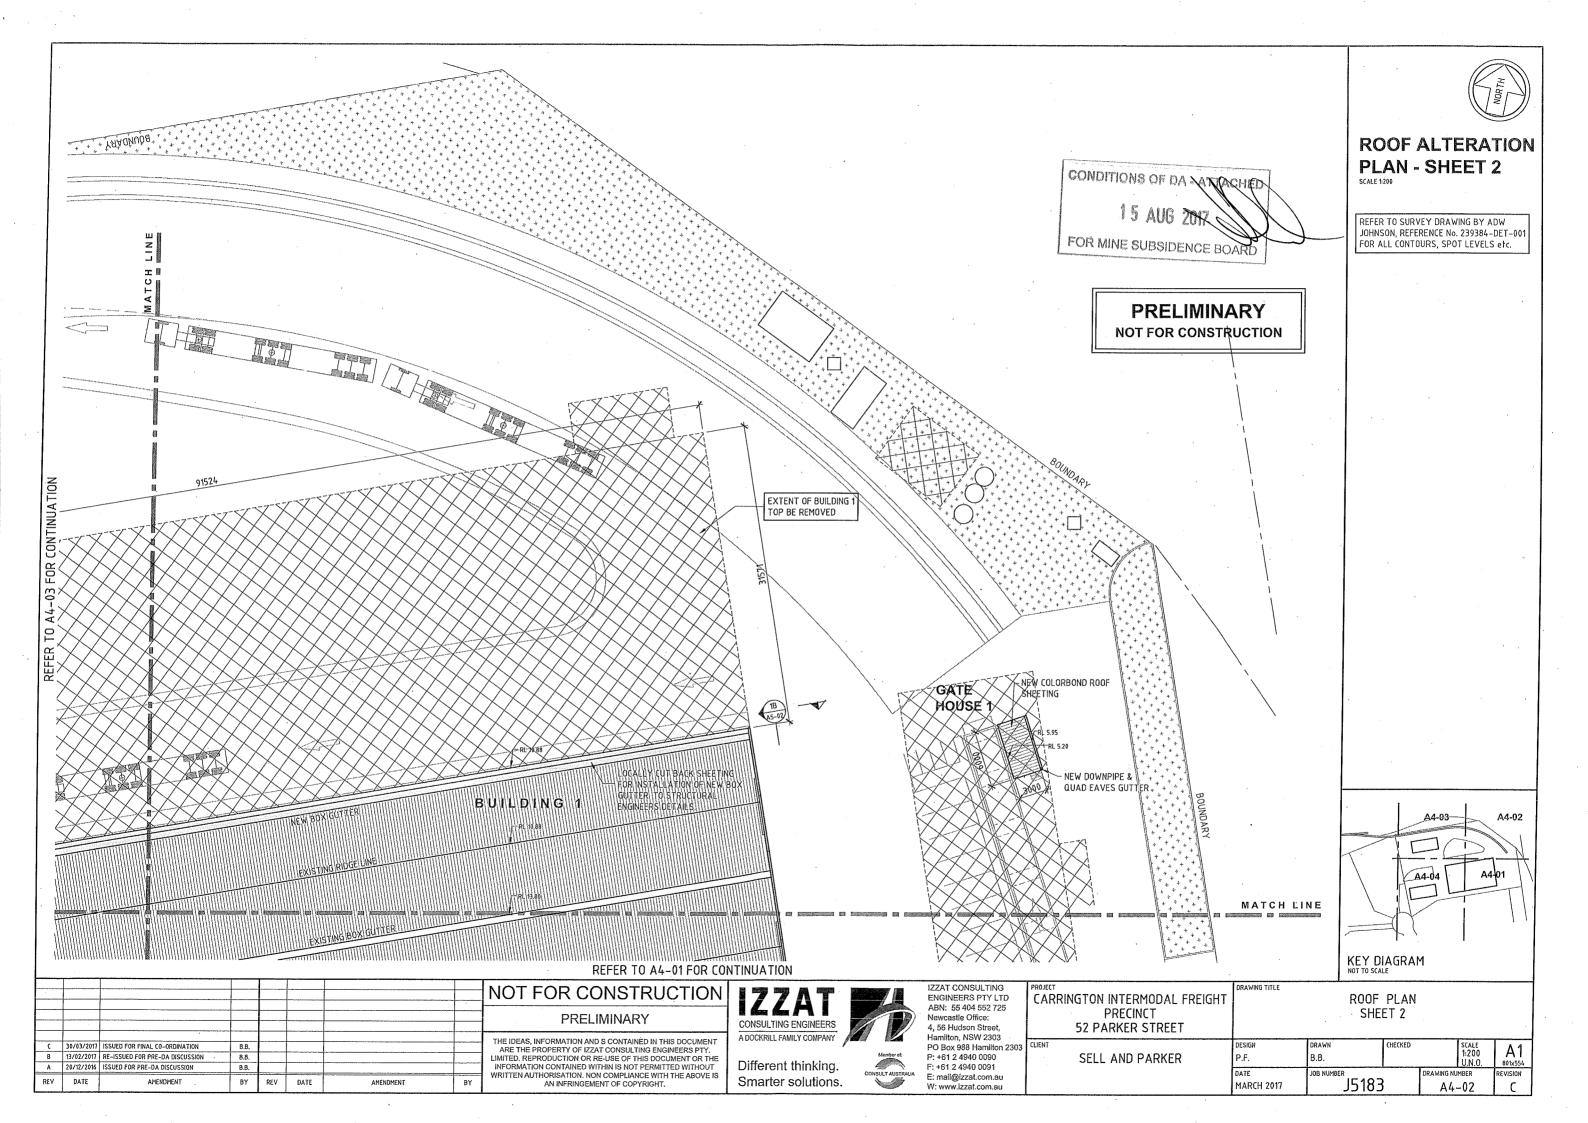

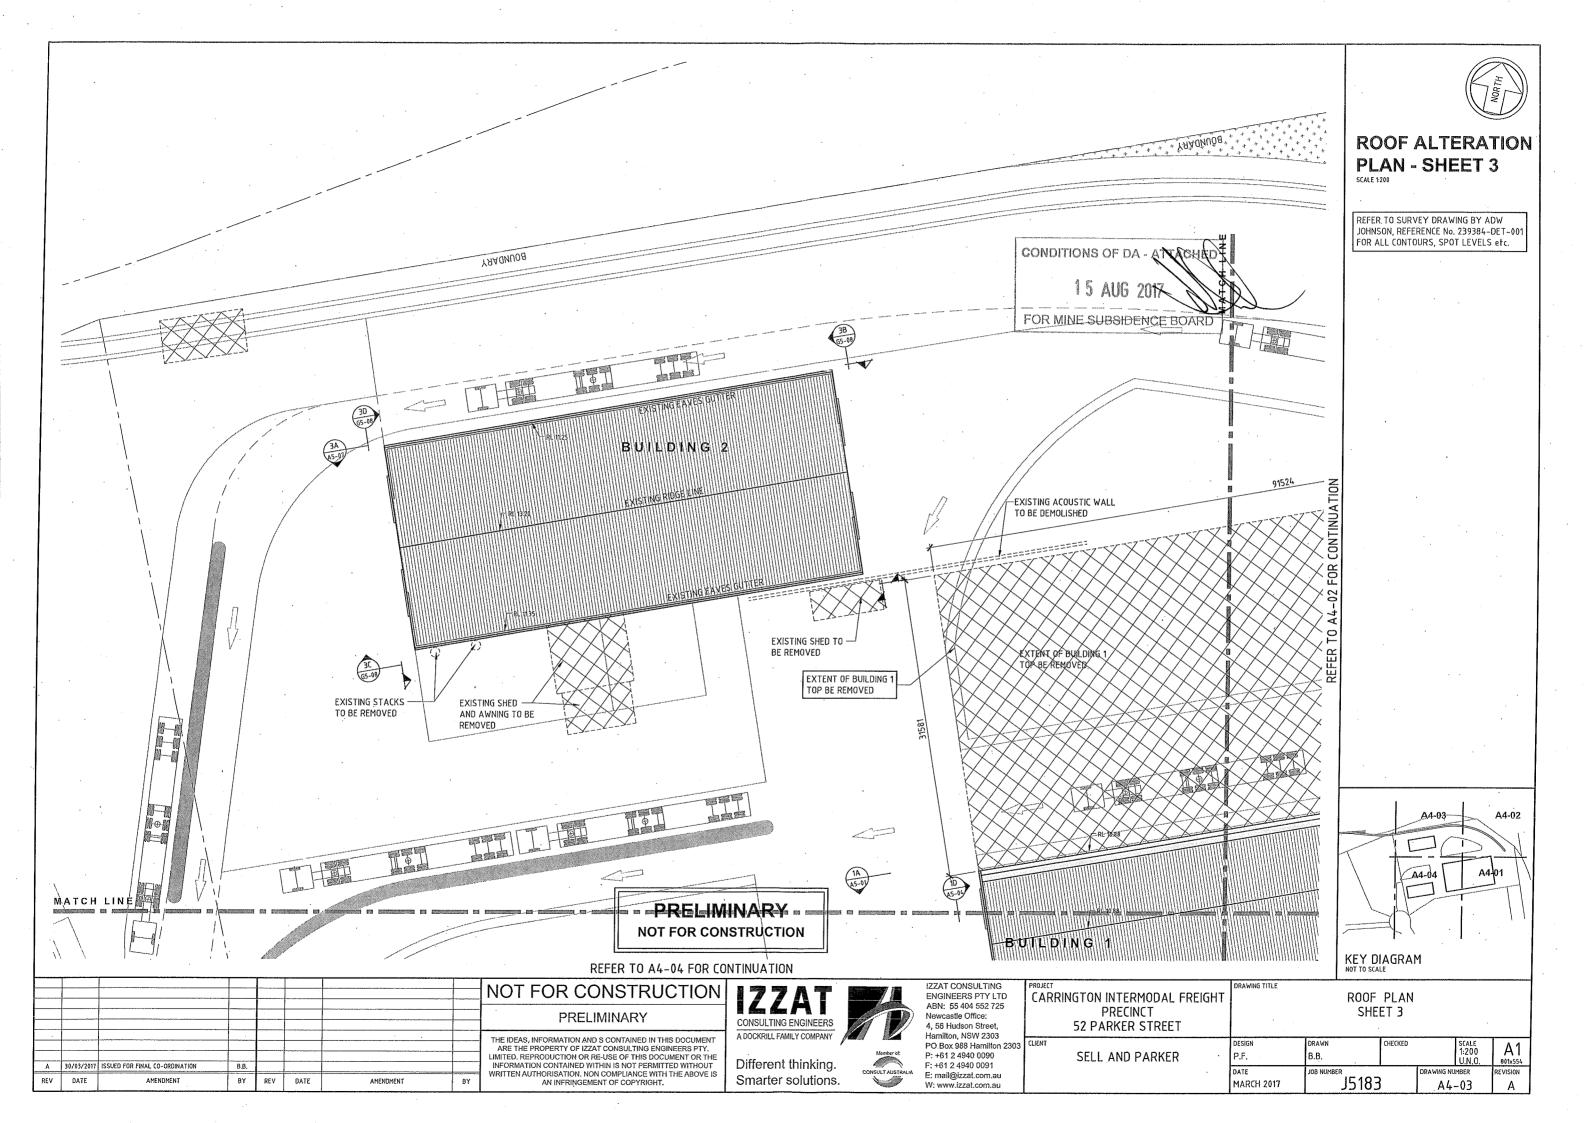

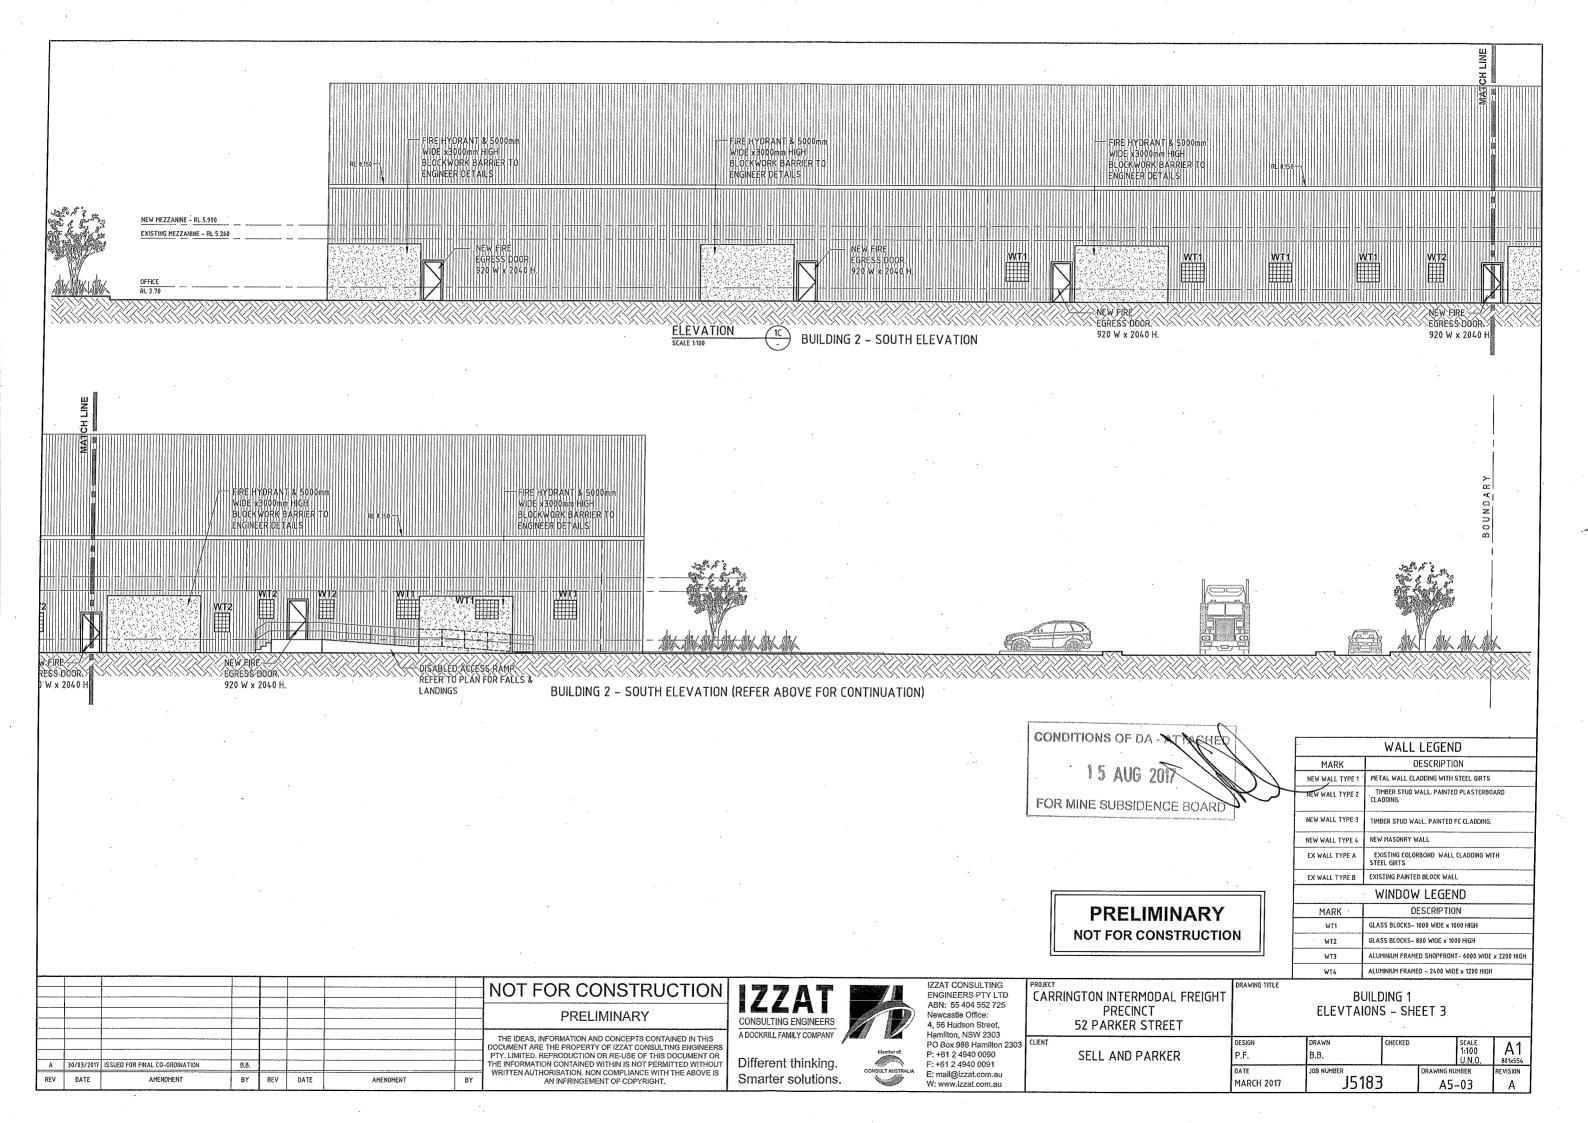

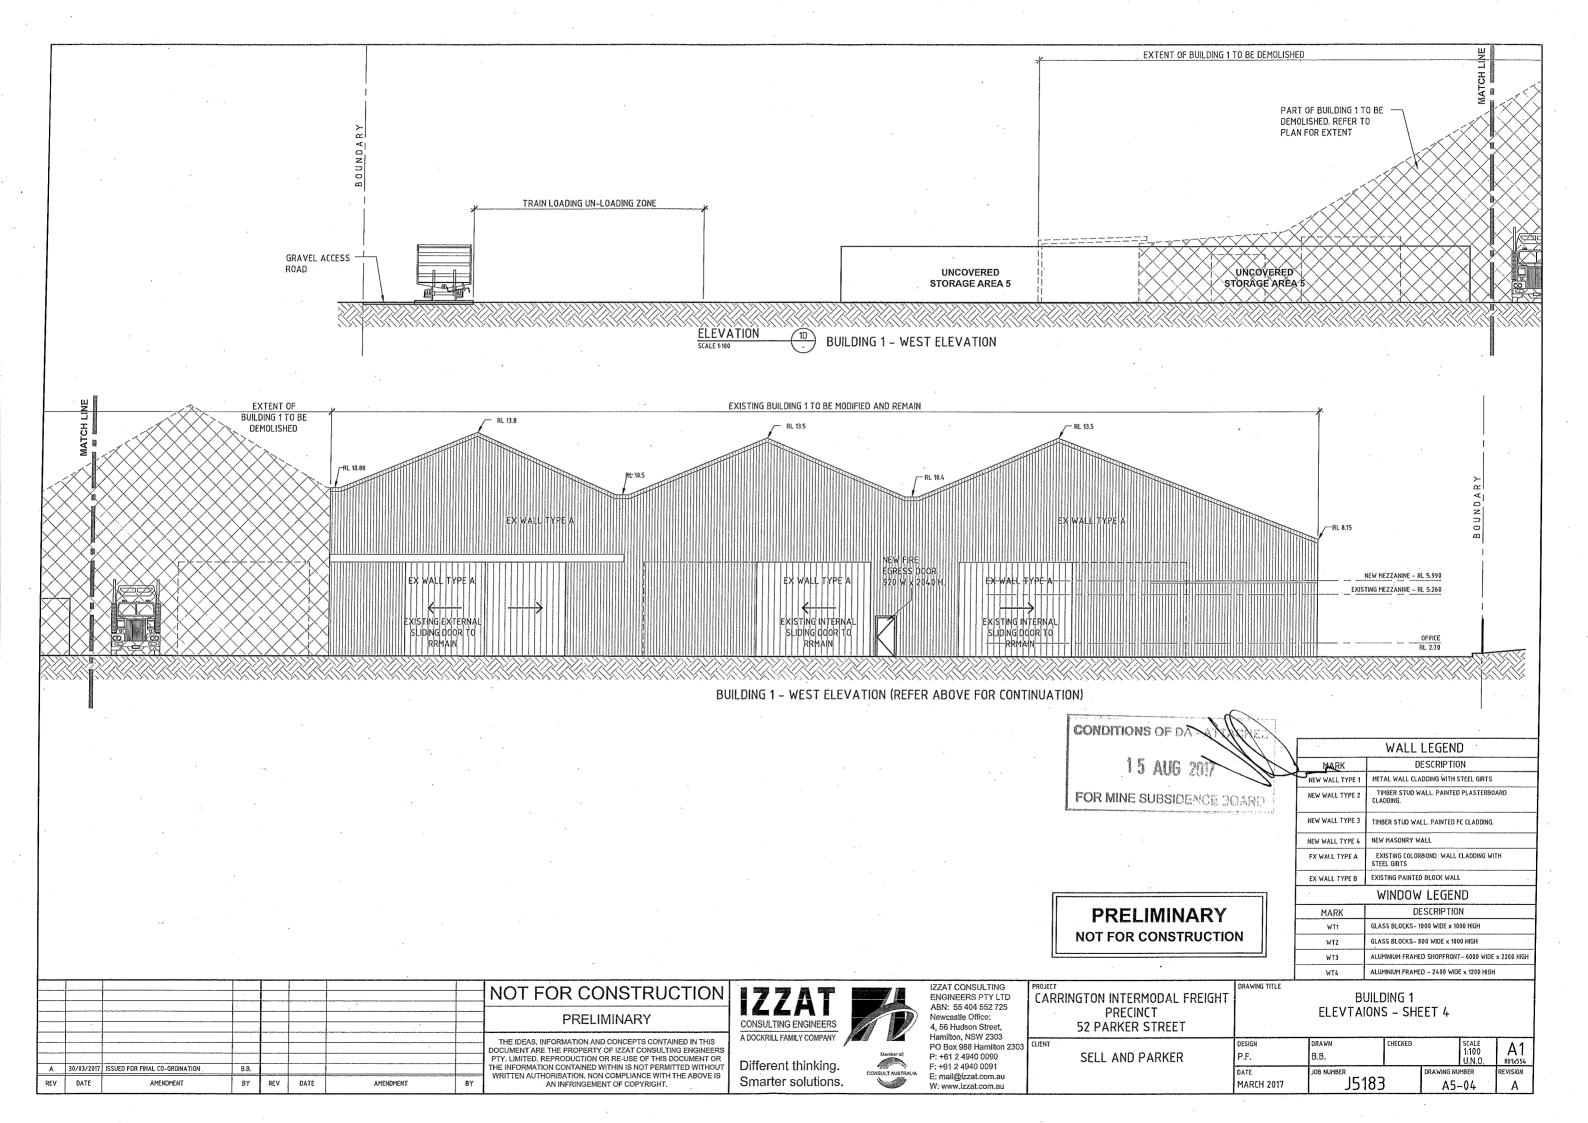

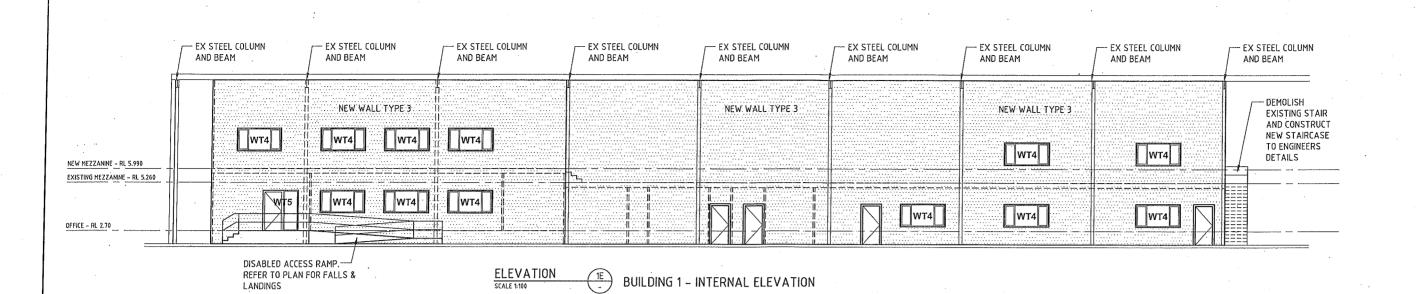

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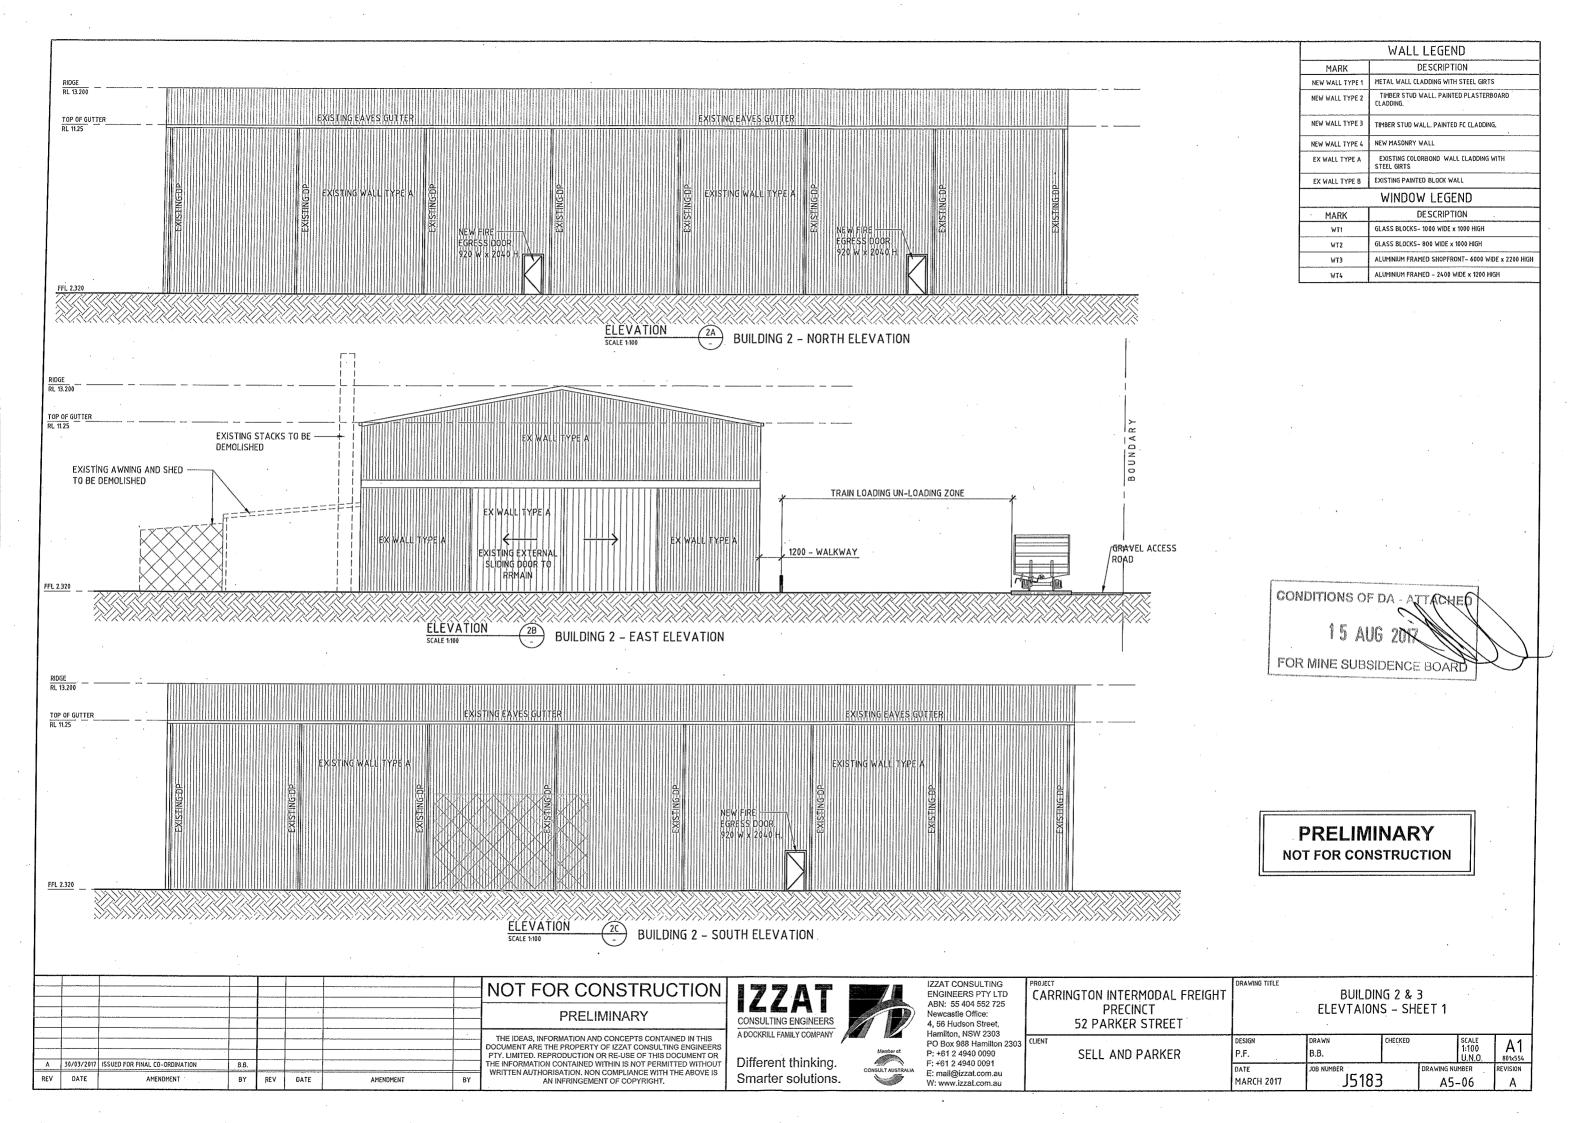
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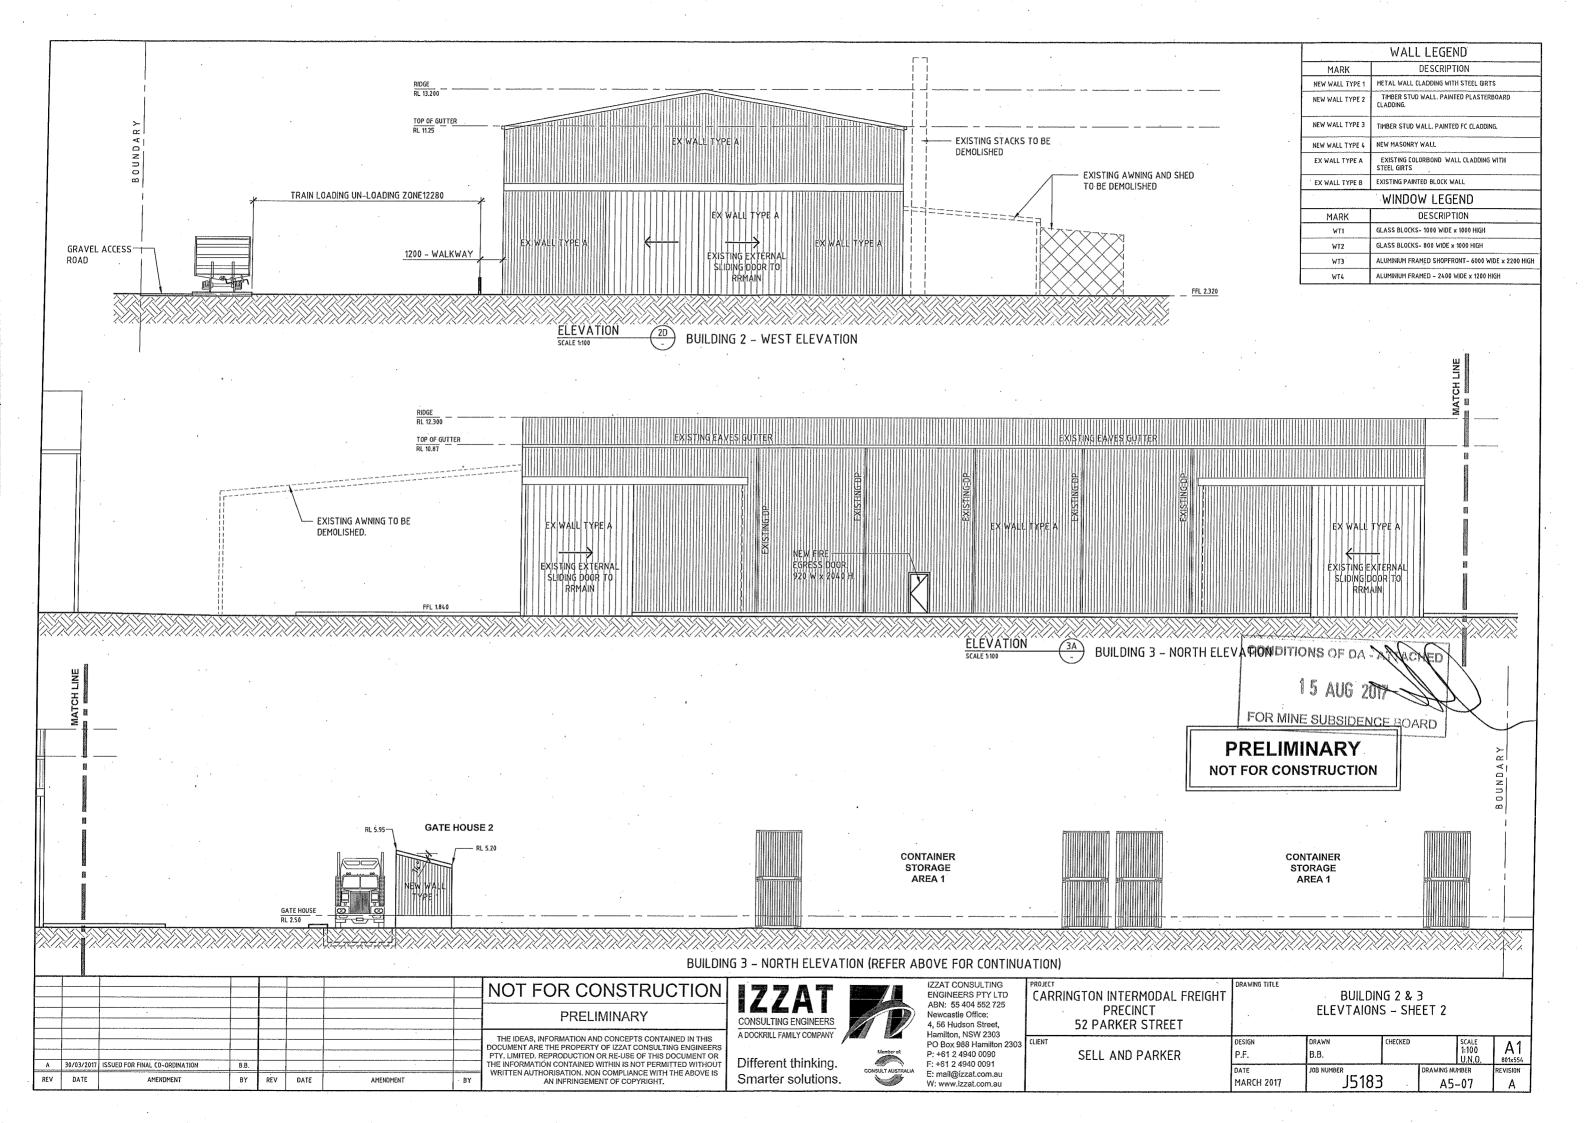
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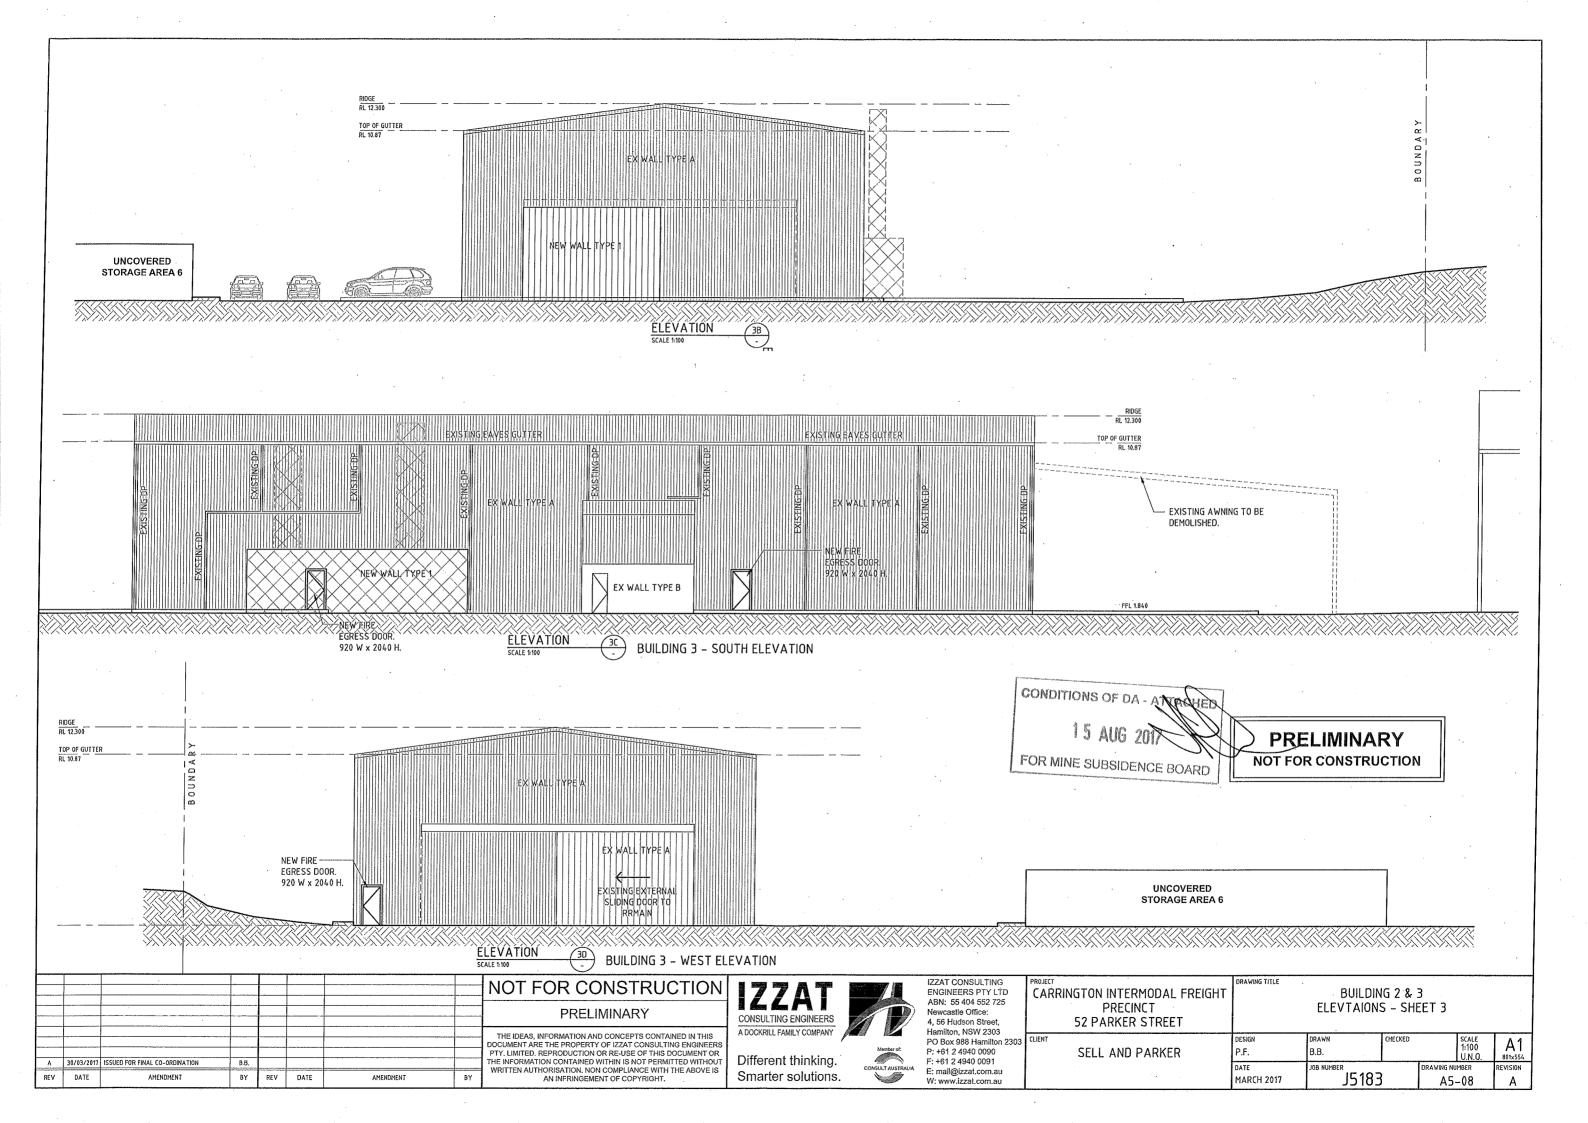
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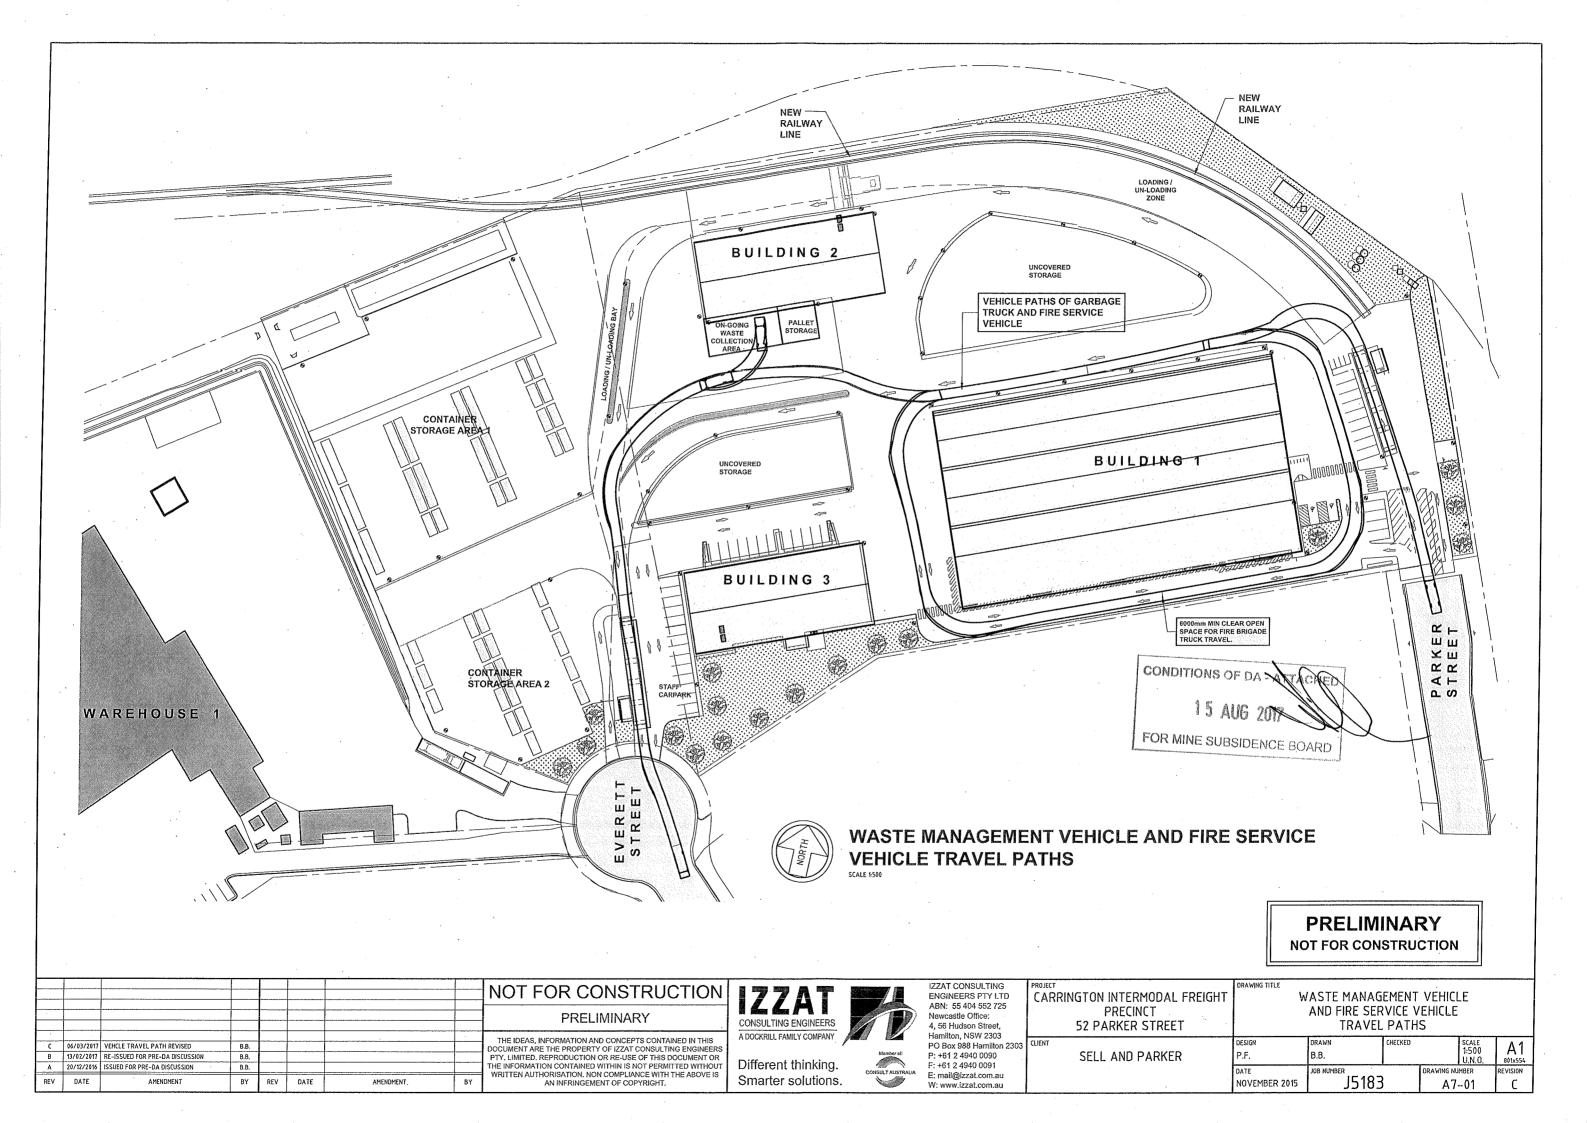
	WALL LEGEND
MARK	DESCRIPTION
NEW WALL TYPE 1	METAL WALL CLADDING WITH STEEL GIRTS
.NEW WALL TYPE 2	TIMBER STUD WALL. PAINTED PLASTERBOARD CLADDING.
NEW WALL TYPE 3	TIMBER STUD WALL. PAINTED FC CLADDING.
NEW WALL TYPE 4	NEW MASONRY WALL
EX WALL TYPE A	EXISTING COLORBOND WALL CLADDING WITH STEEL GIRTS
EX WALL TYPE B	EXISTING PAINTED BLOCK WALL
	WINDOW LEGEND
MARK	DESCRIPTION
WT1	GLASS BLOCKS~ 1000 WIDE x 1000 HIGH
WT2	GLASS BLOCKS- 800 WIDE x 1000 HIGH
WT3	ALUMINIUM FRAMED SHOPFRONT- 6000 WIDE x 2200 HIGH
WT/	ALUMINIUM FRAMED - 2400 WIDE x 1200 HIGH


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								PRELIMINARY	CONSULTING ENGINEERS		ABN: 55 404 552 725 Newcastle Office: 4, 56 Hudson Street,	PRECINCT 52 PARKER STREET		ELEVTAIC	ONS - SHEET 5	
						•		DOCUMENT ARE THE PROPERTY OF IZZAT CONSULTING ENGINEERS PTY. LIMITED. REPRODUCTION OR RE-USE OF THIS DOCUMENT OR	A DOCKRILL FAMILY COMPANY  Different thinking.	Member of:	Hamilton, NSW 2303 PO Box 988 Hamilton 2303 P: +61 2 4940 0090		DESIGN P.F.	DRAWN B.B.	CHECKED SCALI 1:10 U.N.	LE 00 A1 4.0. 801x554
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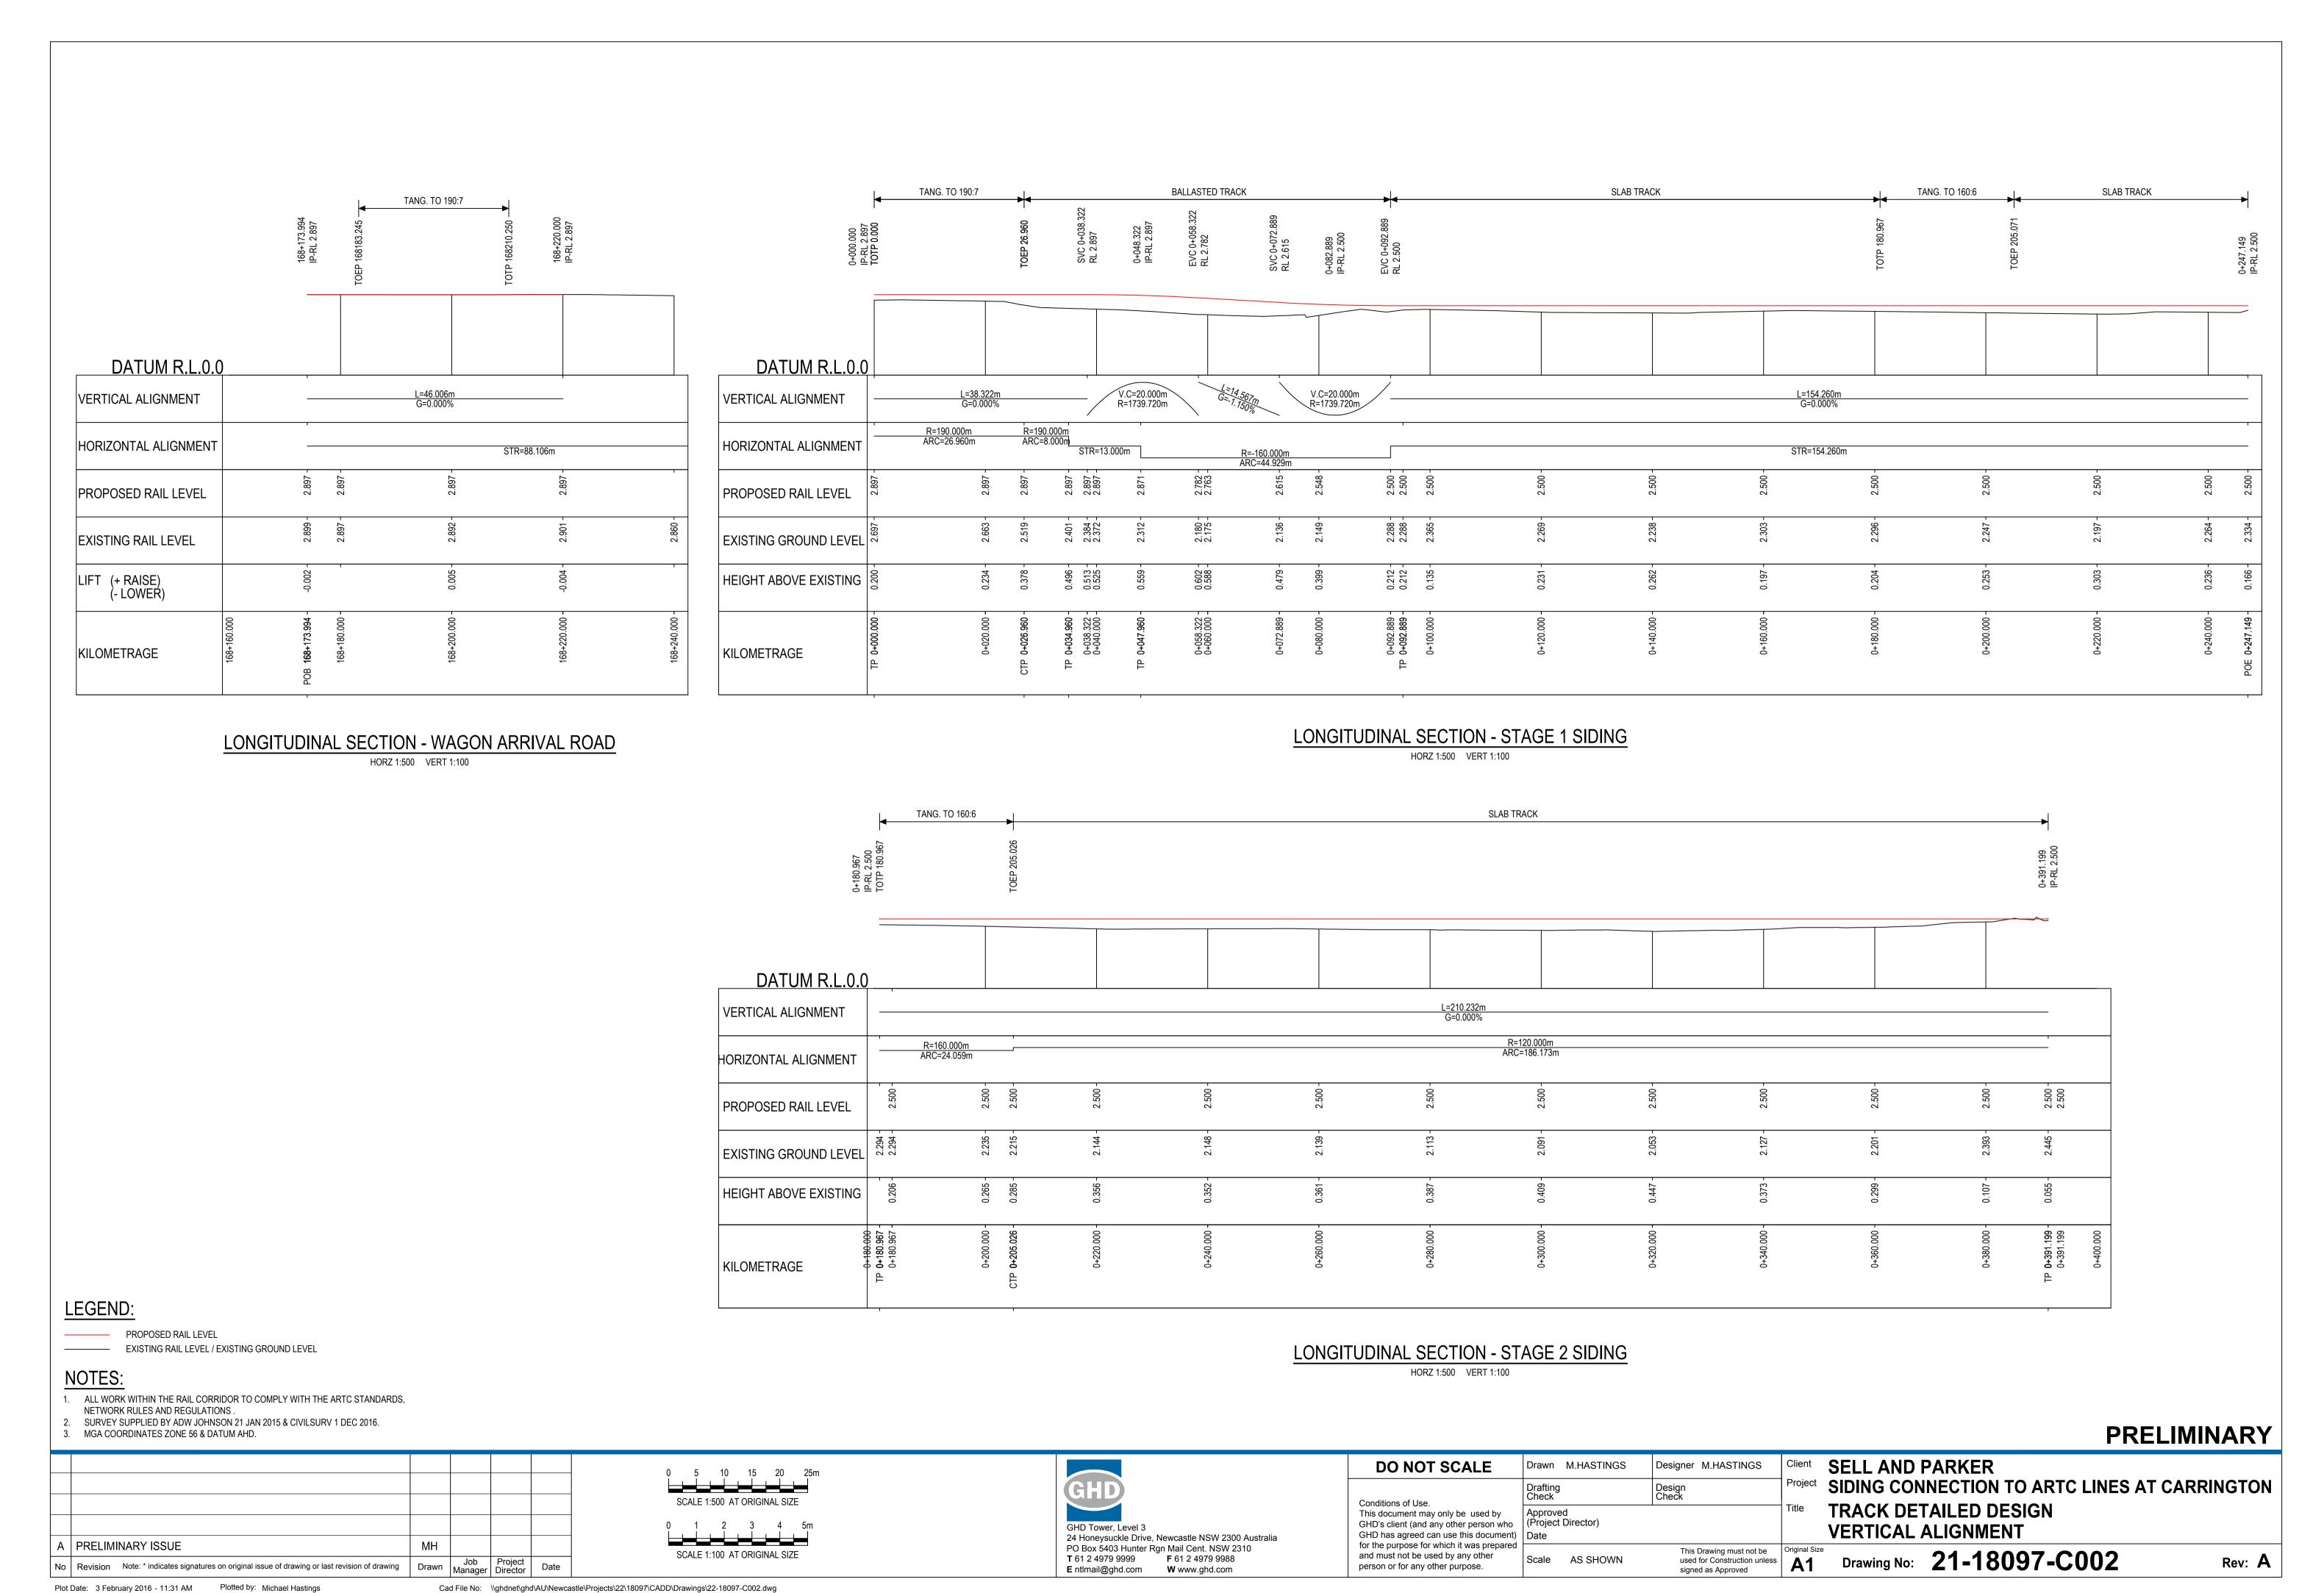














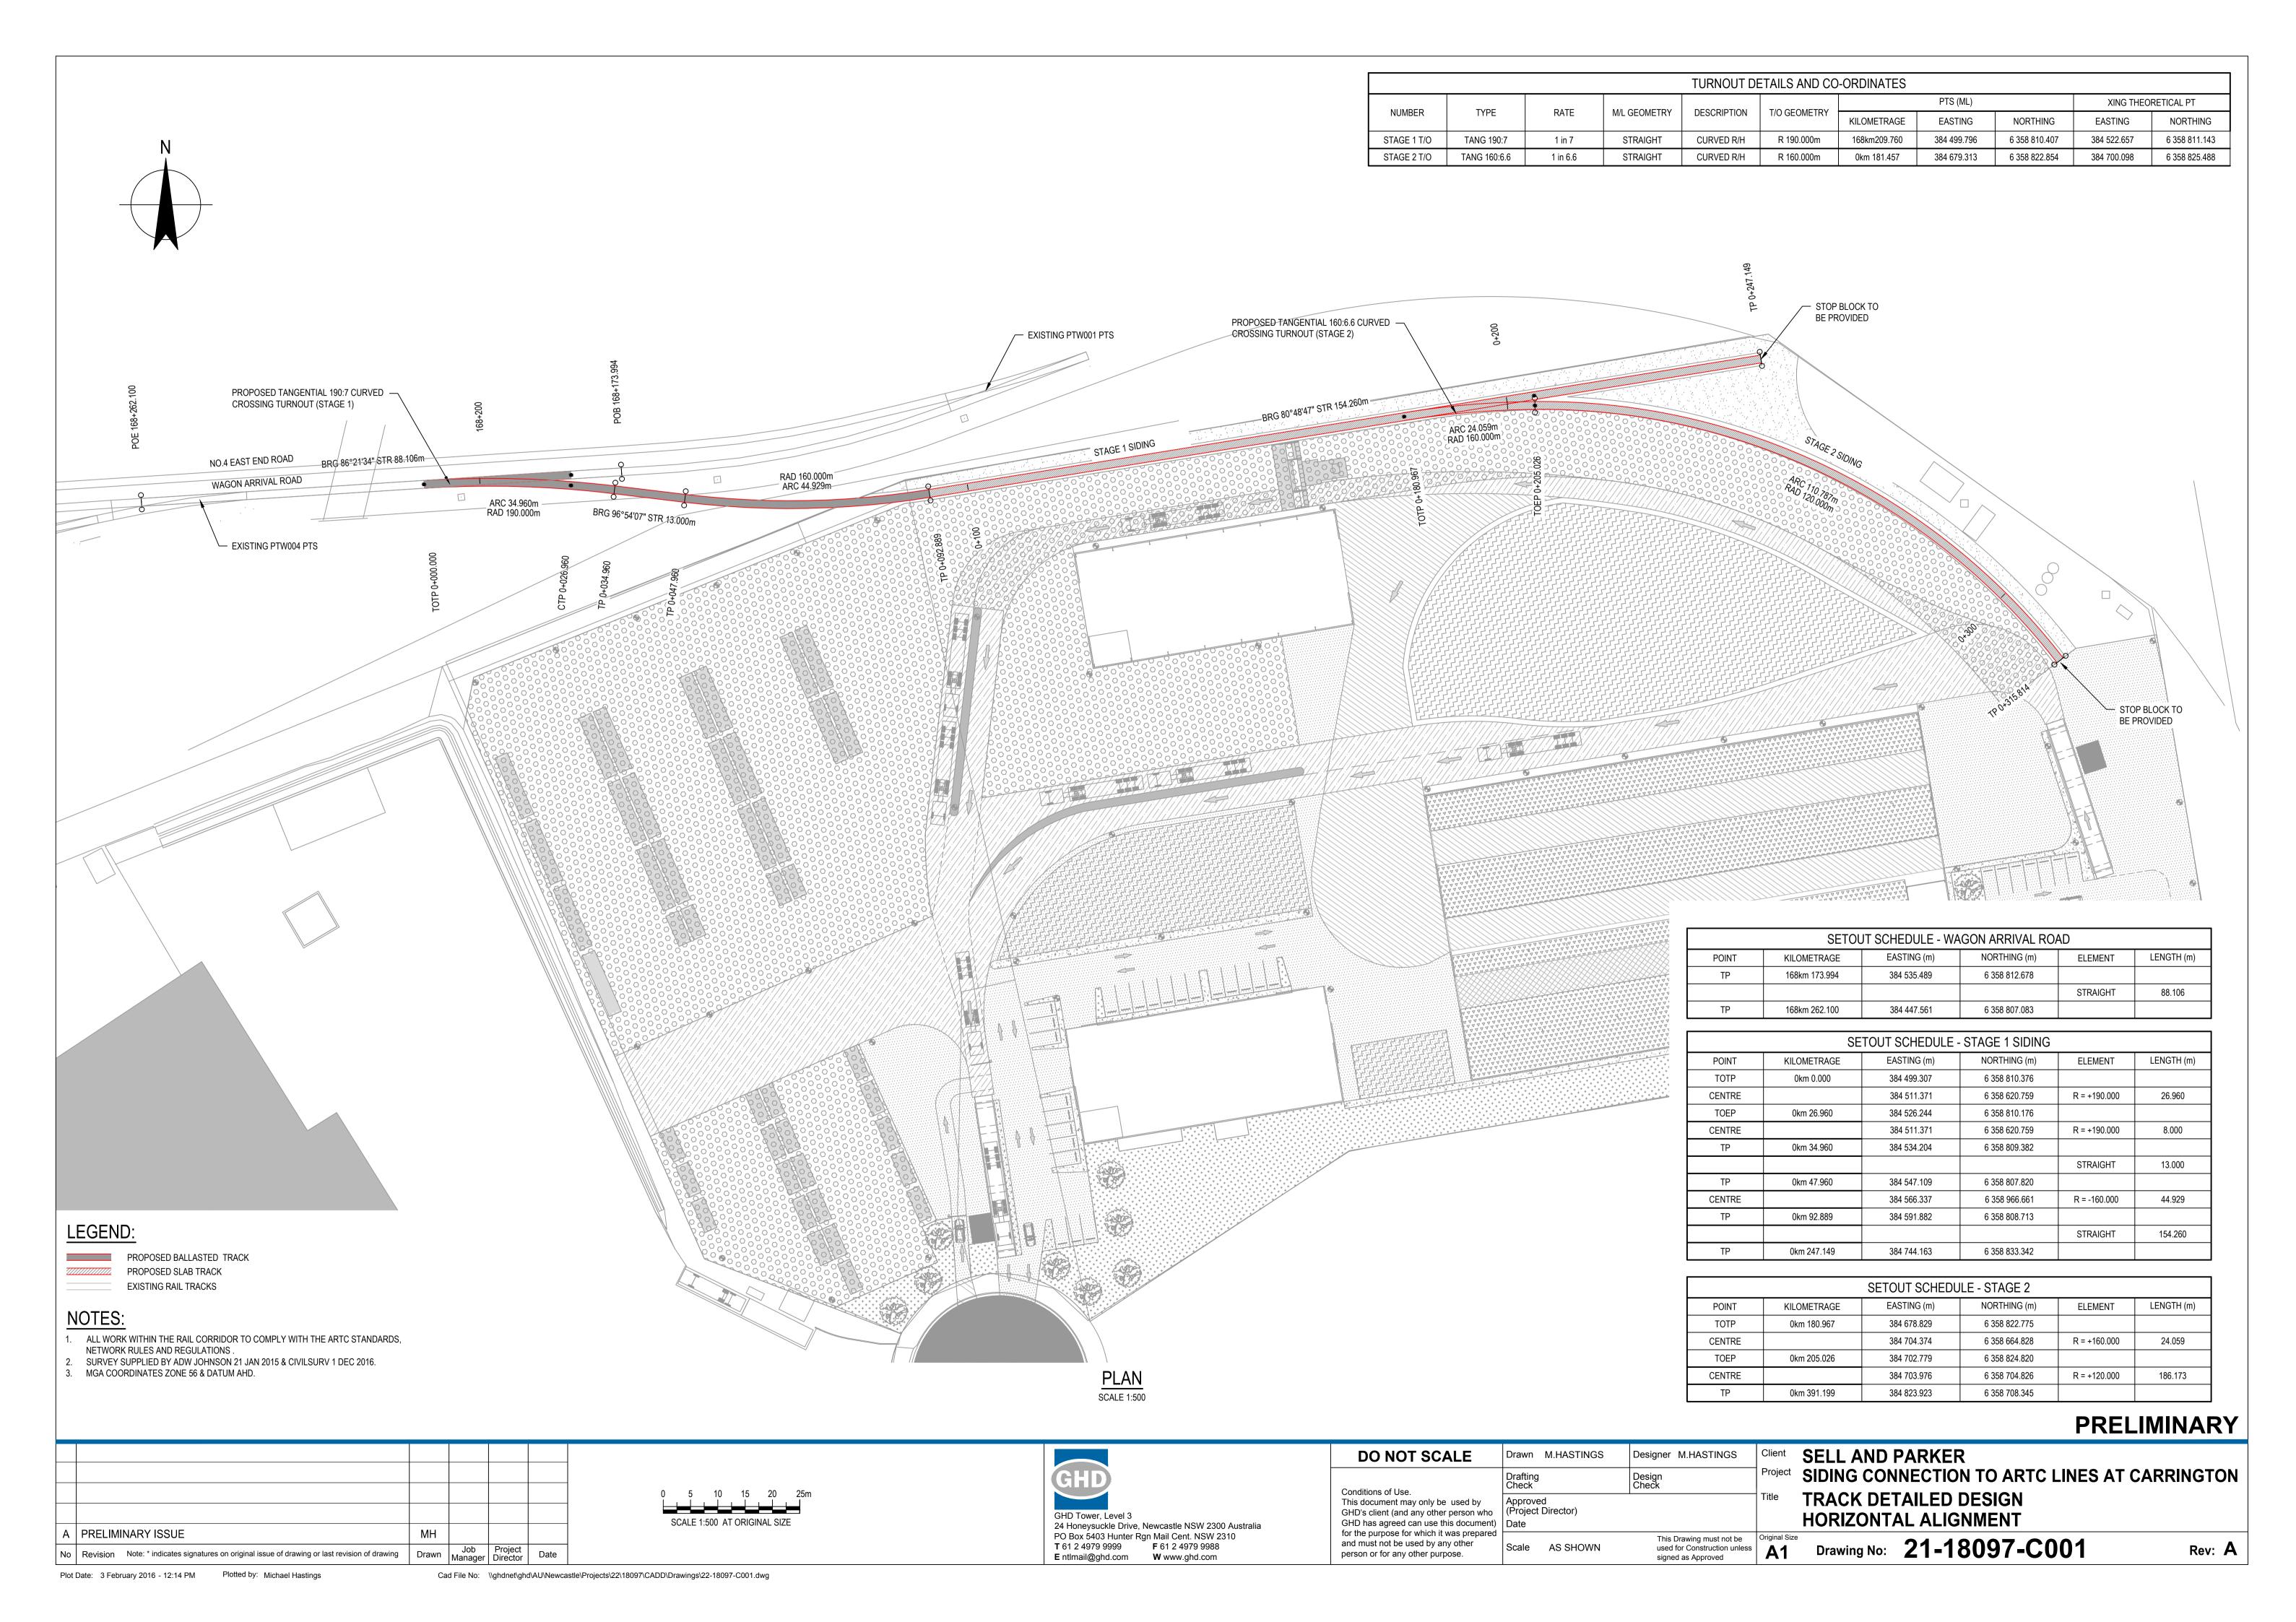


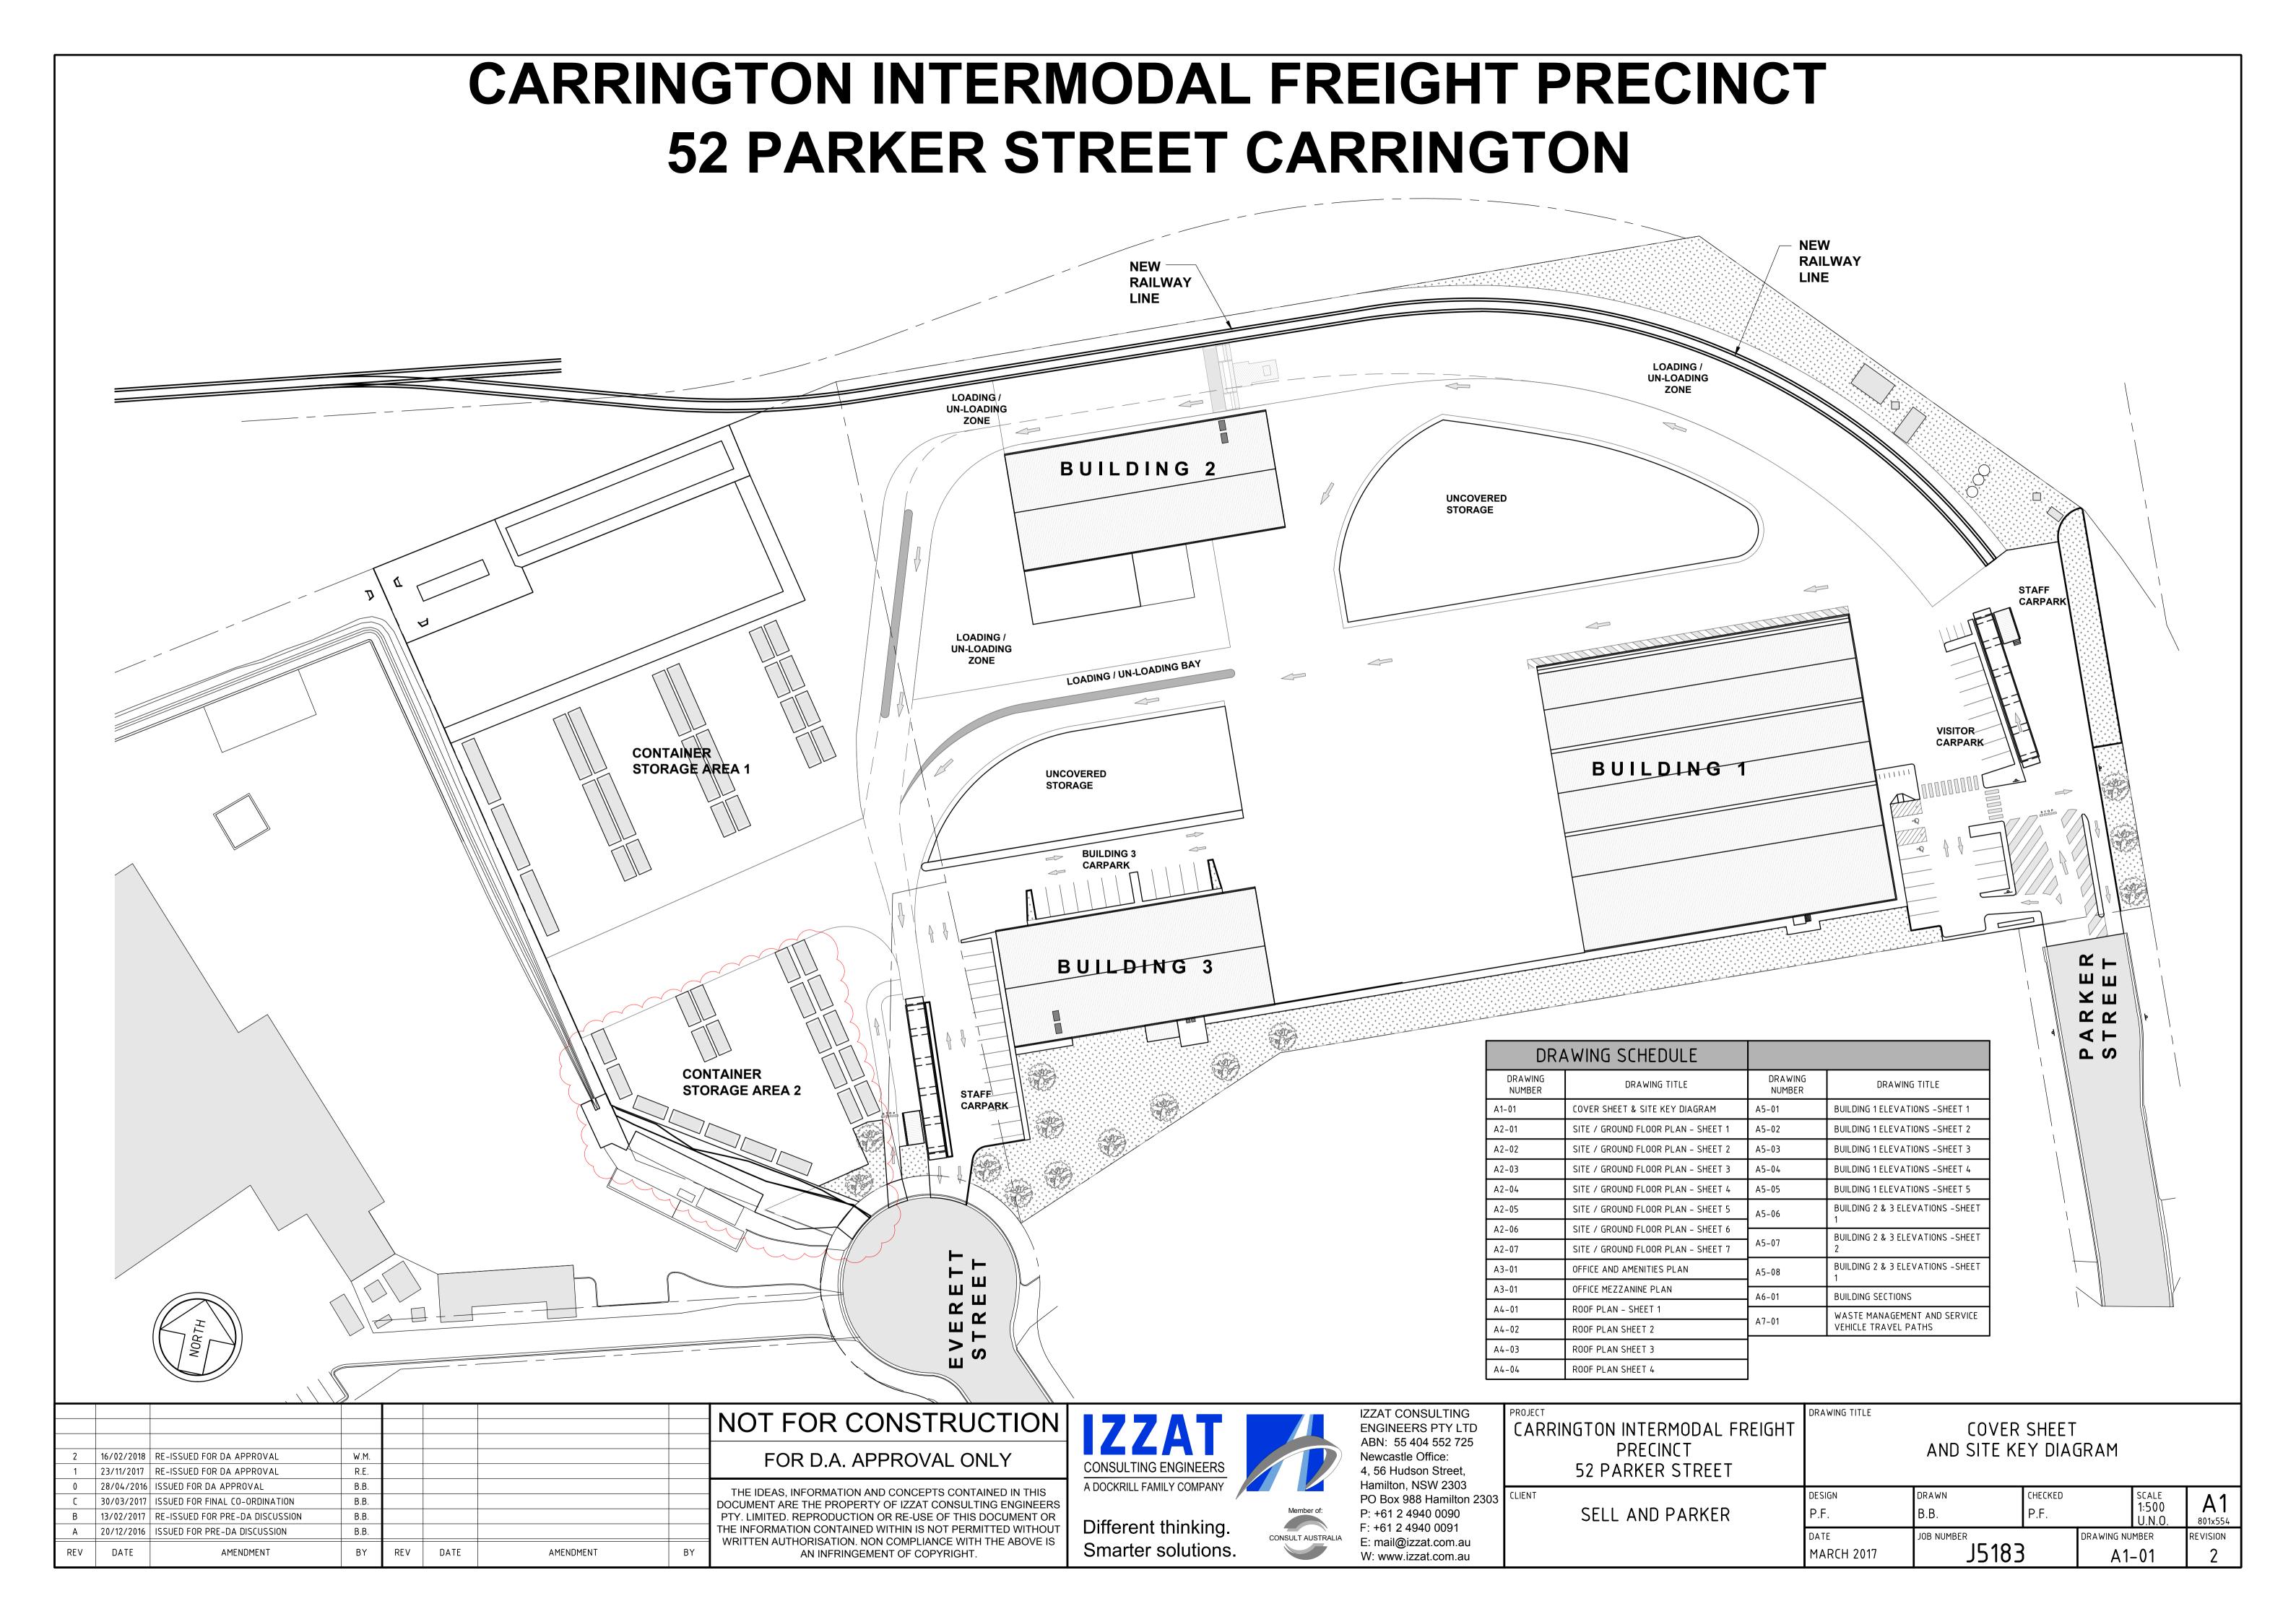


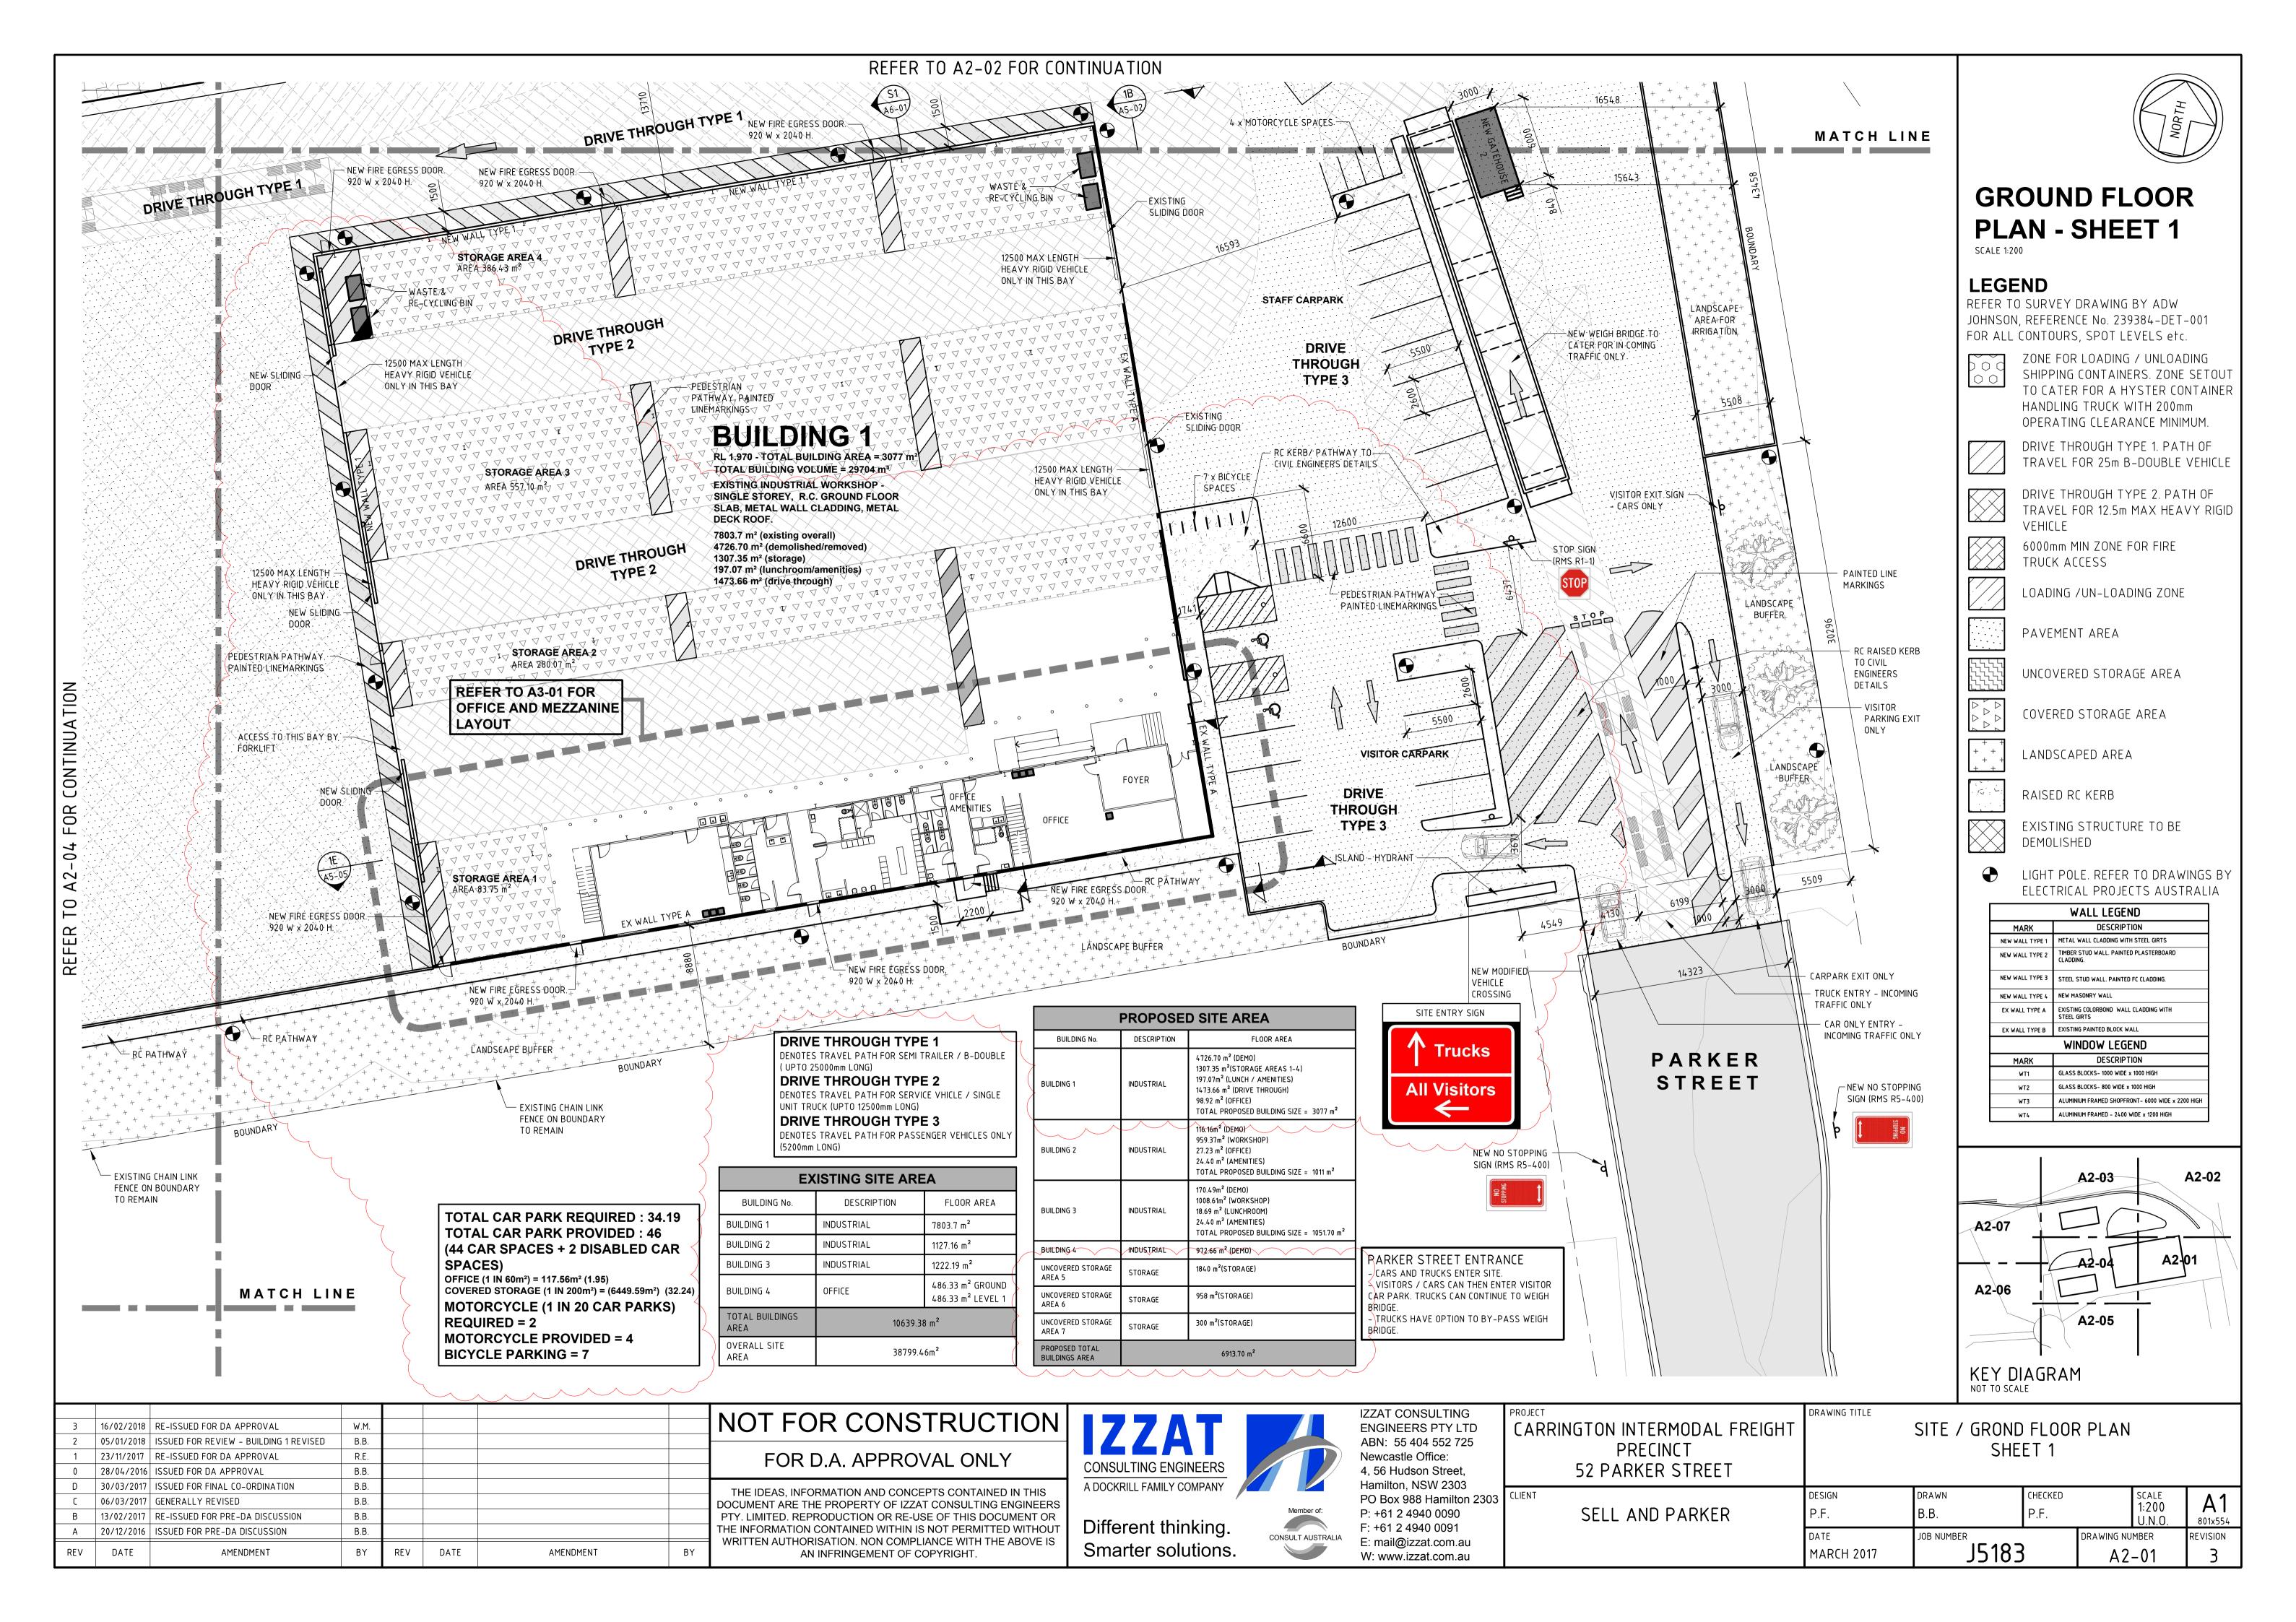


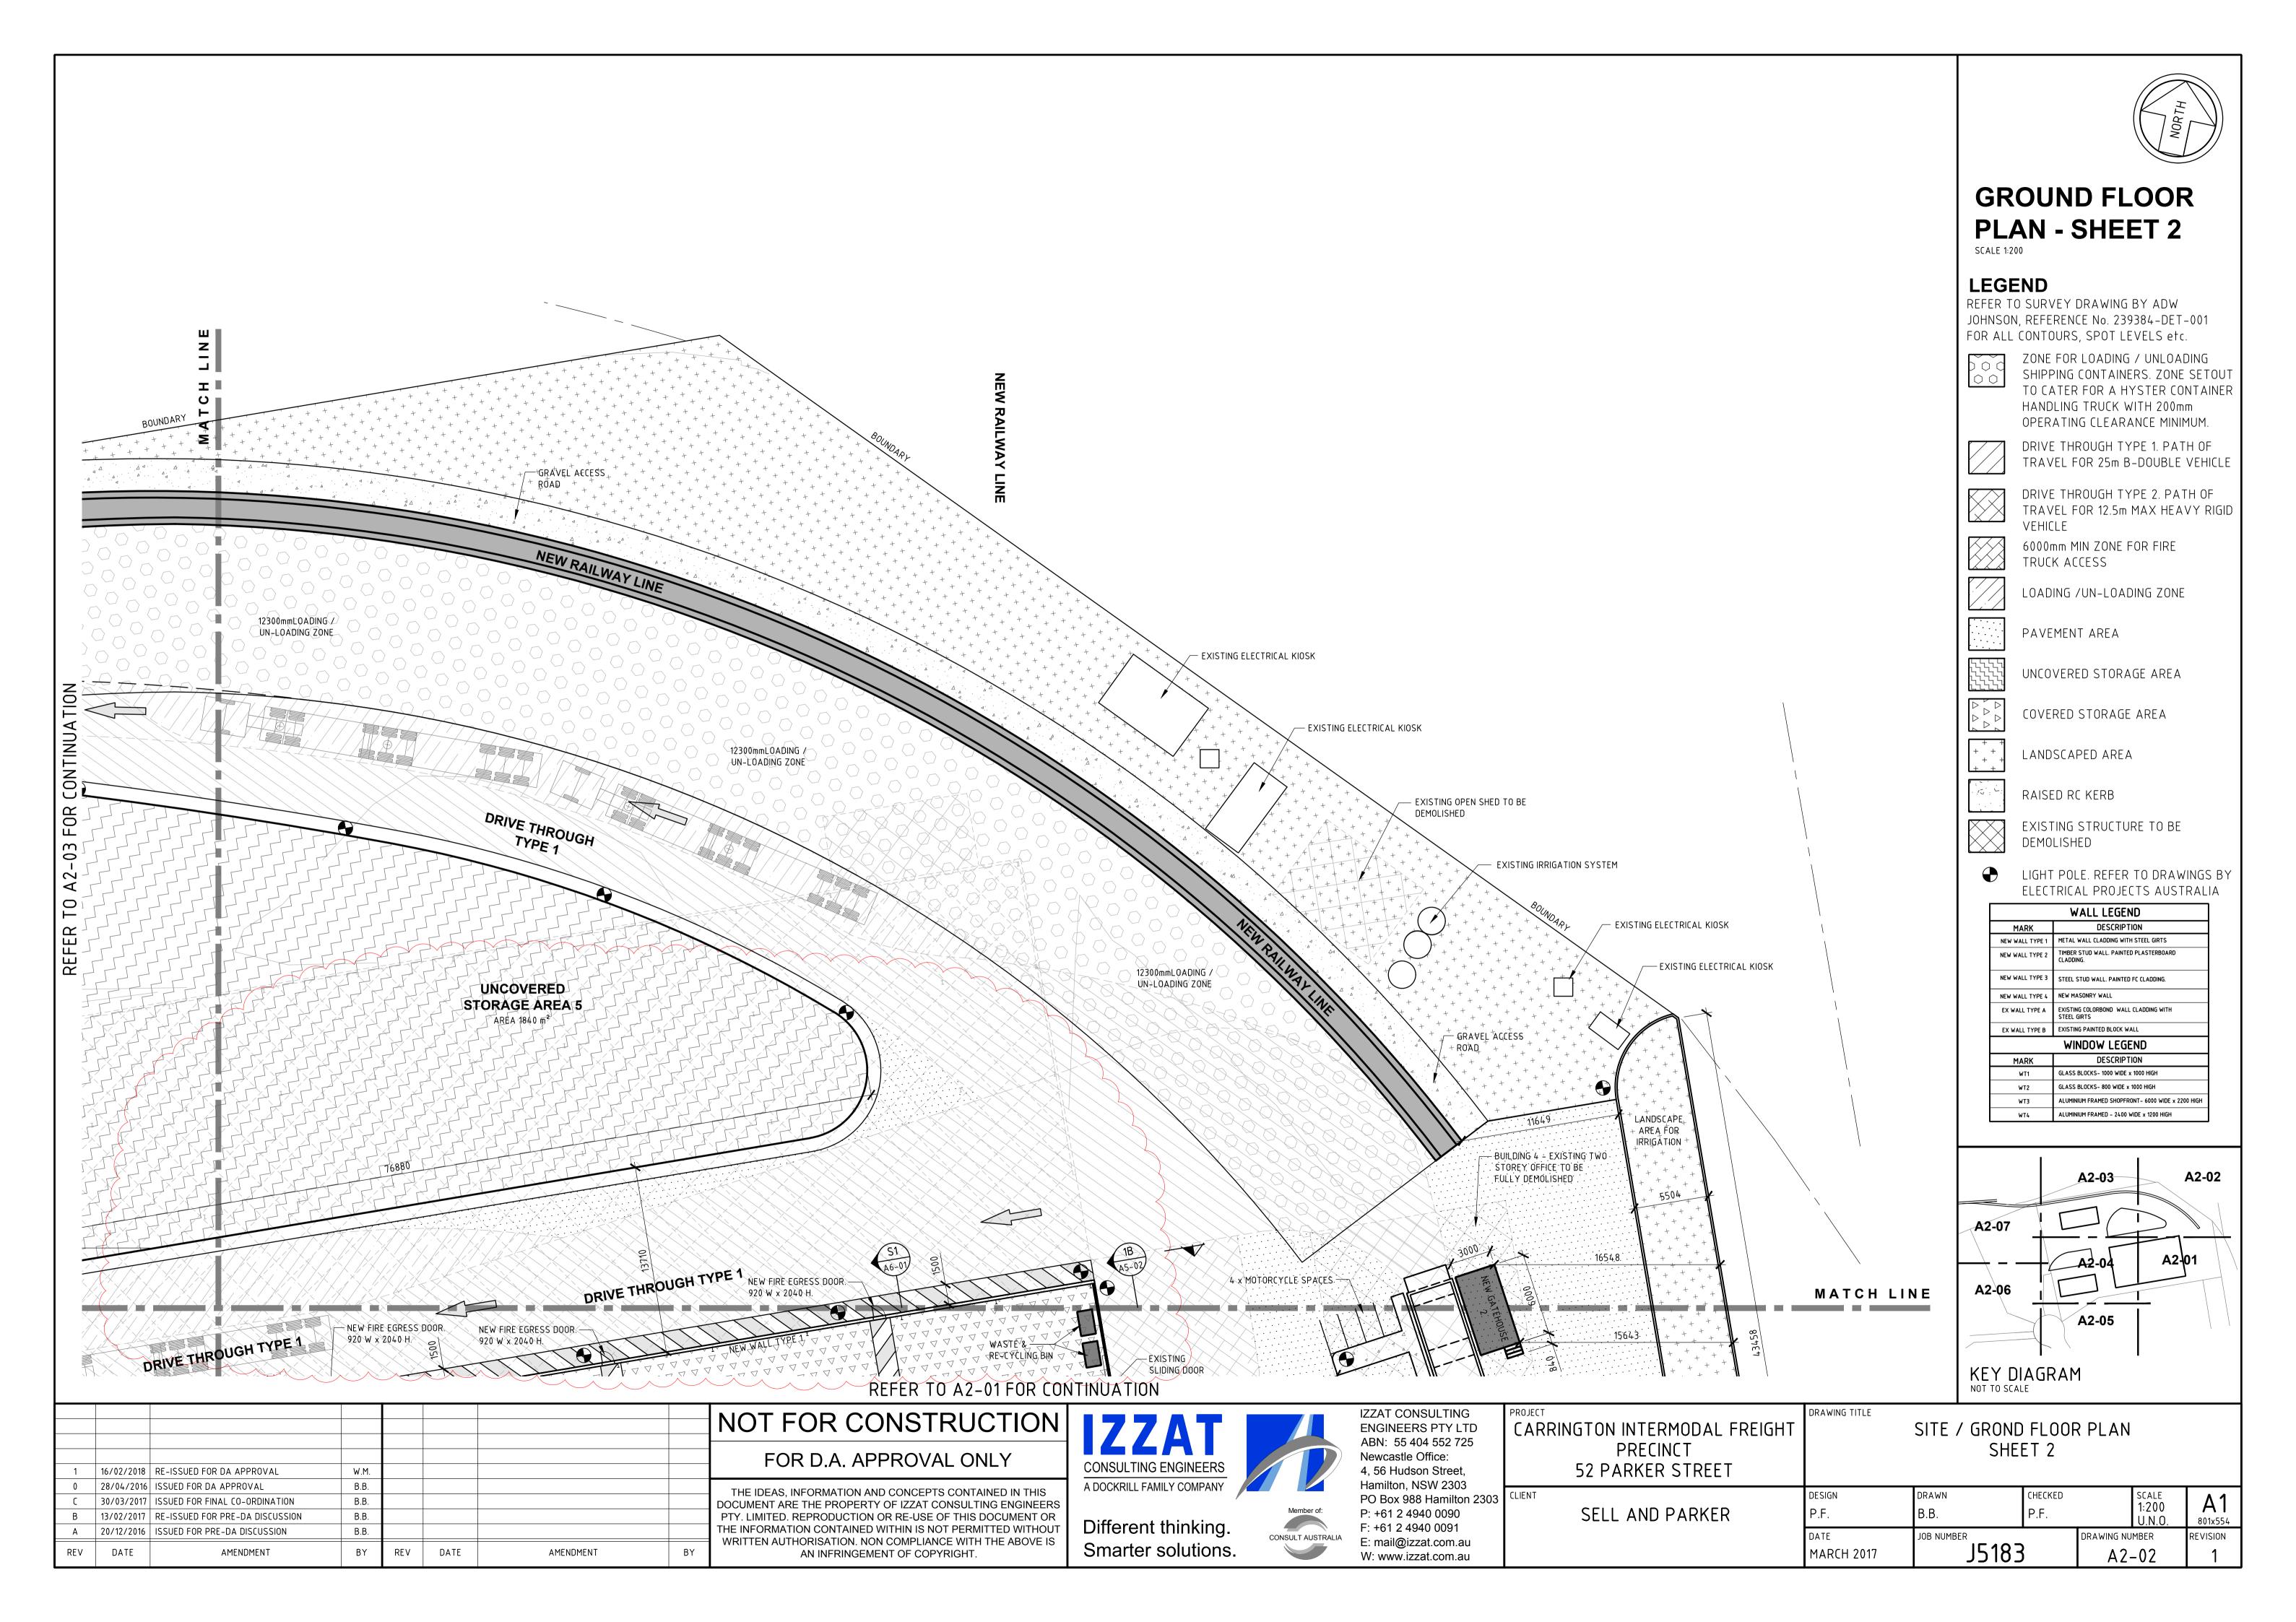


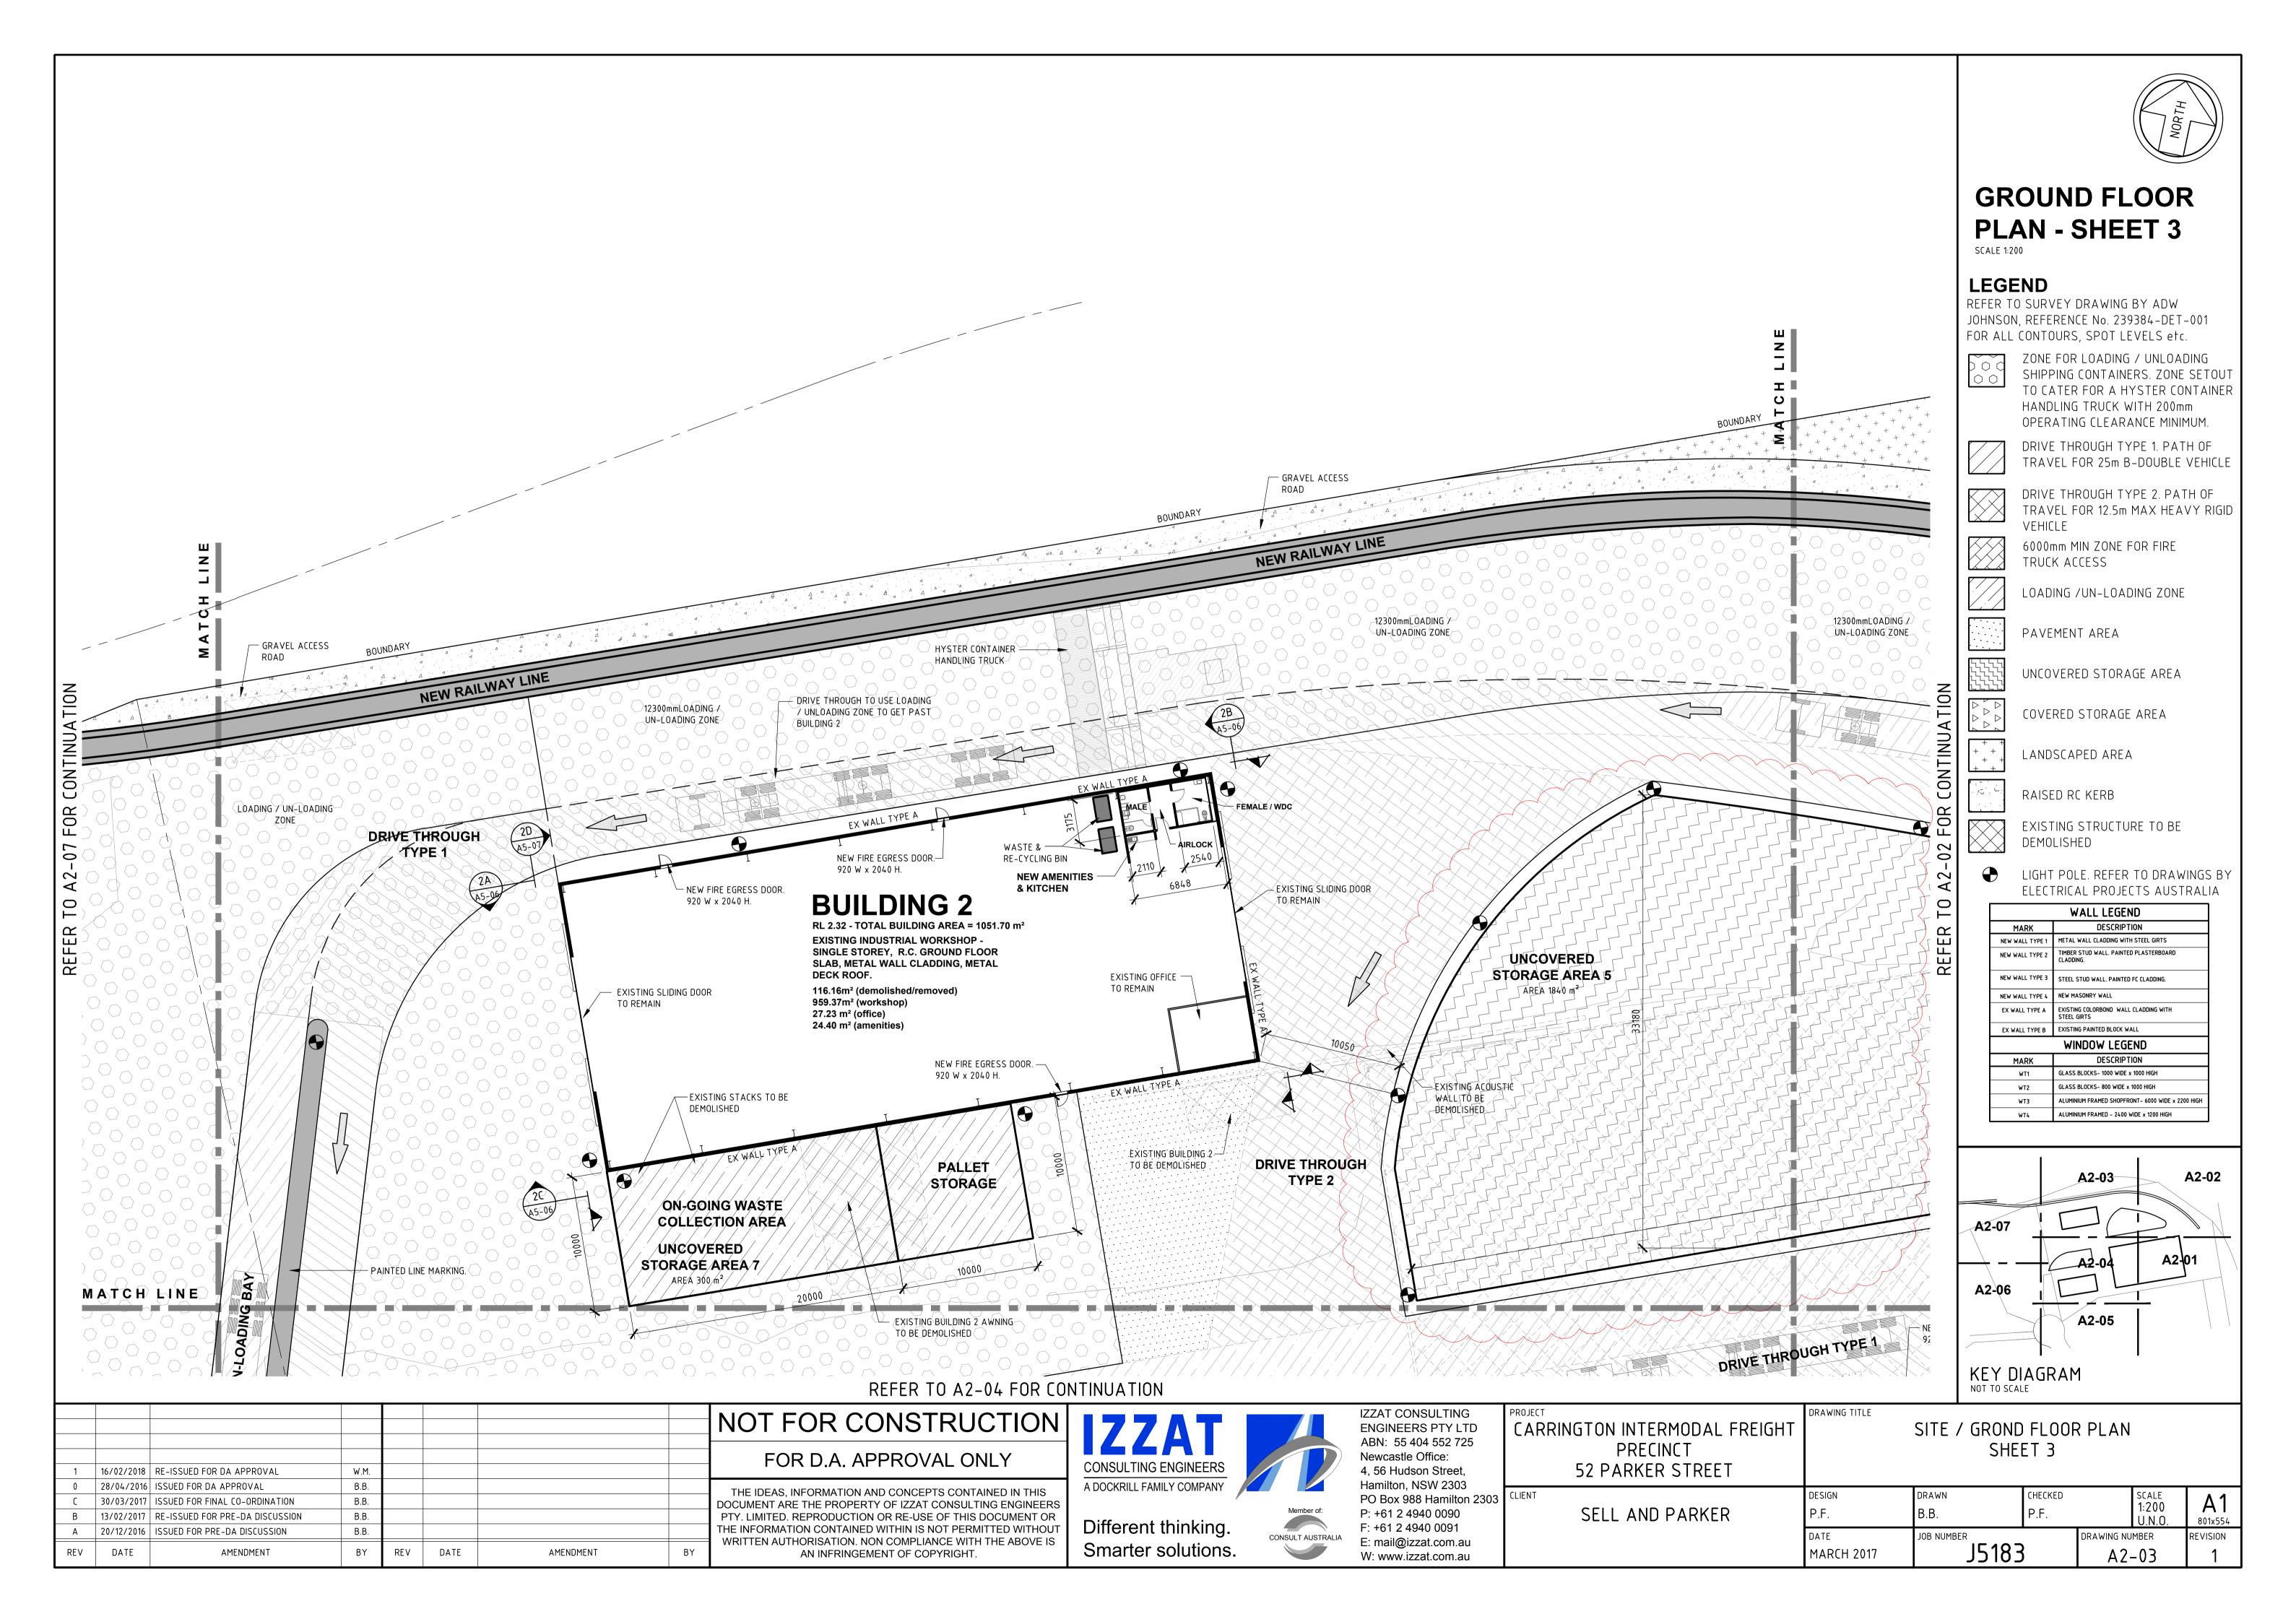


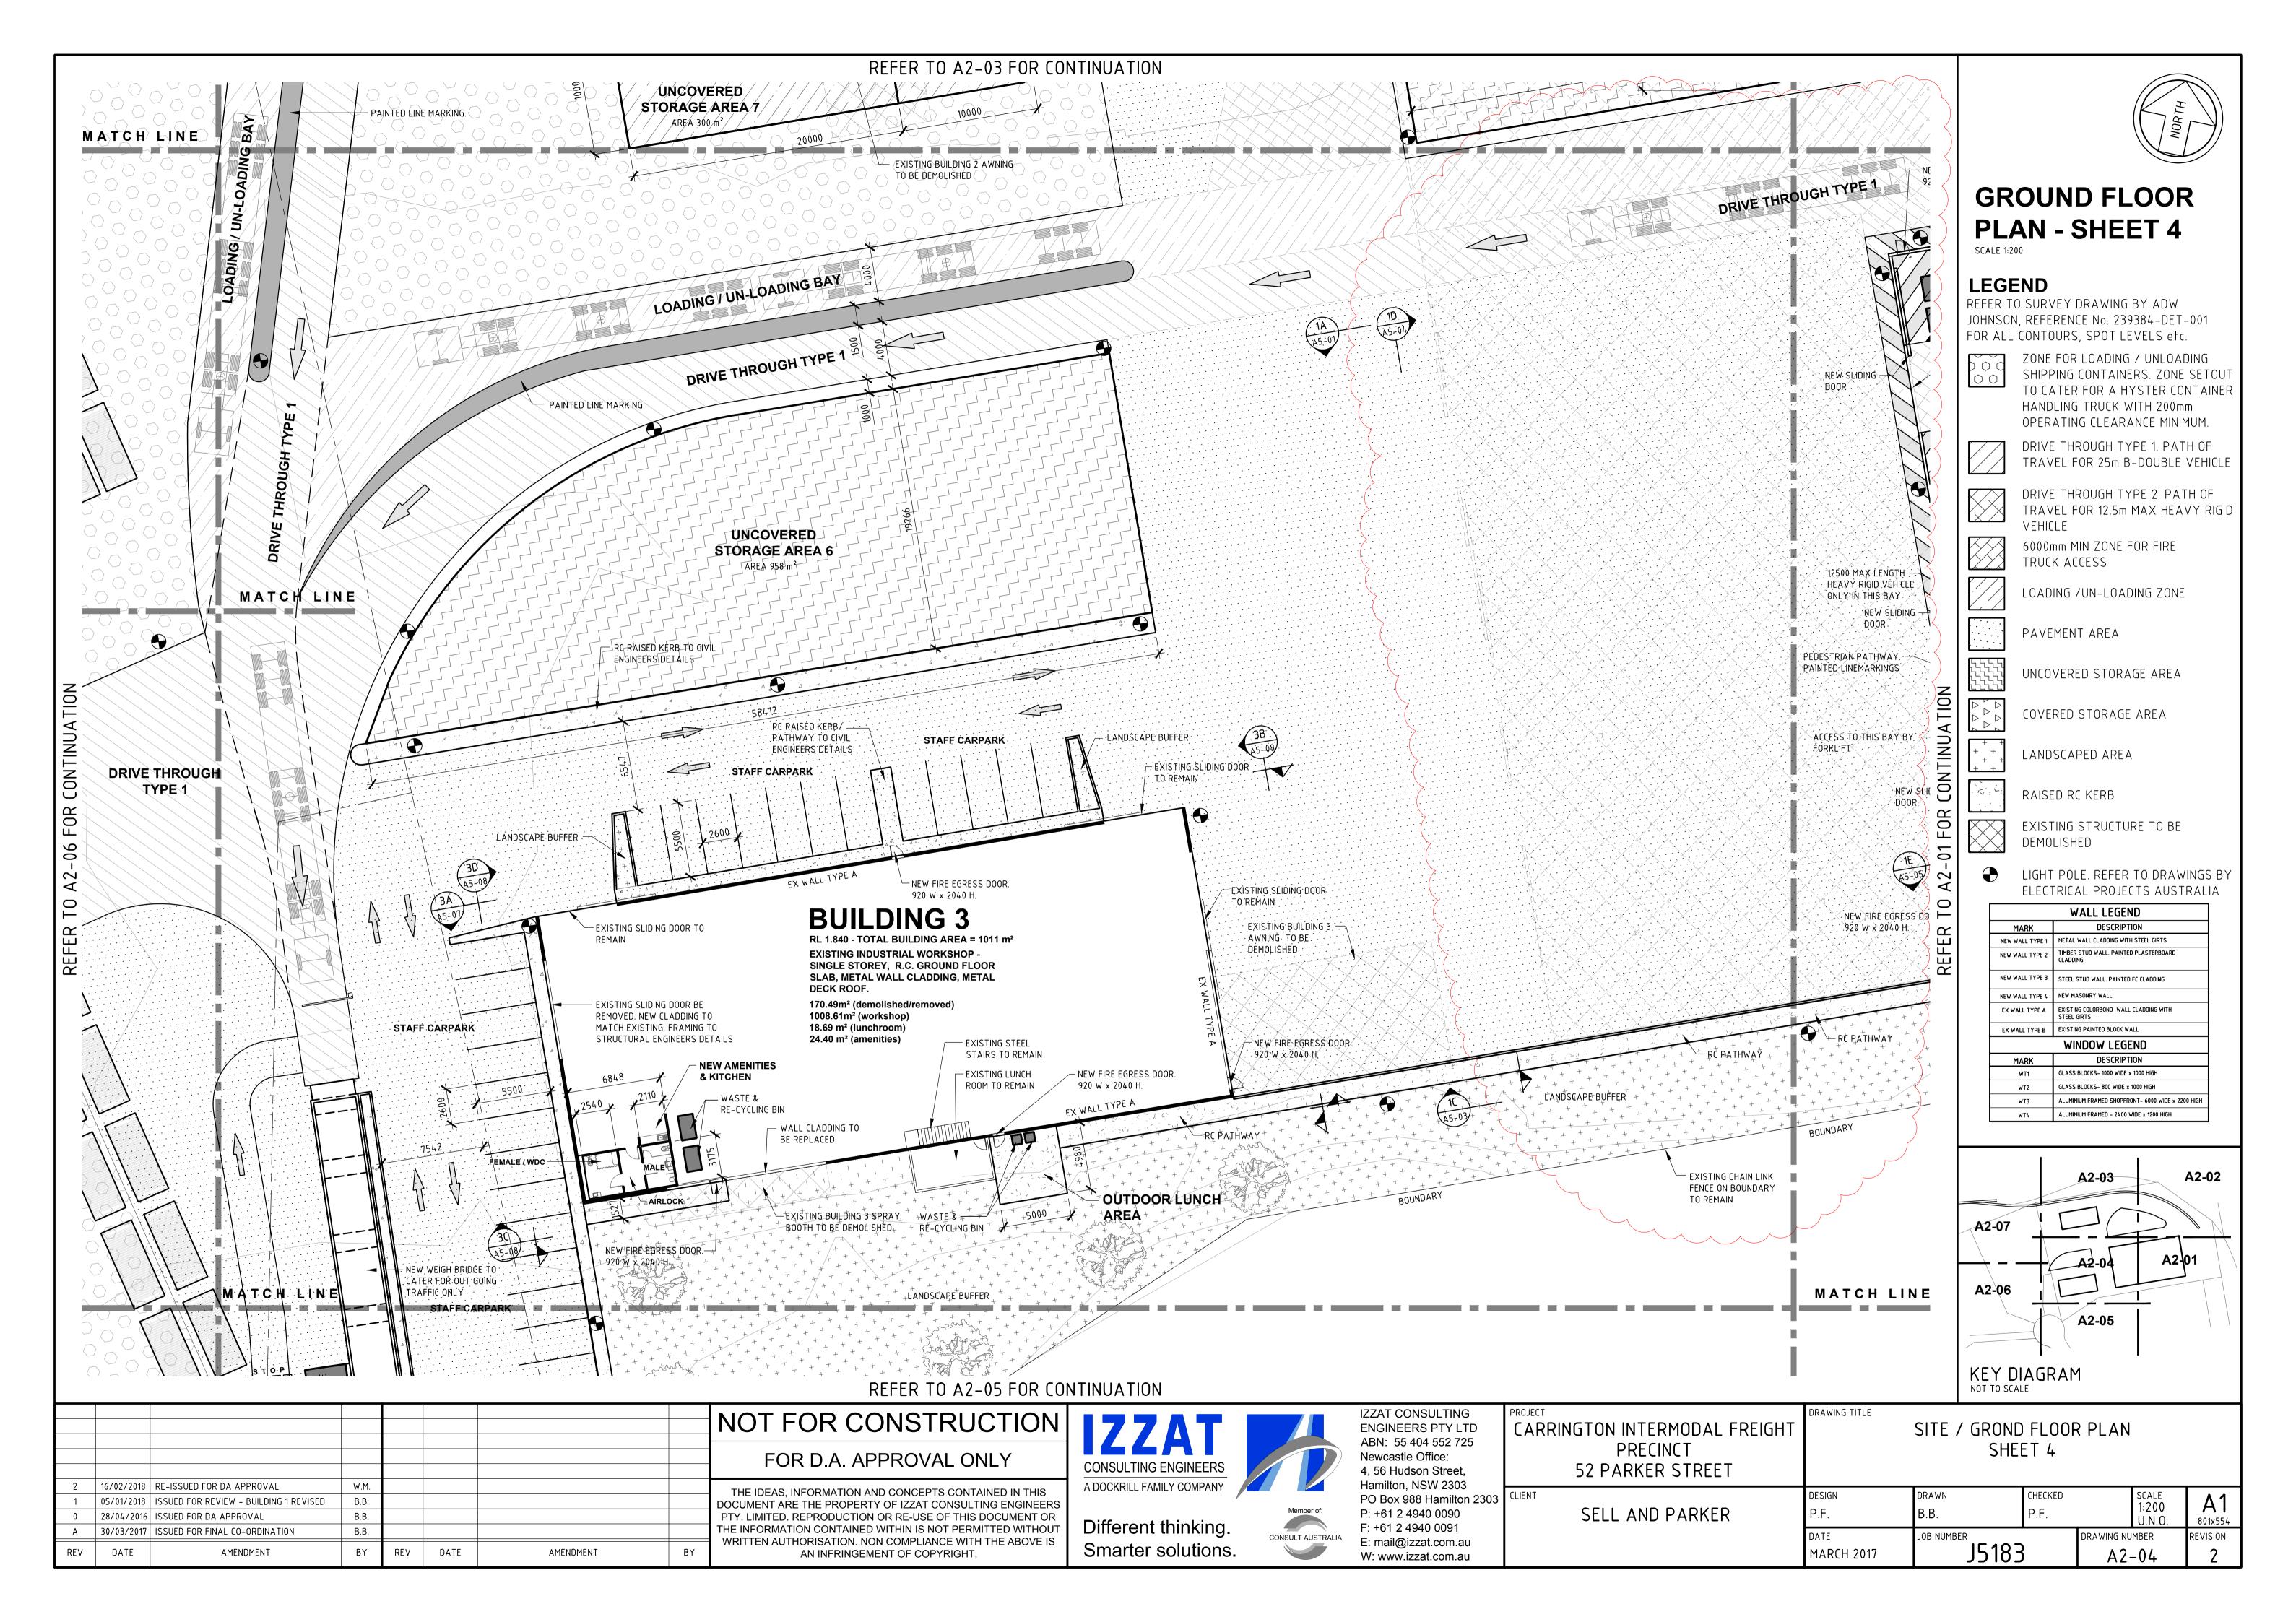

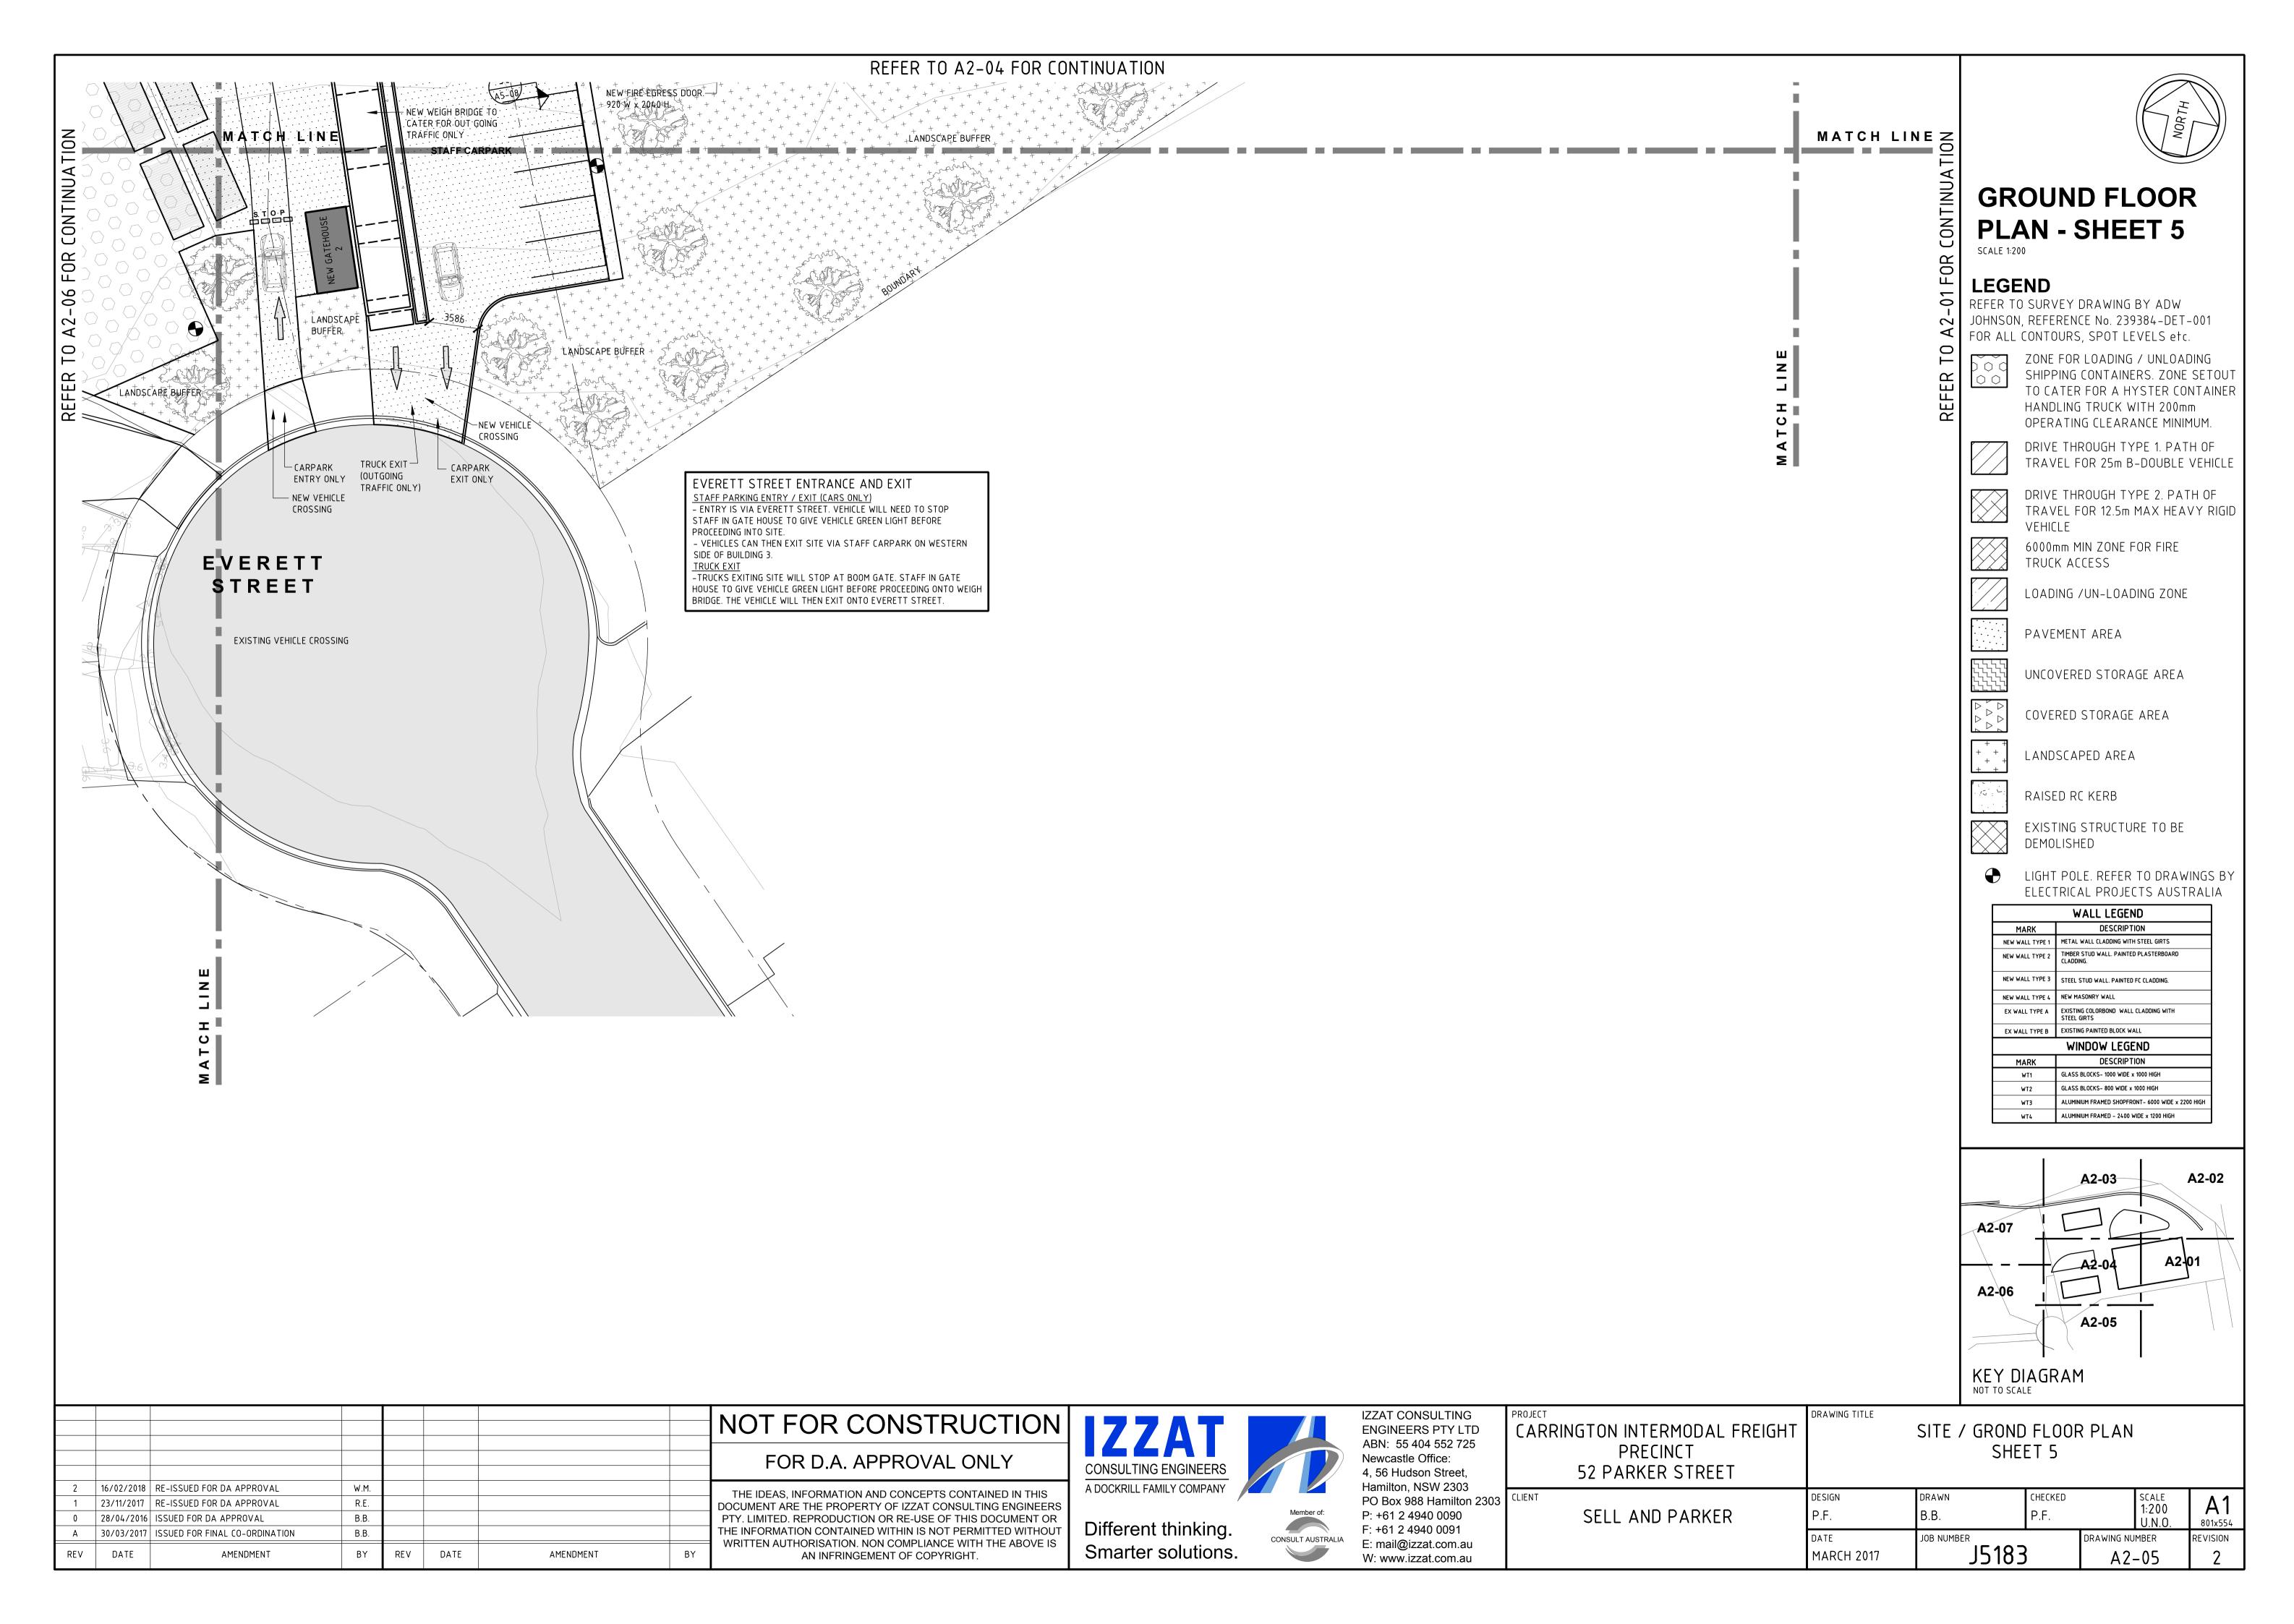

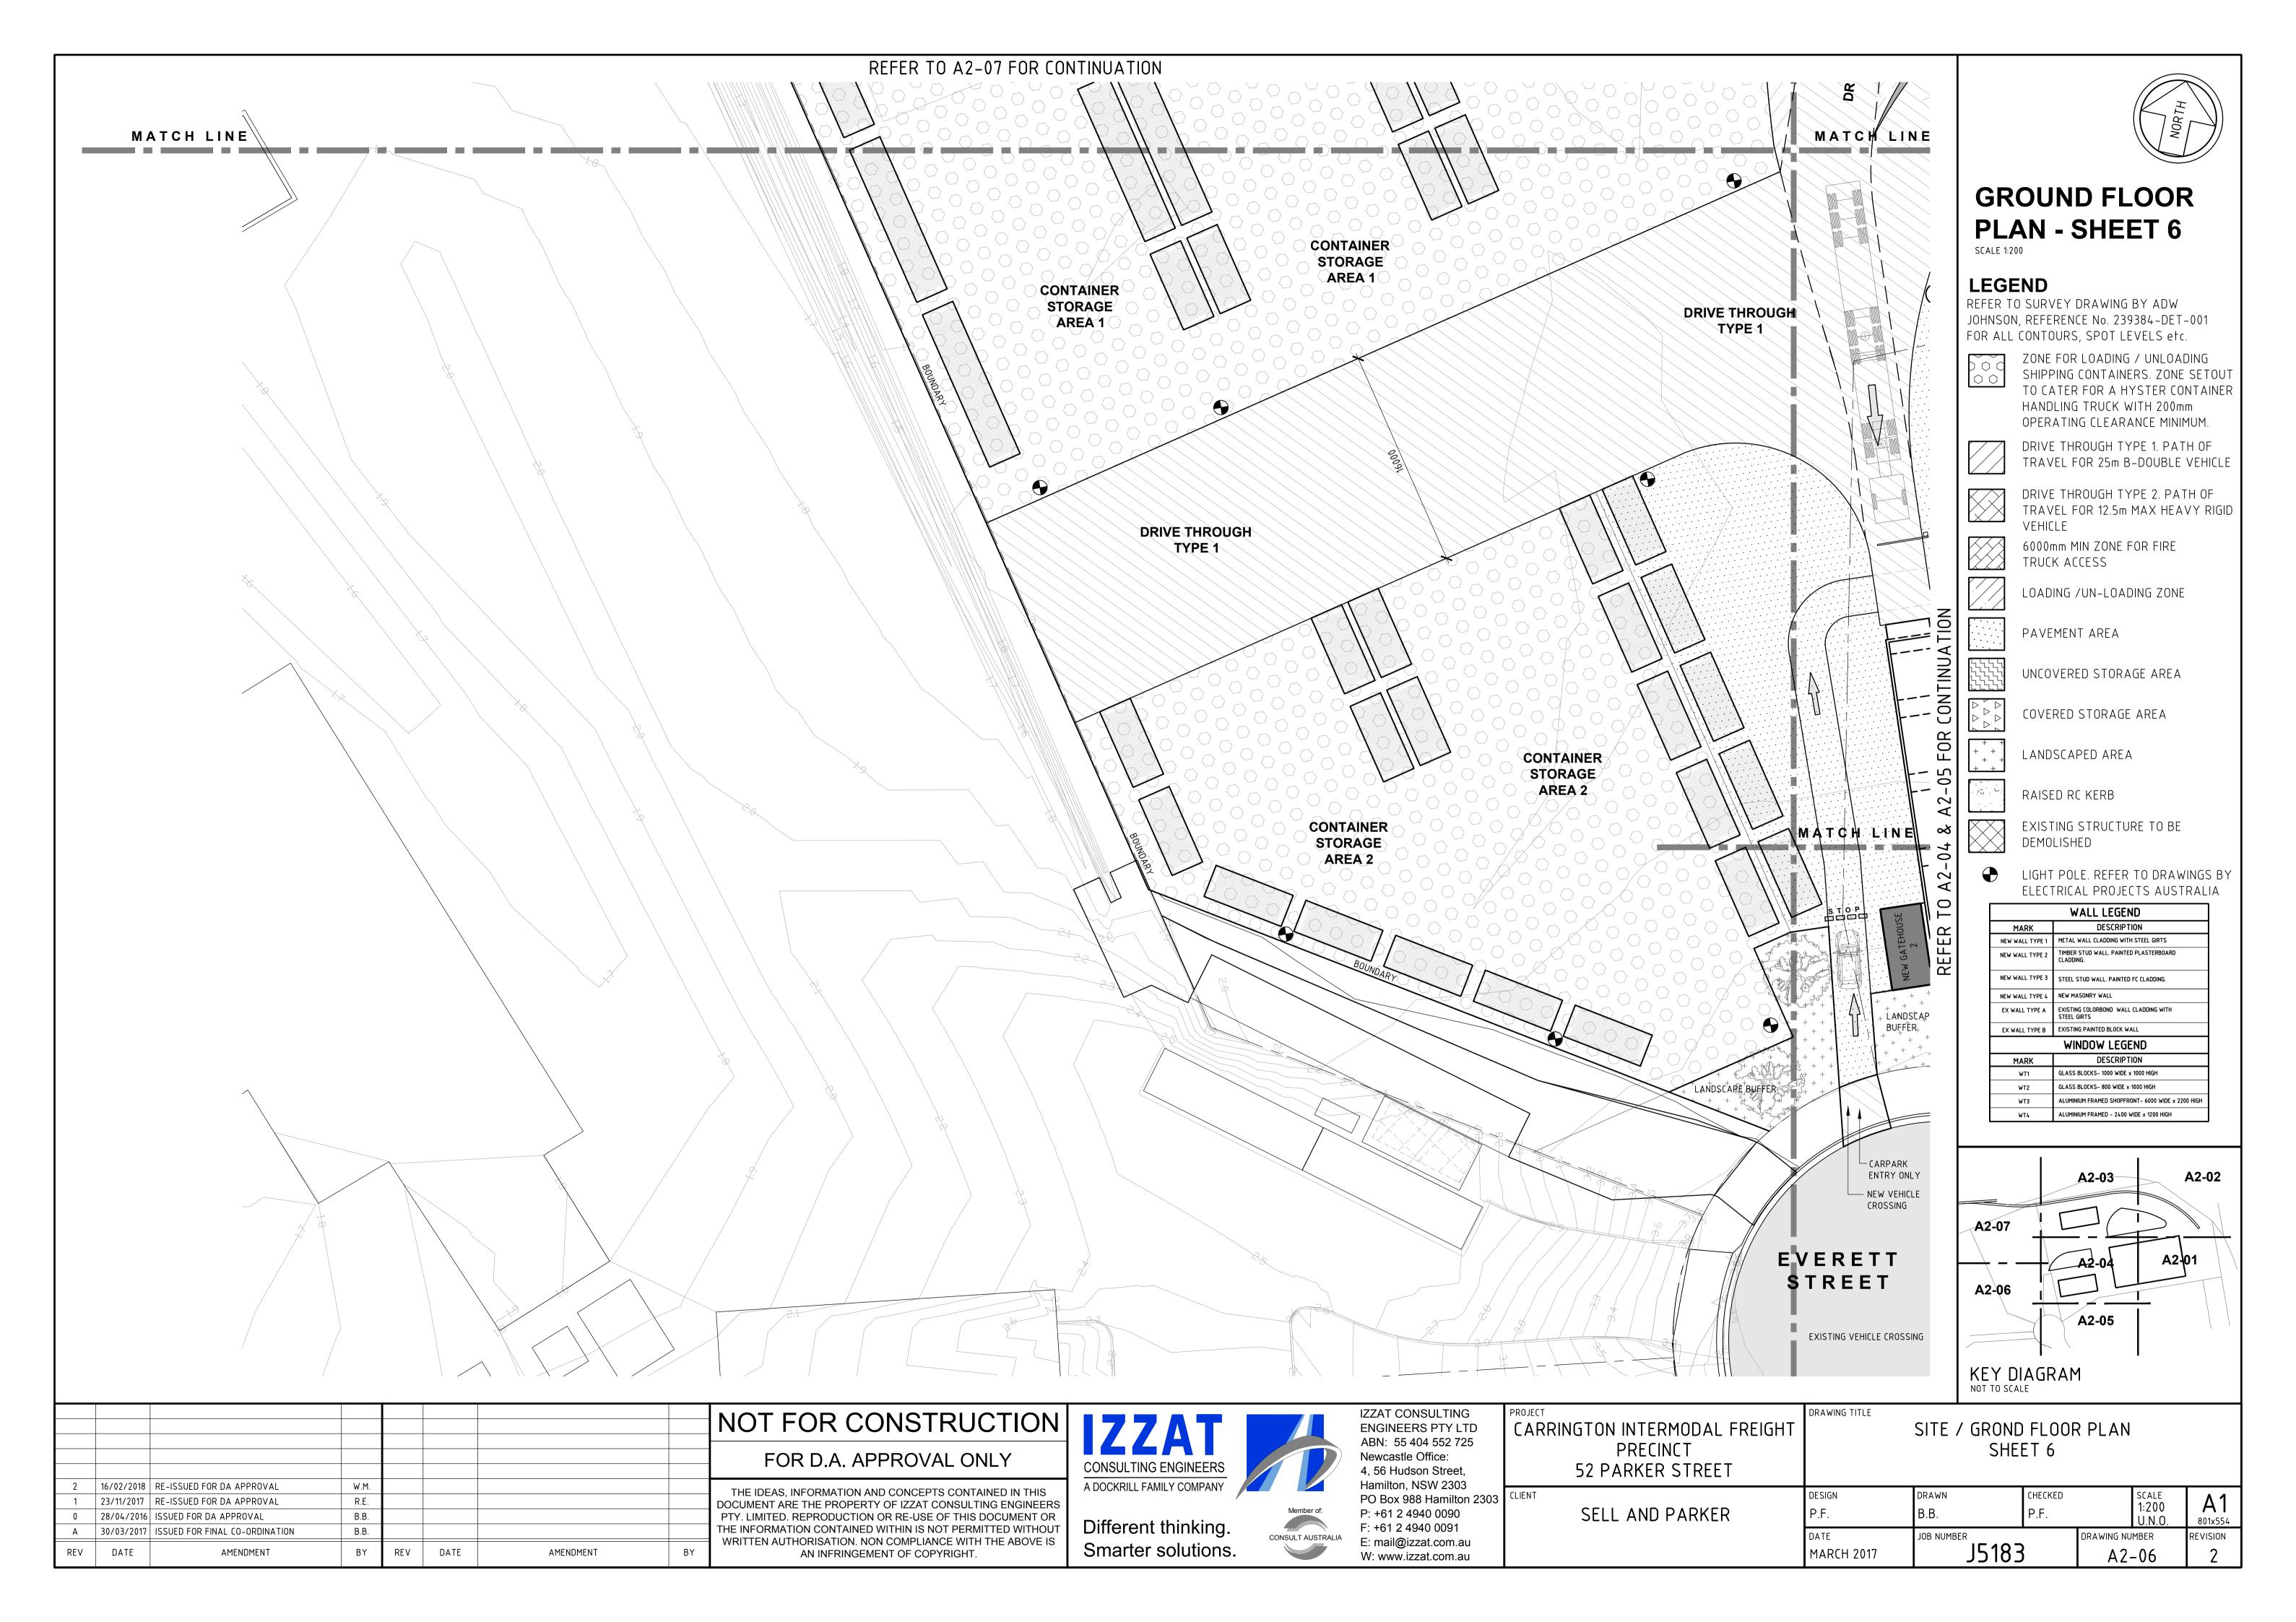

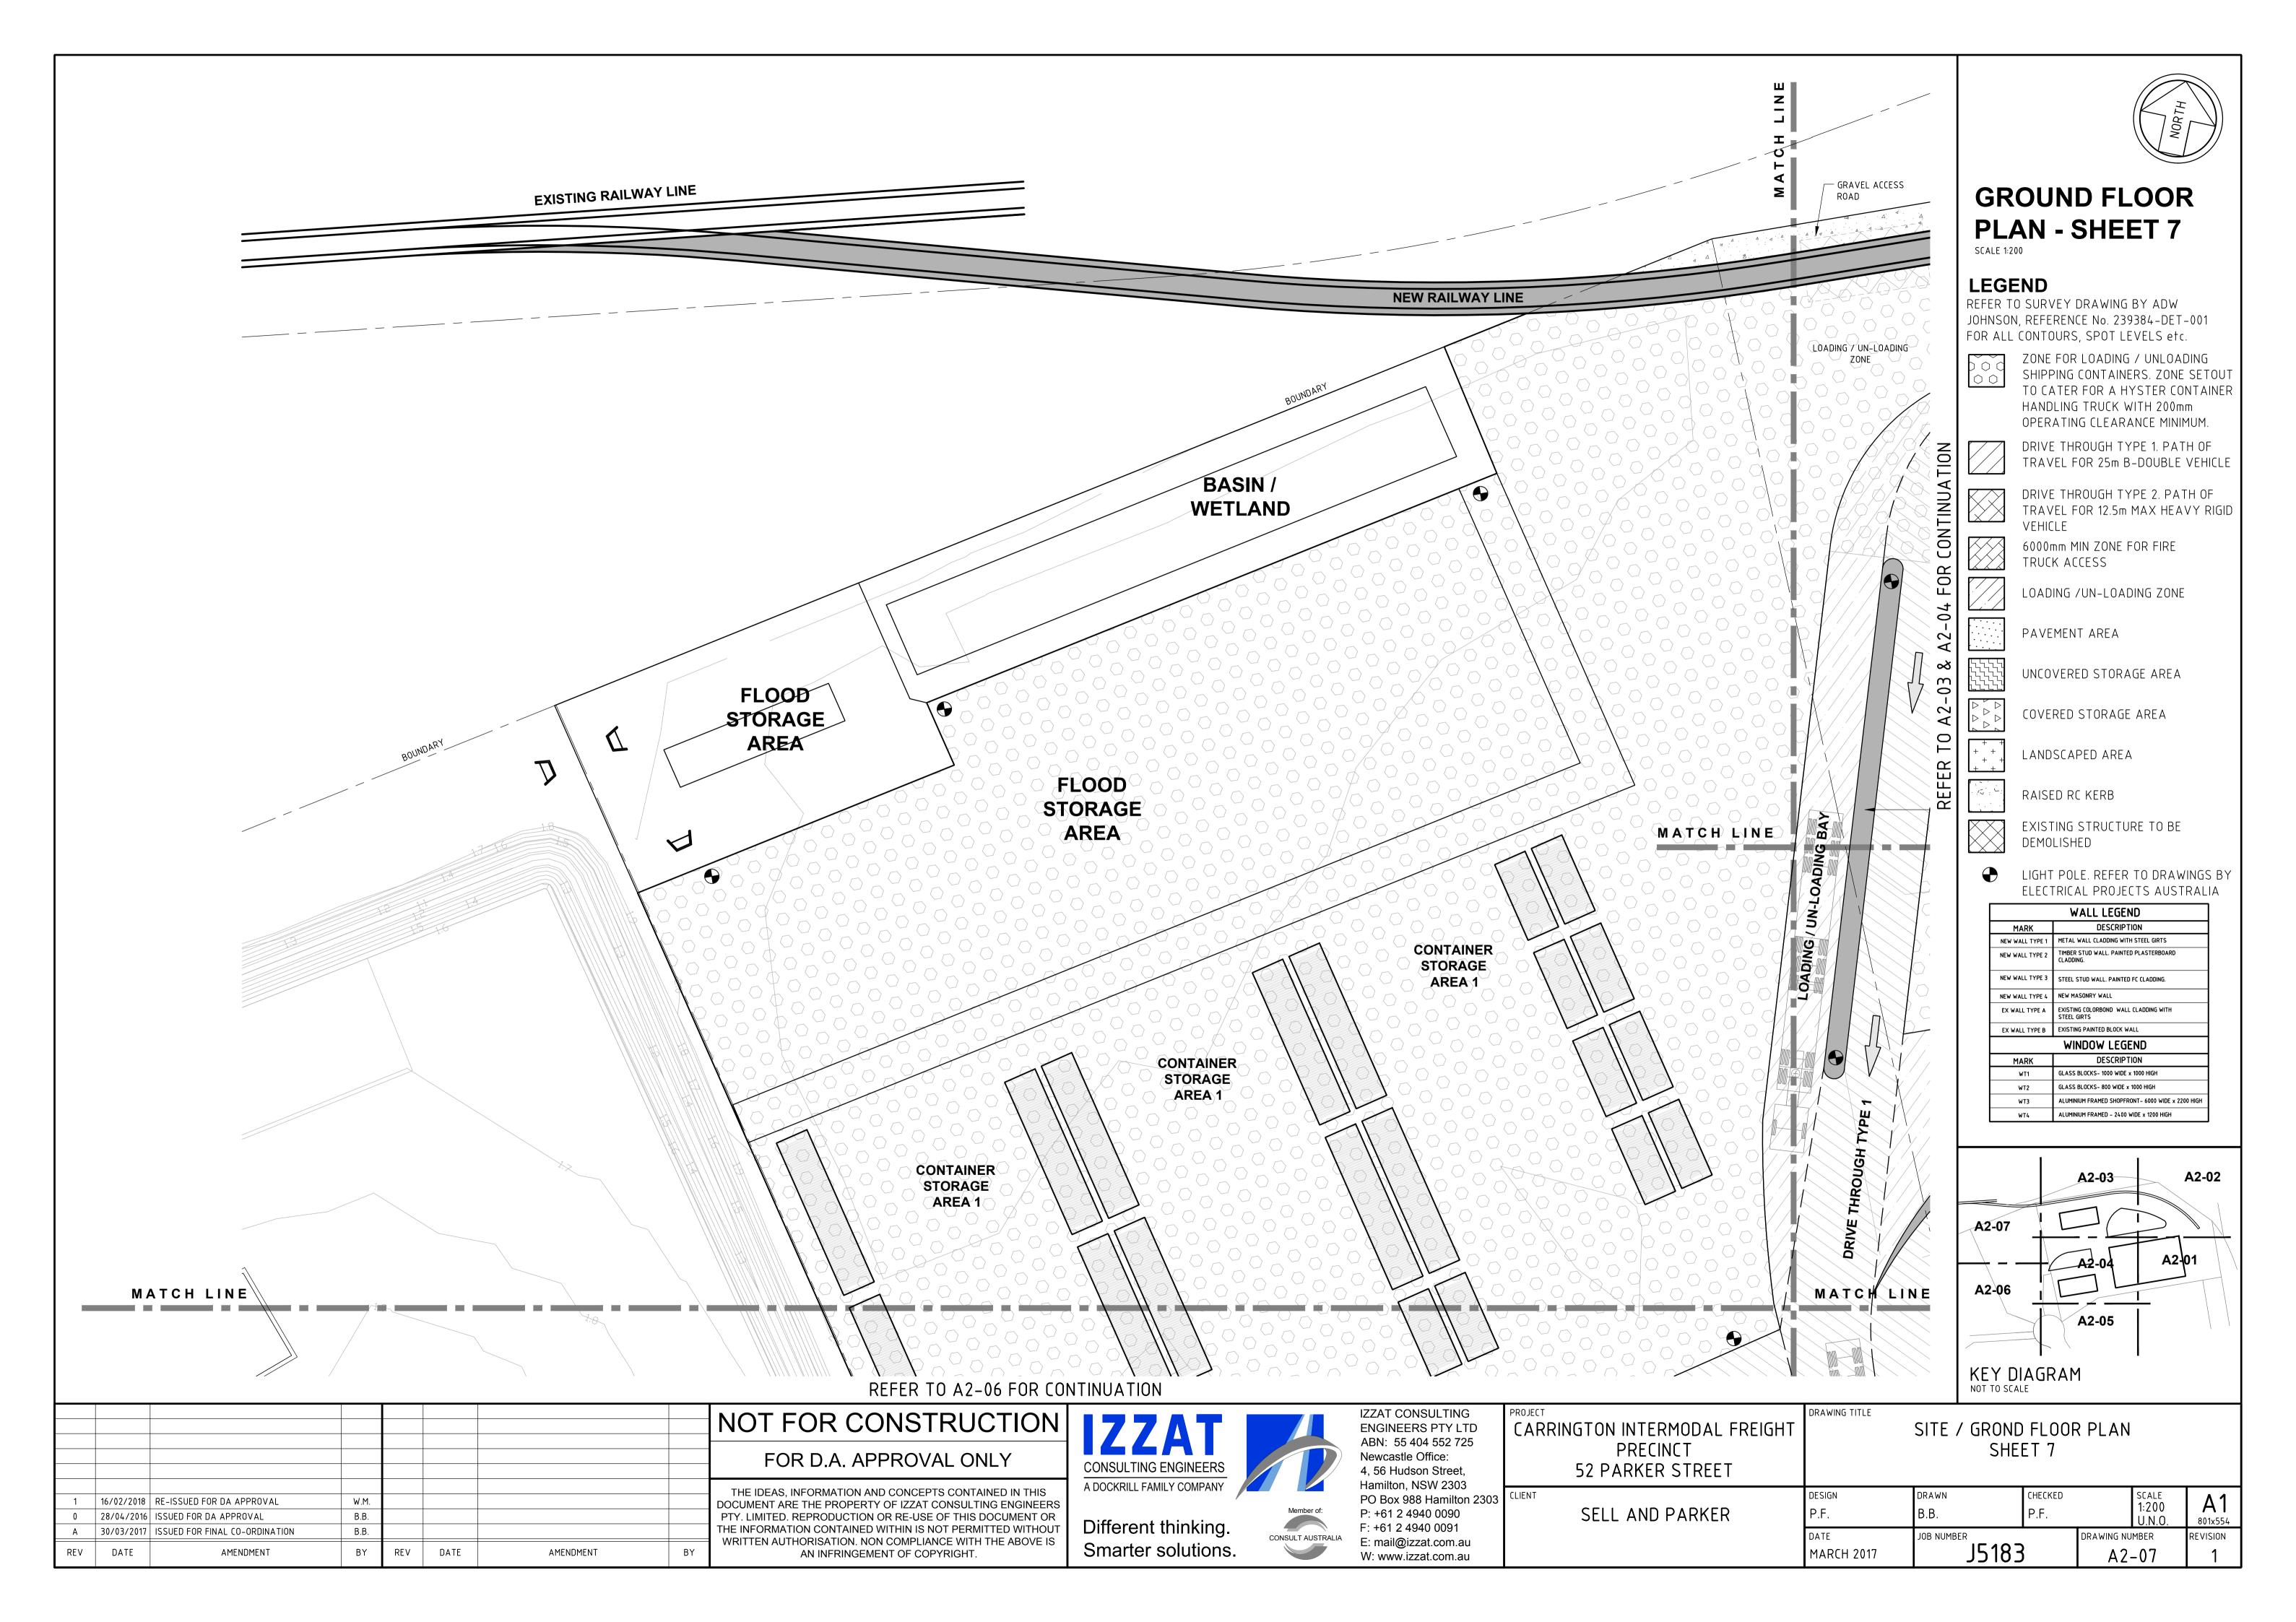

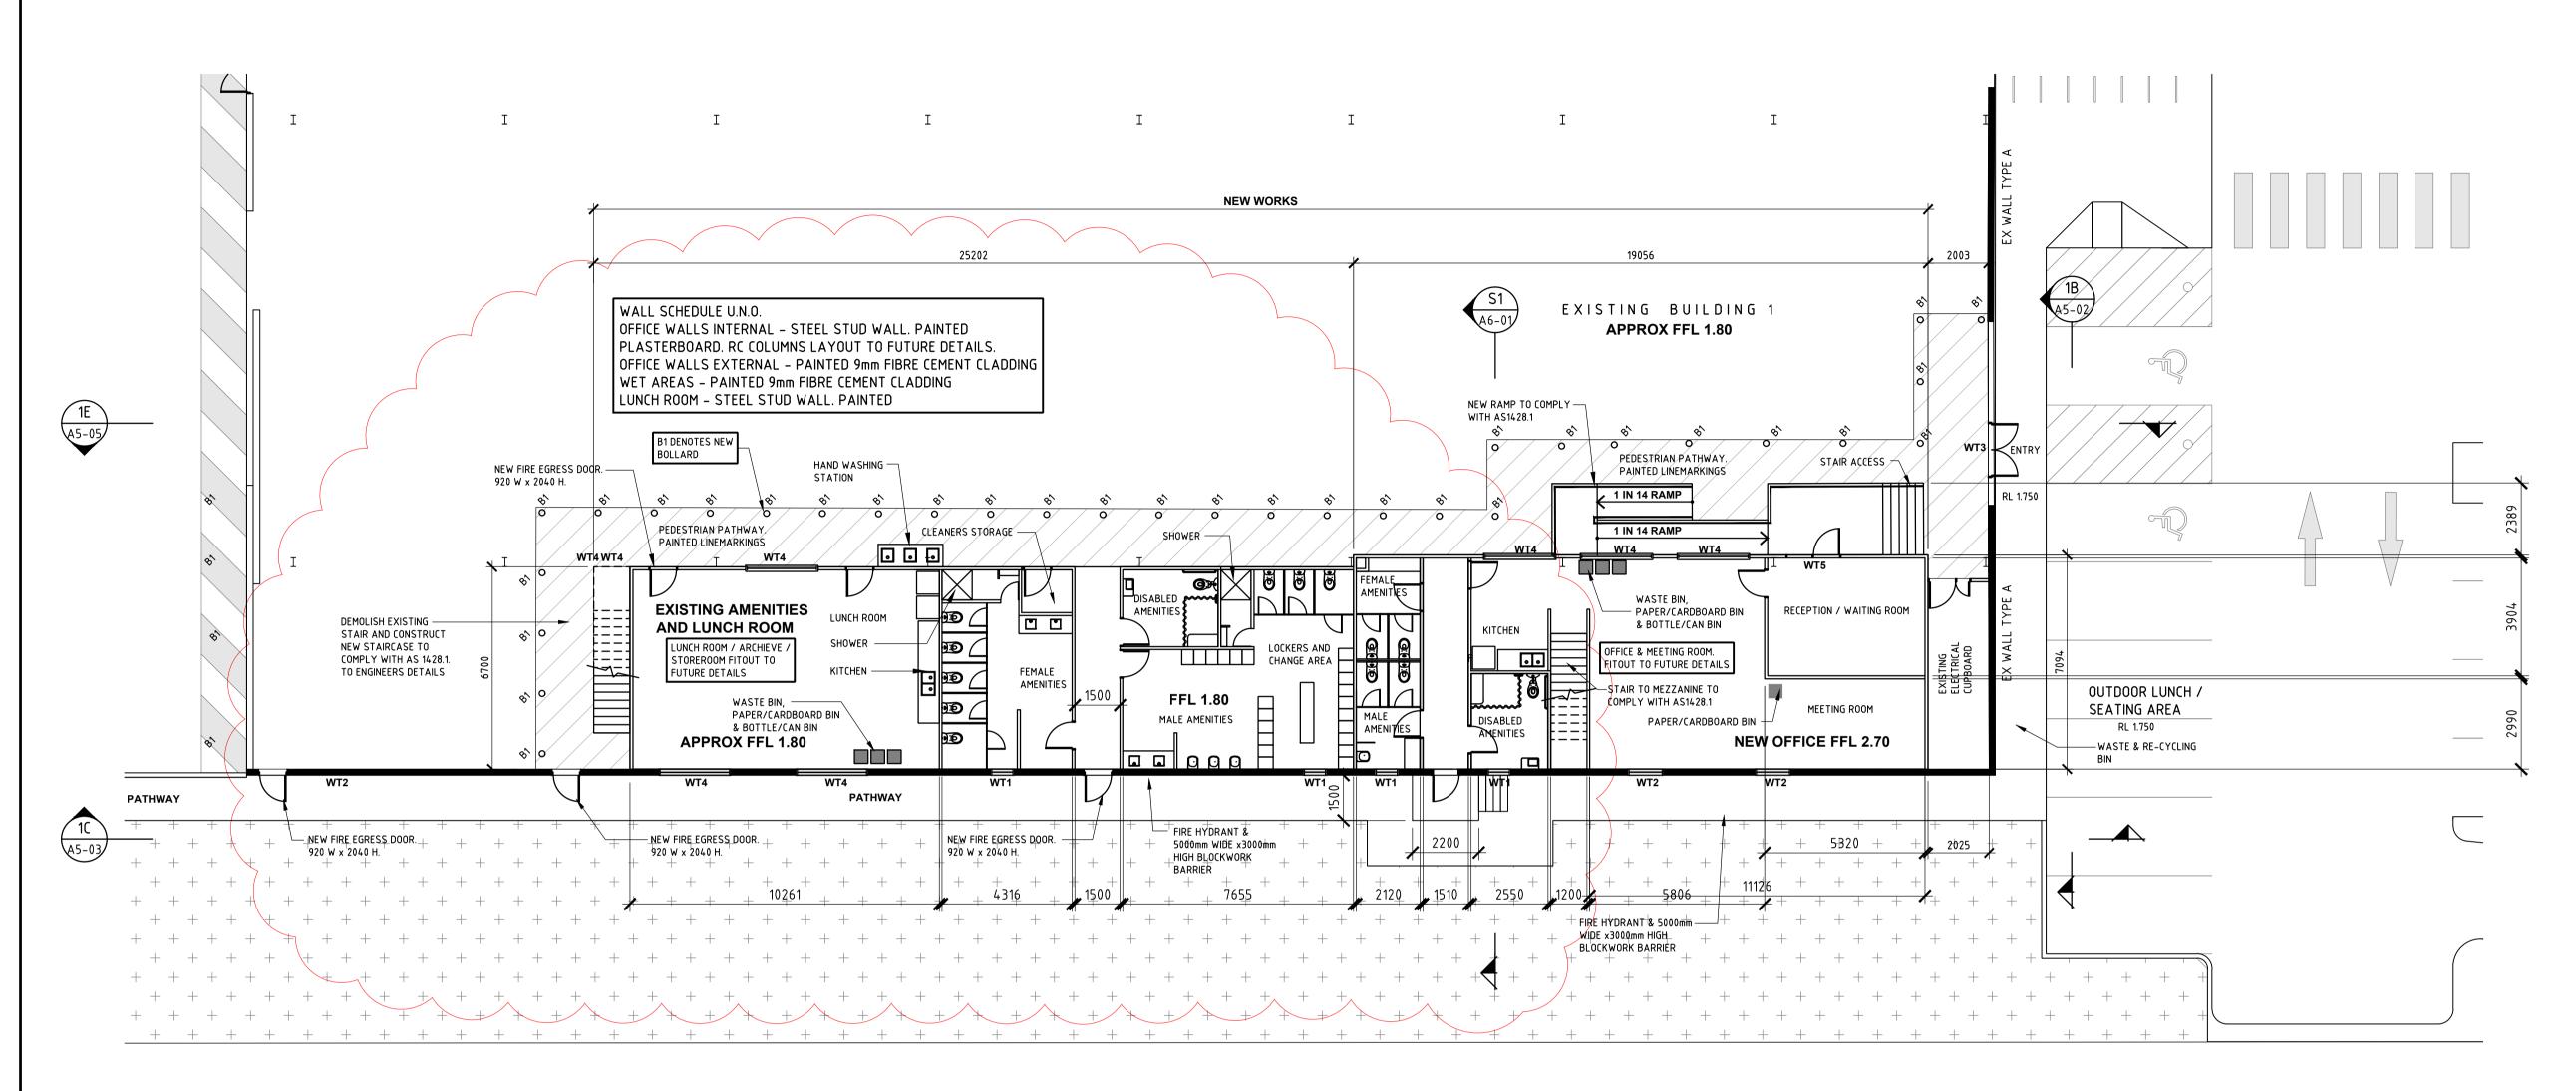



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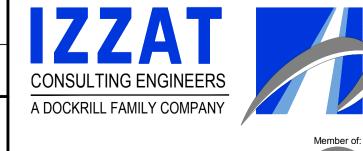
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1	05/01/2018	ISSUED FOR REVIEW - BUILDING 1 REVISED	B.B.					
0	28/04/2016	ISSUED FOR DA APPROVAL	B.B.					
С	30/03/2017	ISSUED FOR FINAL CO-ORDINATION	B.B.					$\mathbf{l}_{D}$
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CARRINGTON INTERMODAL FREIGHT PRECINCT 52 PARKER STREET	DRAWING TITLE	BI AND
SELL AND PARKER	DESIGN P.F.	drawn B.B.

MARCH 2017

BUILDING 1 OFFICE
AND AMENITIES PLANS

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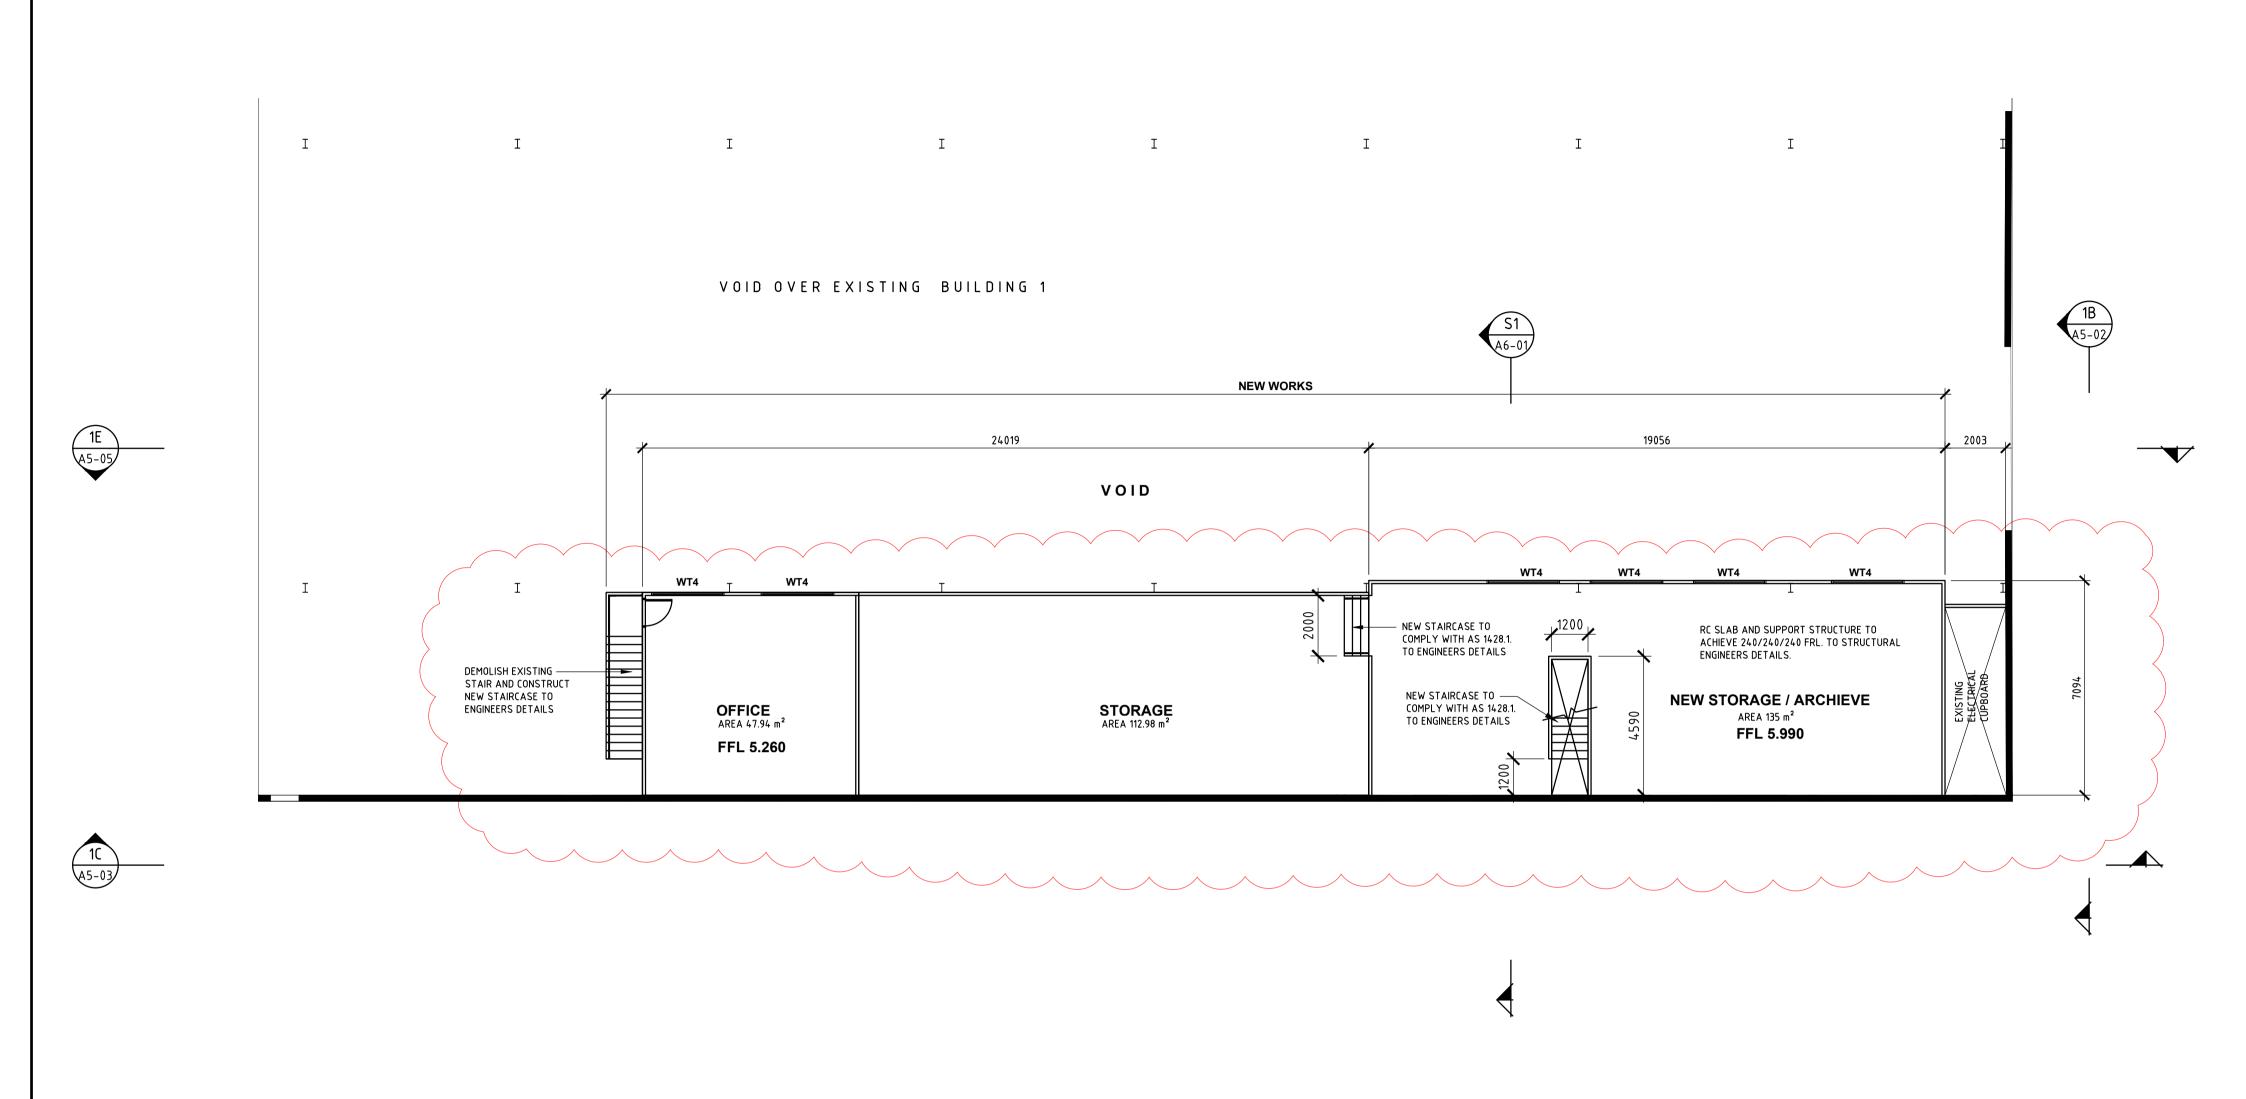
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REVISION

BUILDING 1 OFFICE
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J5183





WALL LEGEND
DESCRIPTION
METAL WALL CLADDING WITH STEEL GIRTS
TIMBER STUD WALL. PAINTED PLASTERBOARD CLADDING.
STEEL STUD WALL. PAINTED FC CLADDING.
NEW MASONRY WALL
EXISTING COLORBOND WALL CLADDING WITH STEEL GIRTS
EXISTING PAINTED BLOCK WALL
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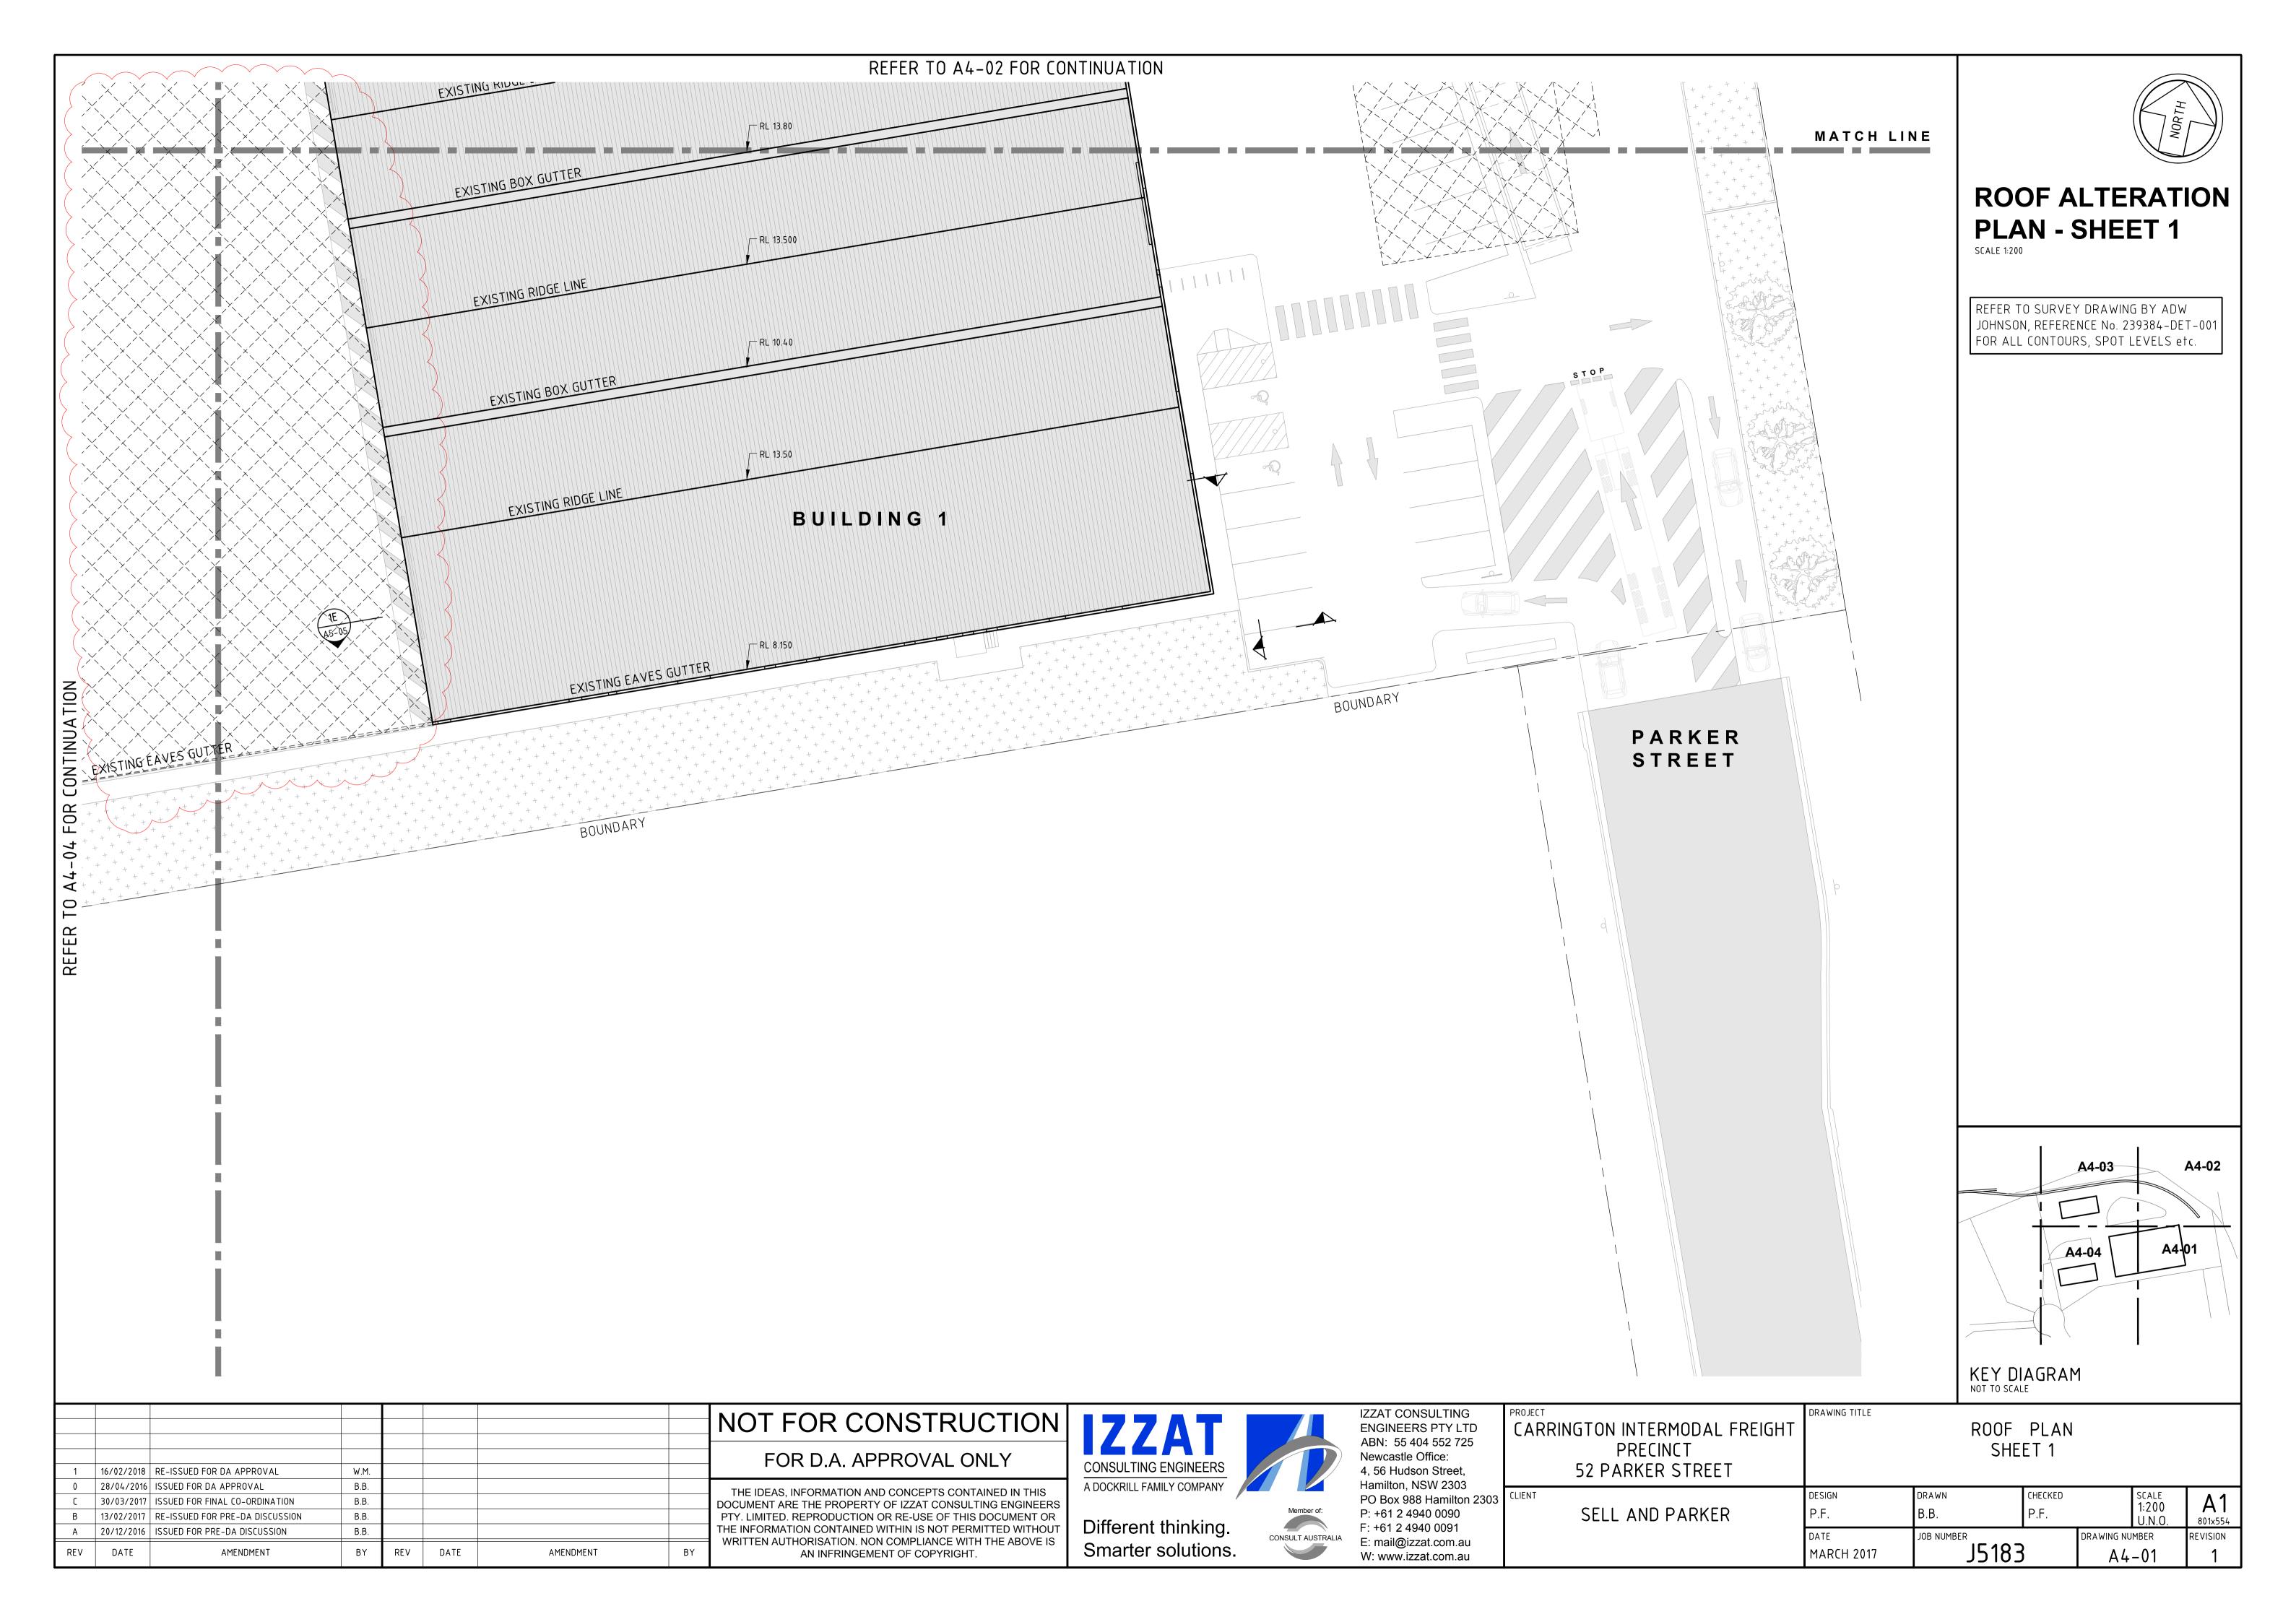
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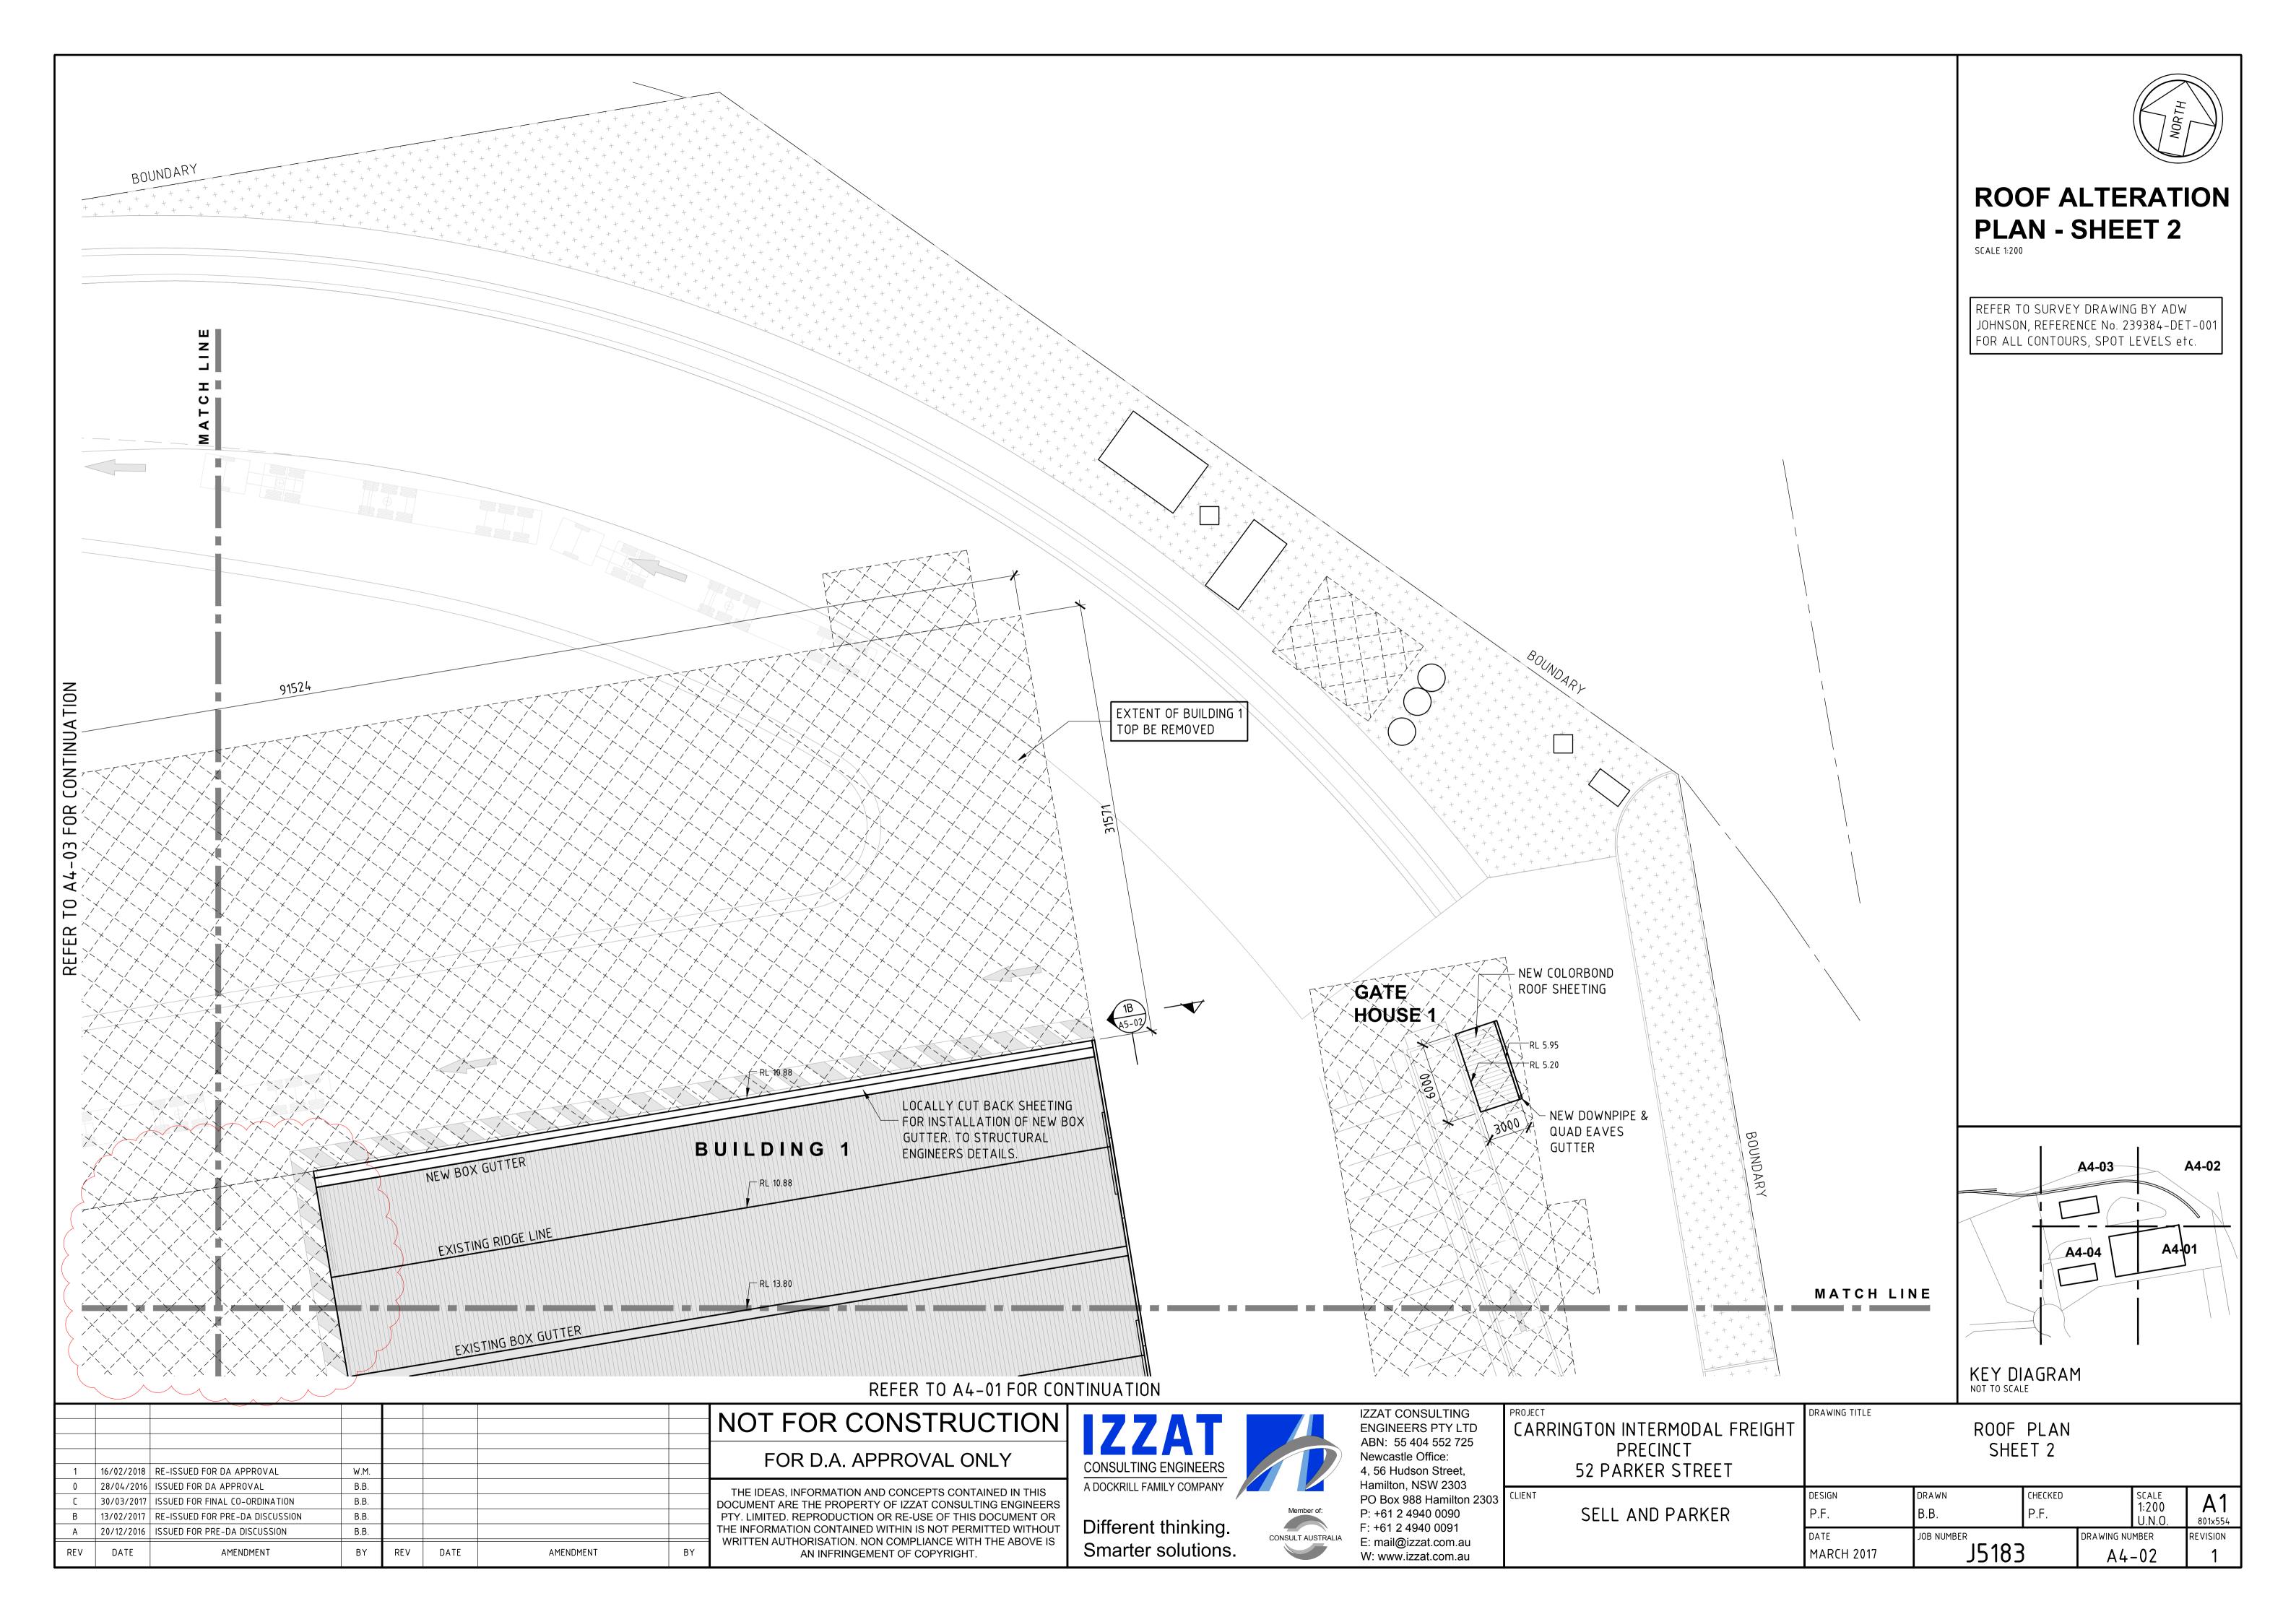
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CARRINGTON INTERMODAL FREIGHT
PRECINCT
52 PARKER STREET


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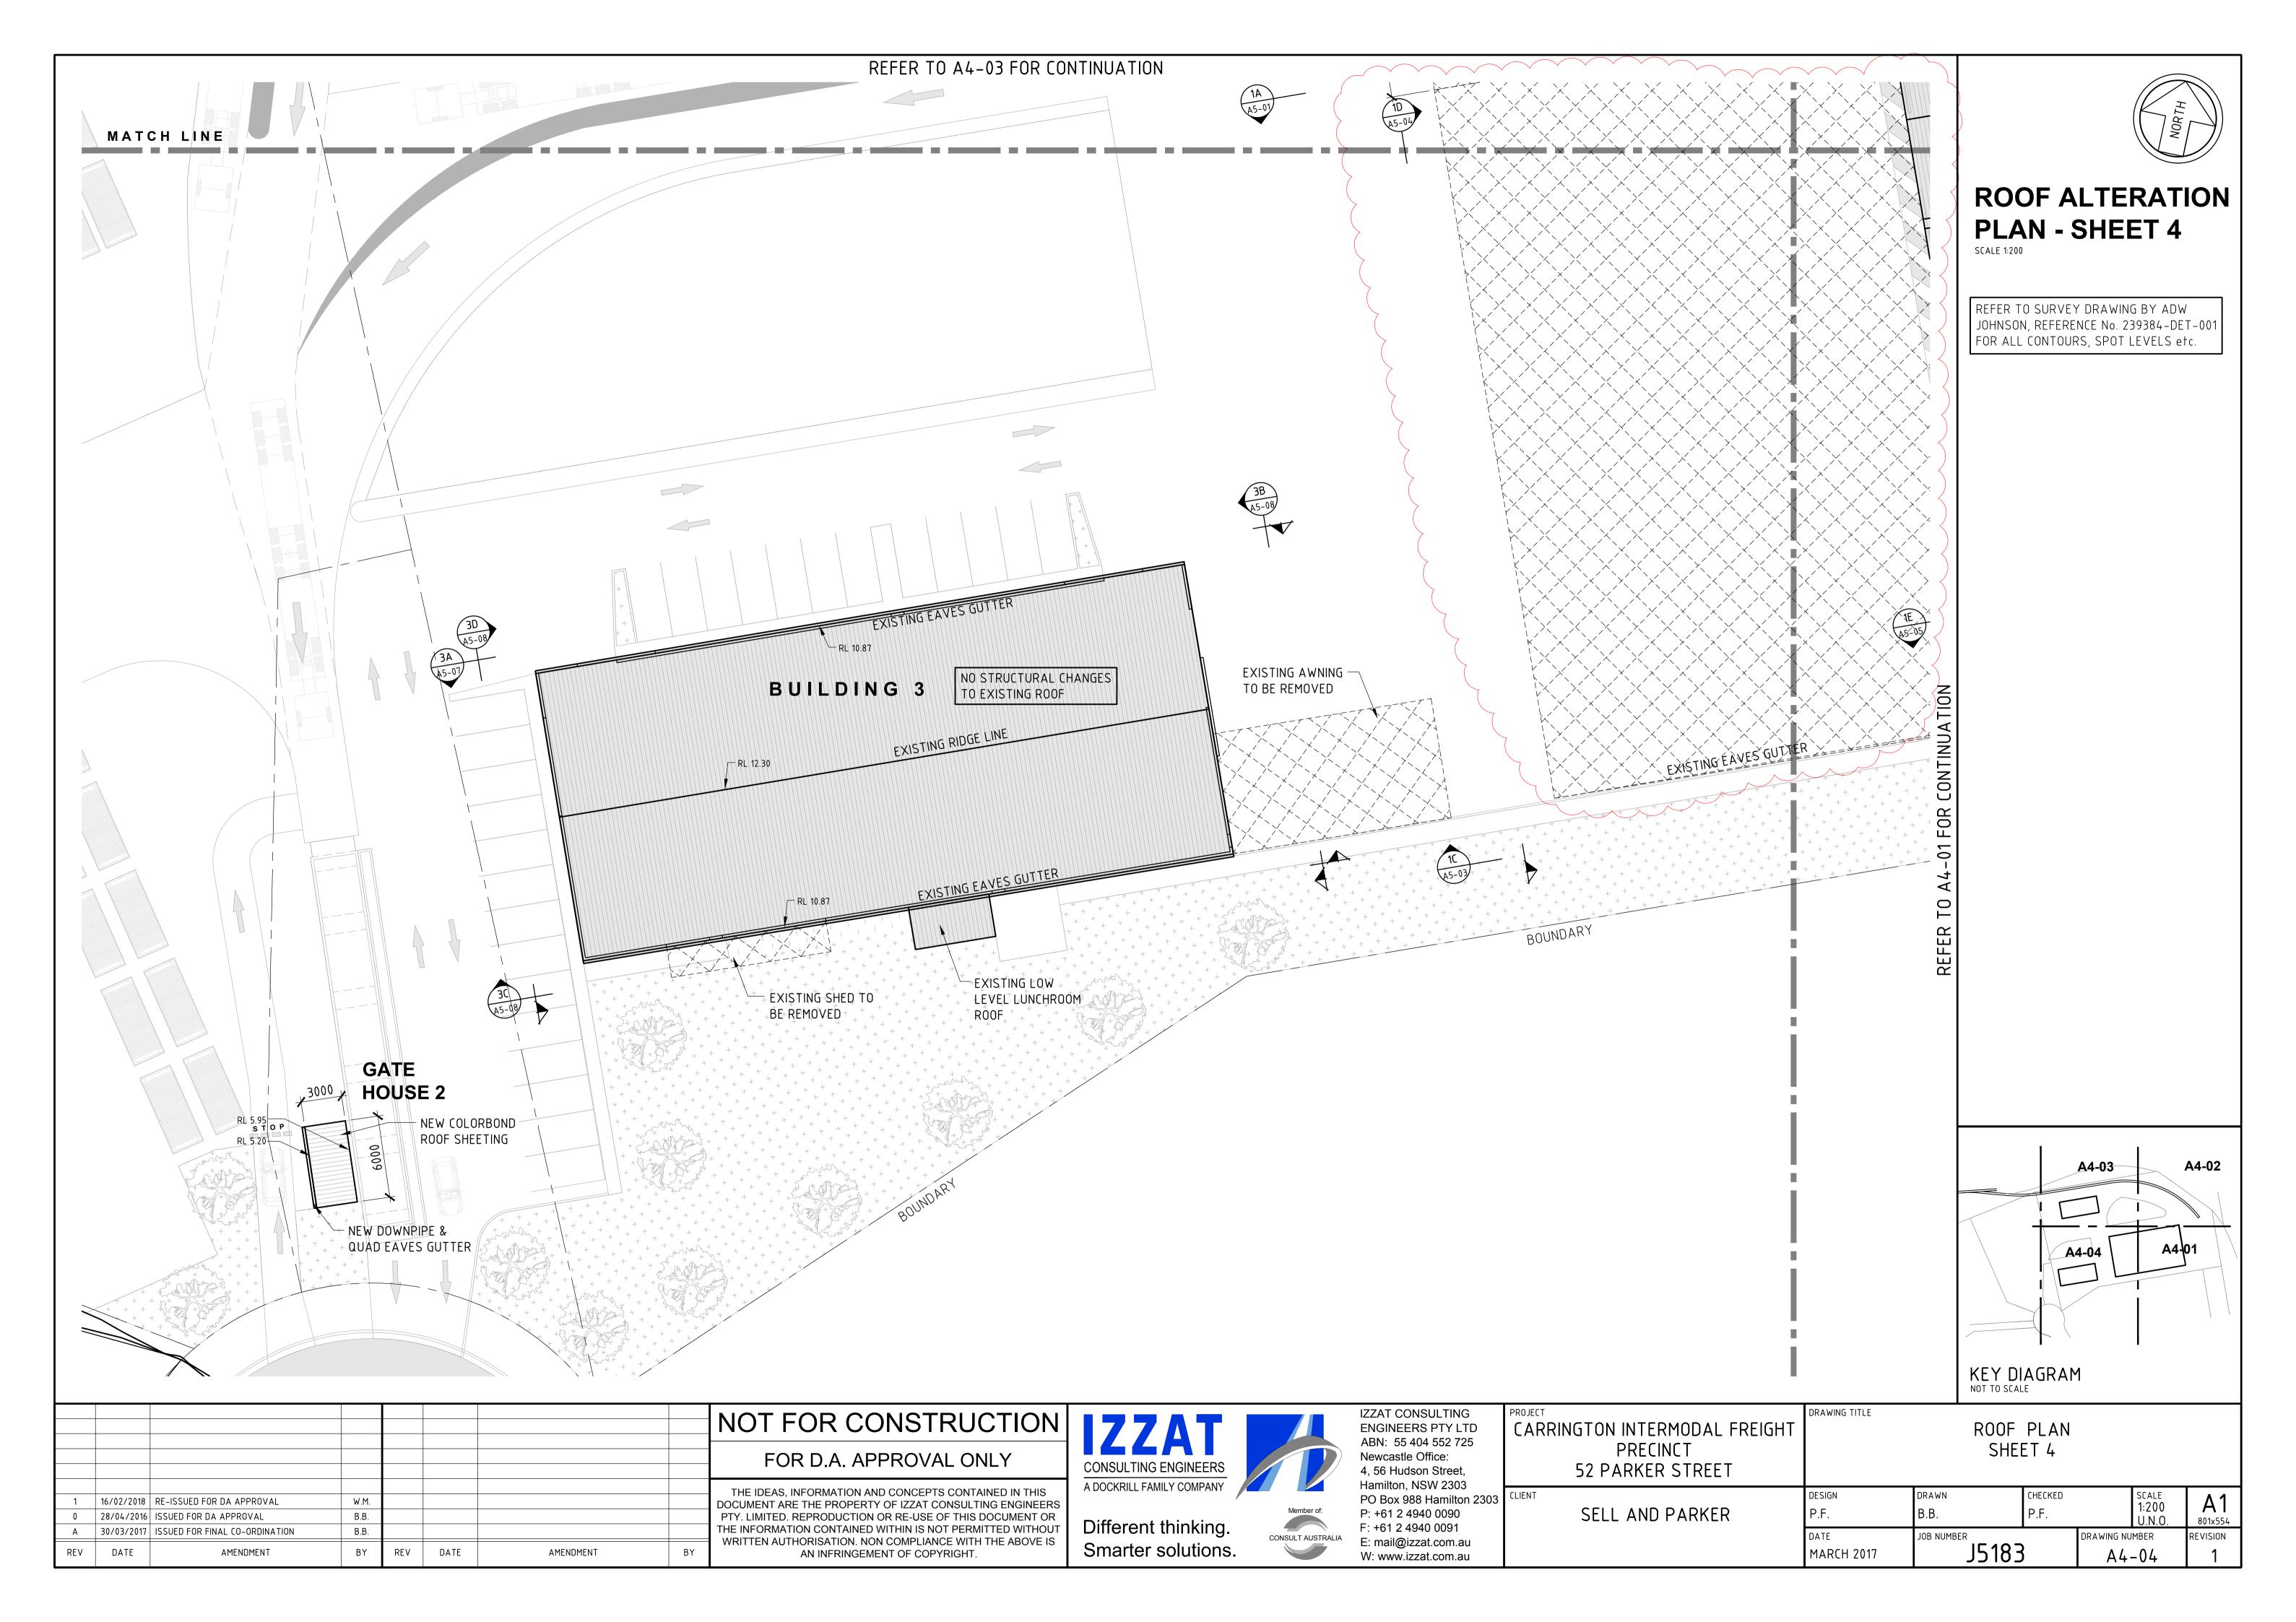
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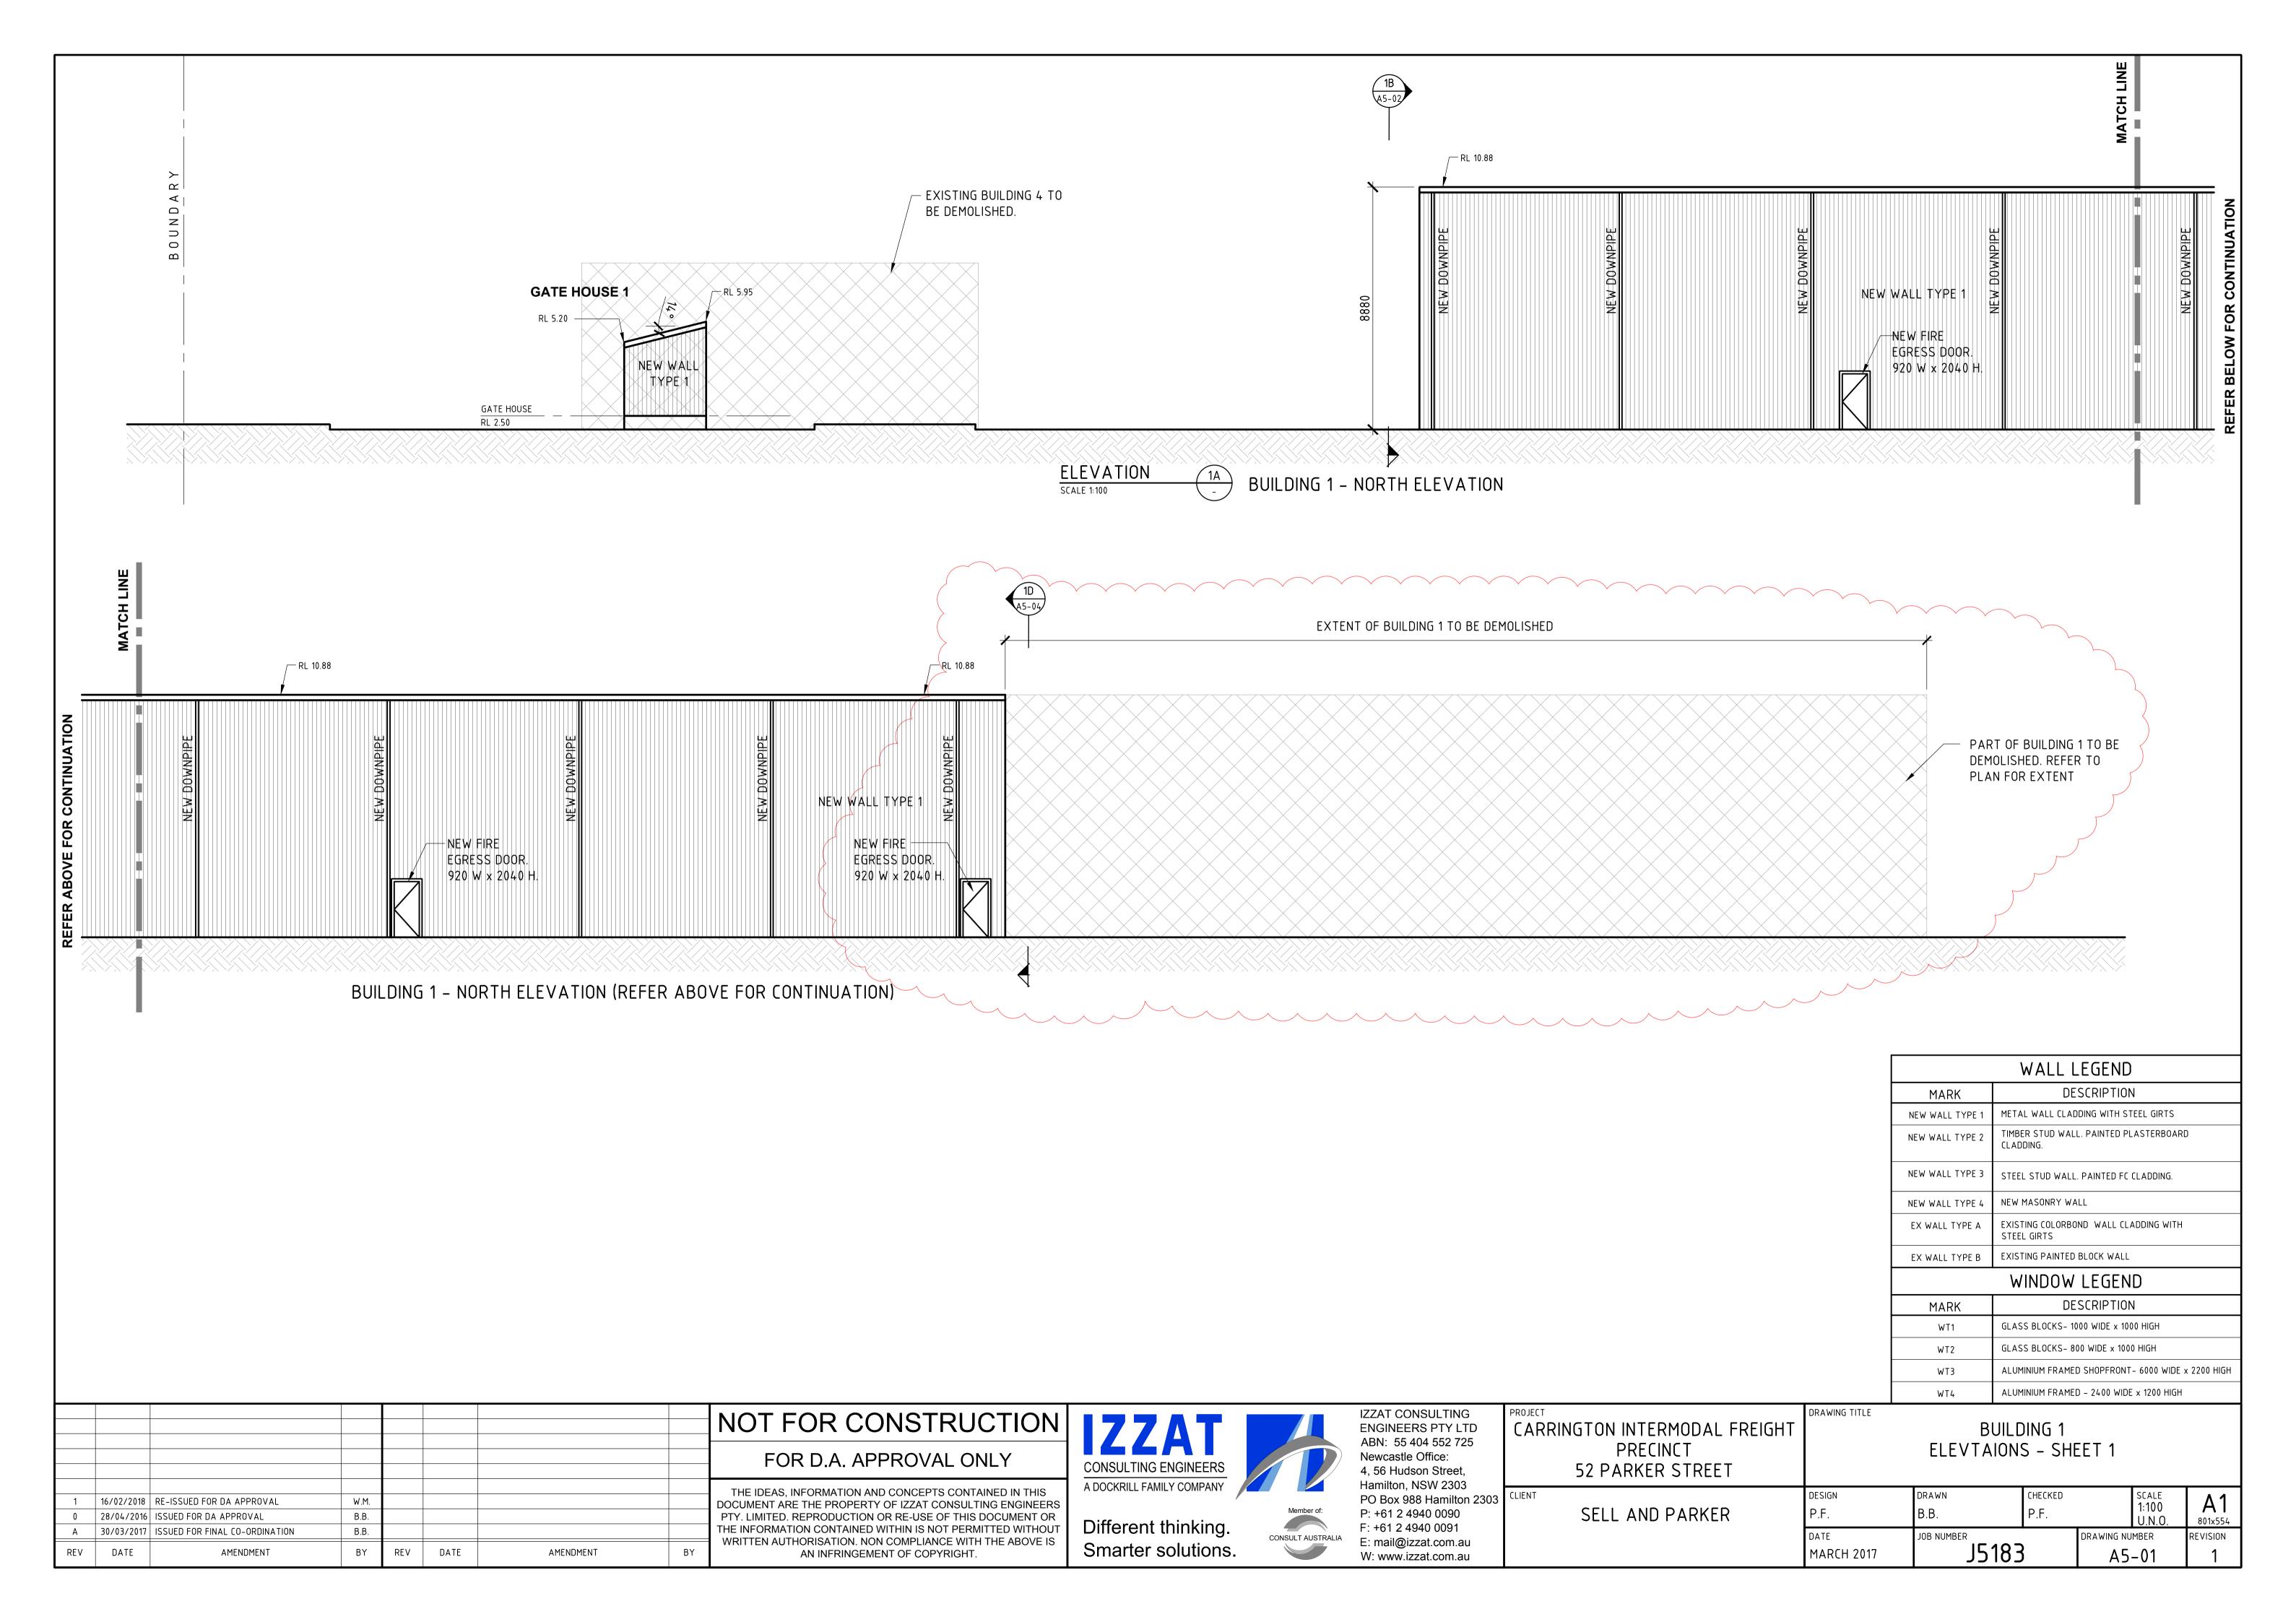
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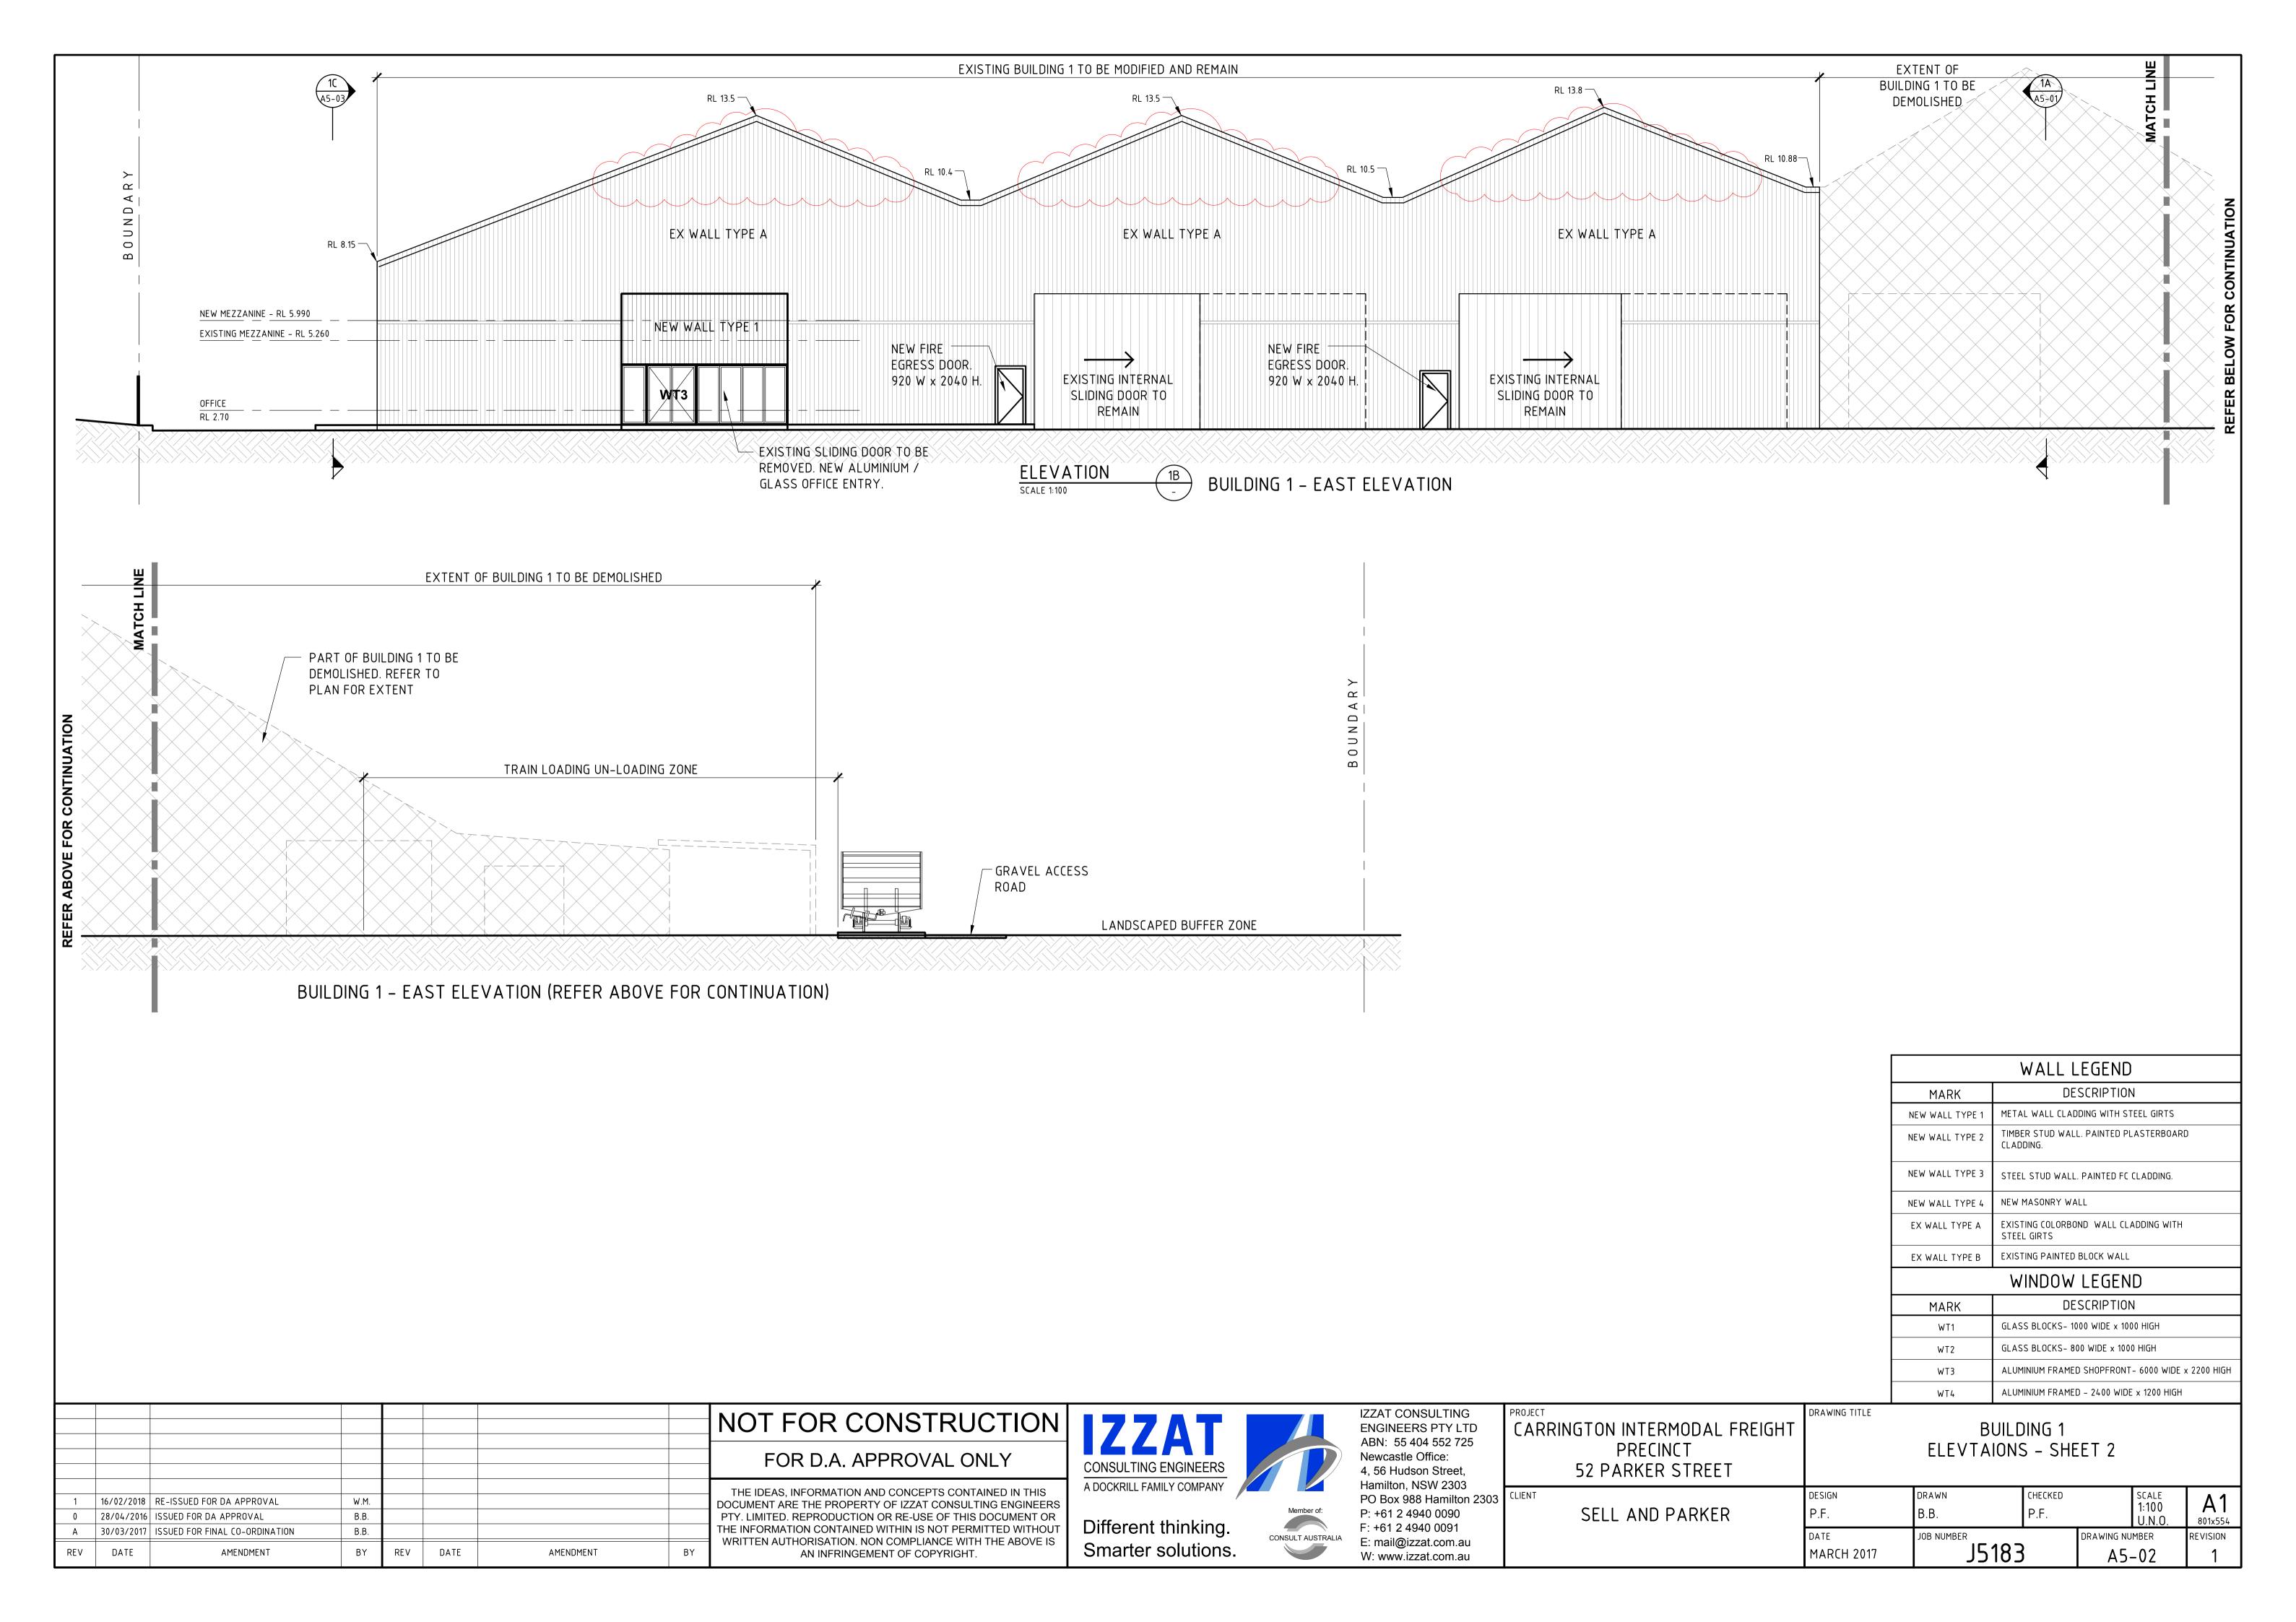














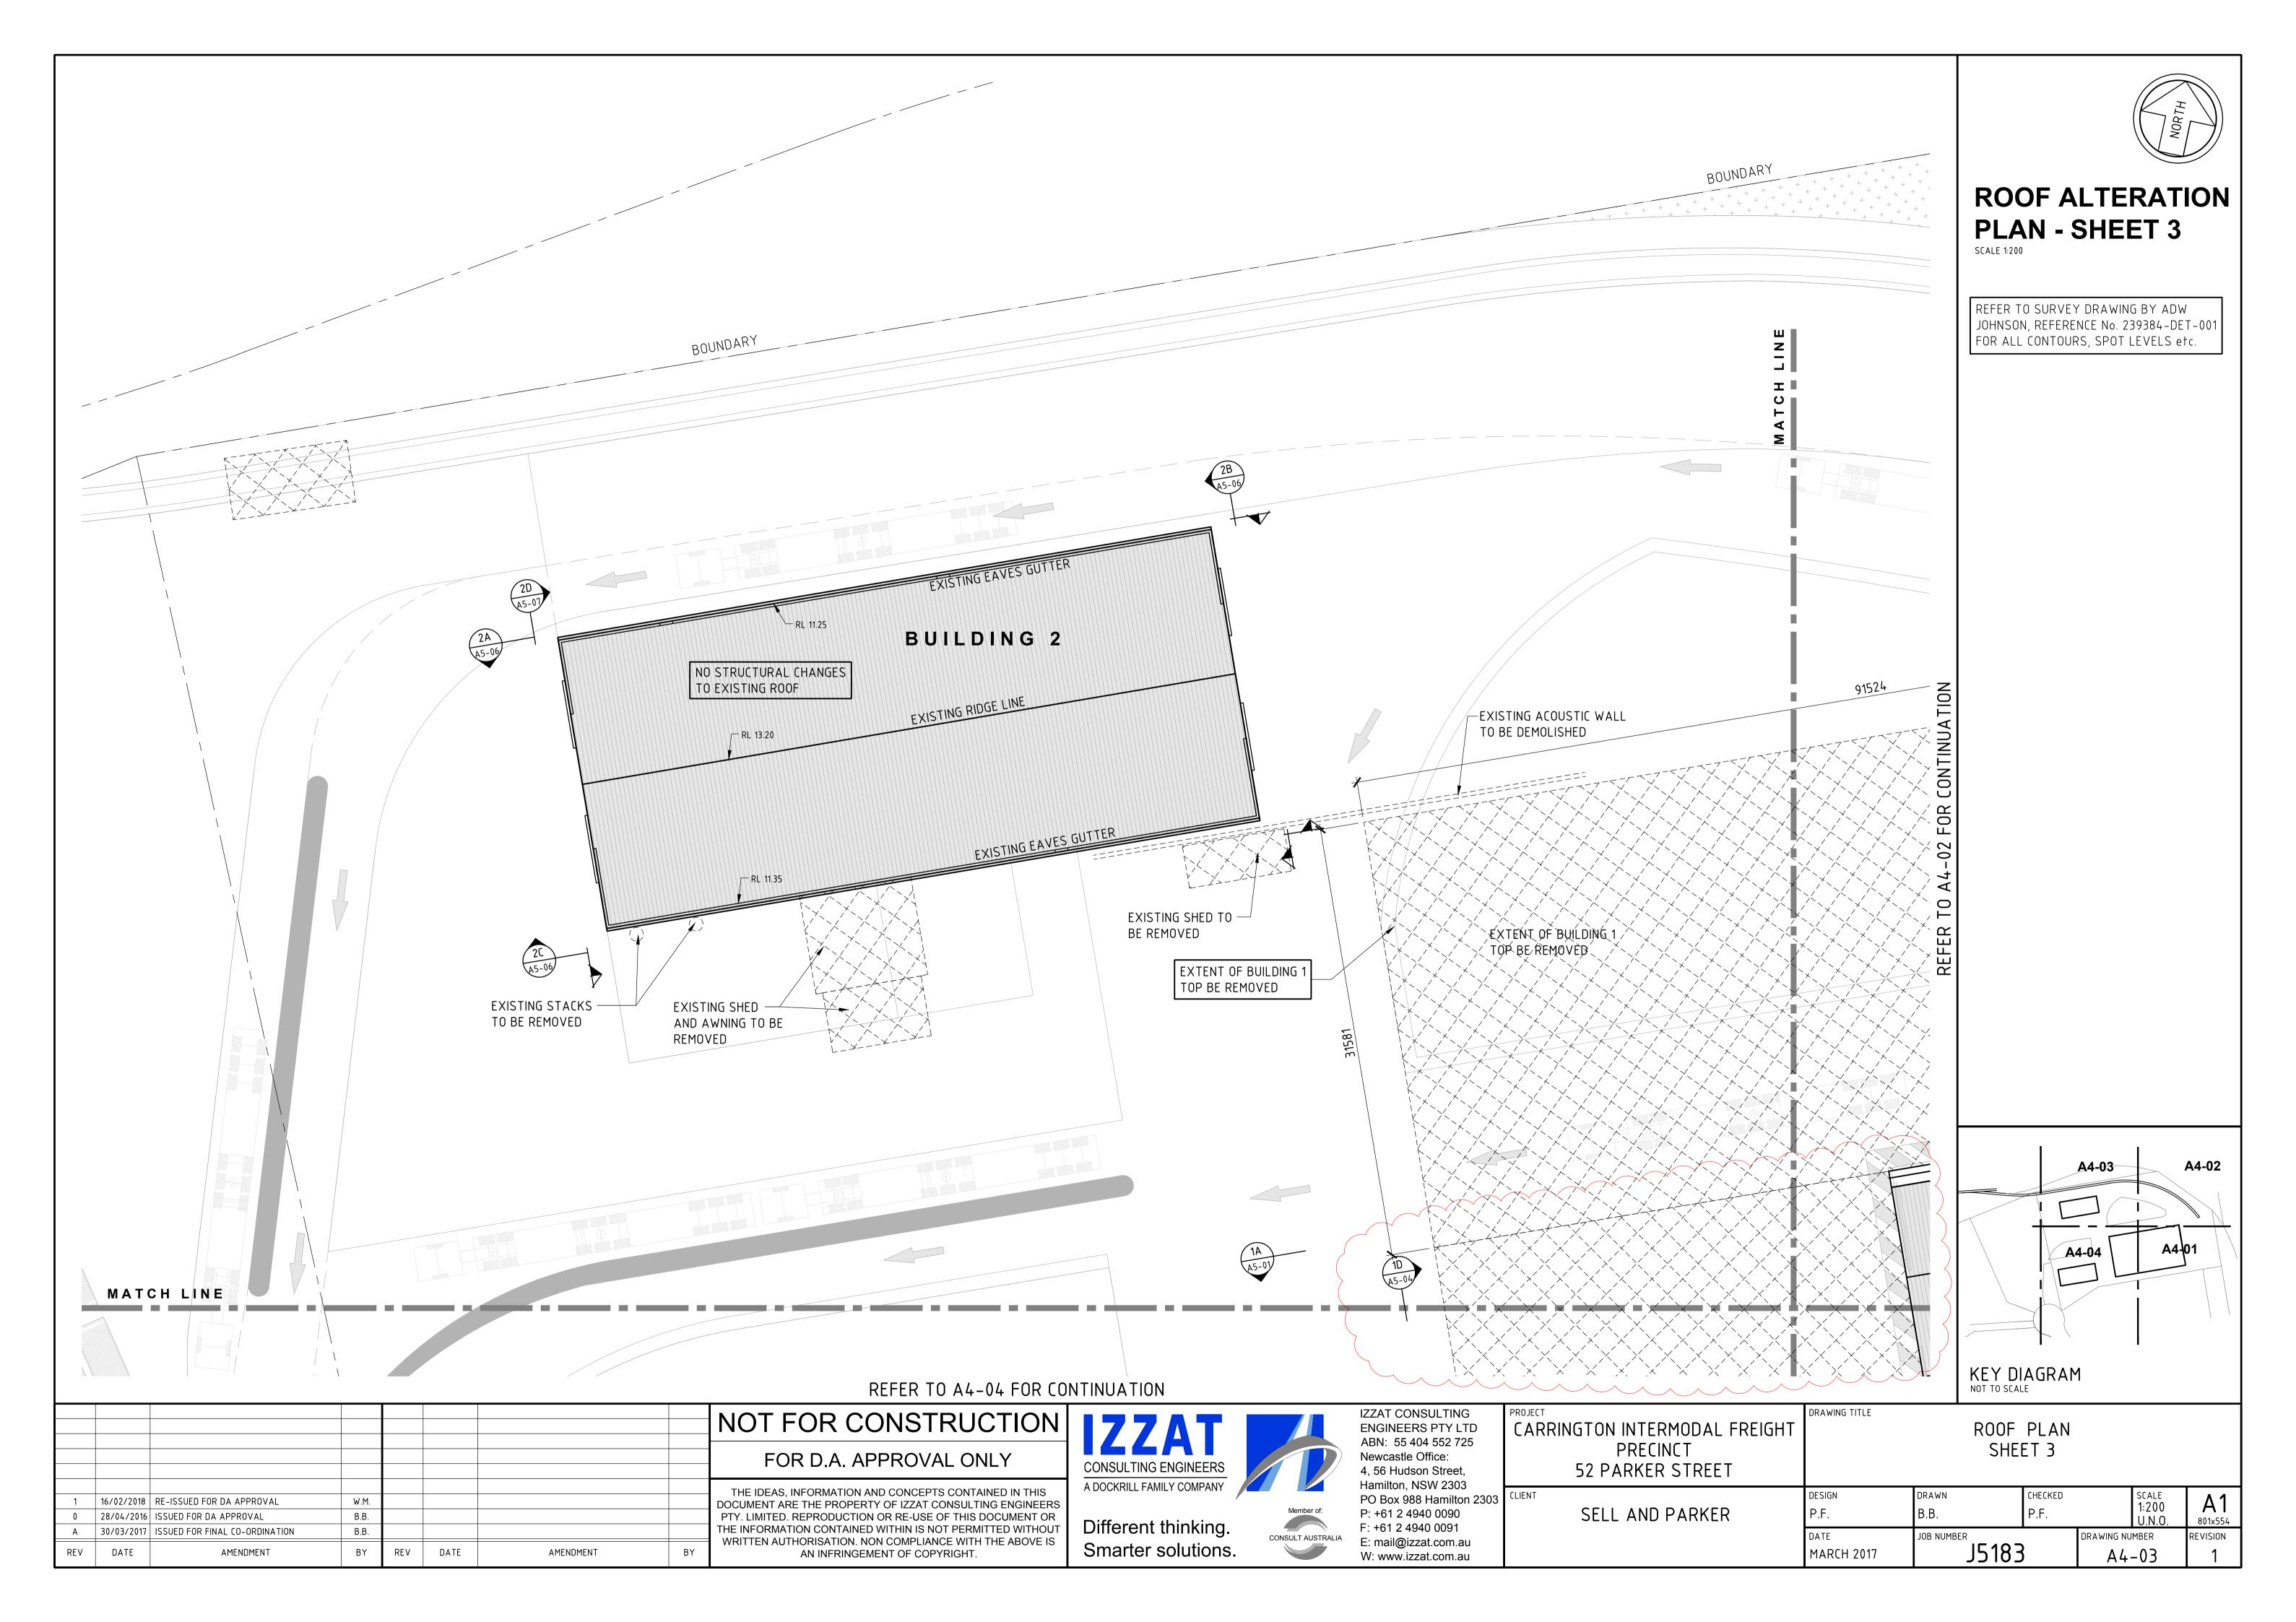


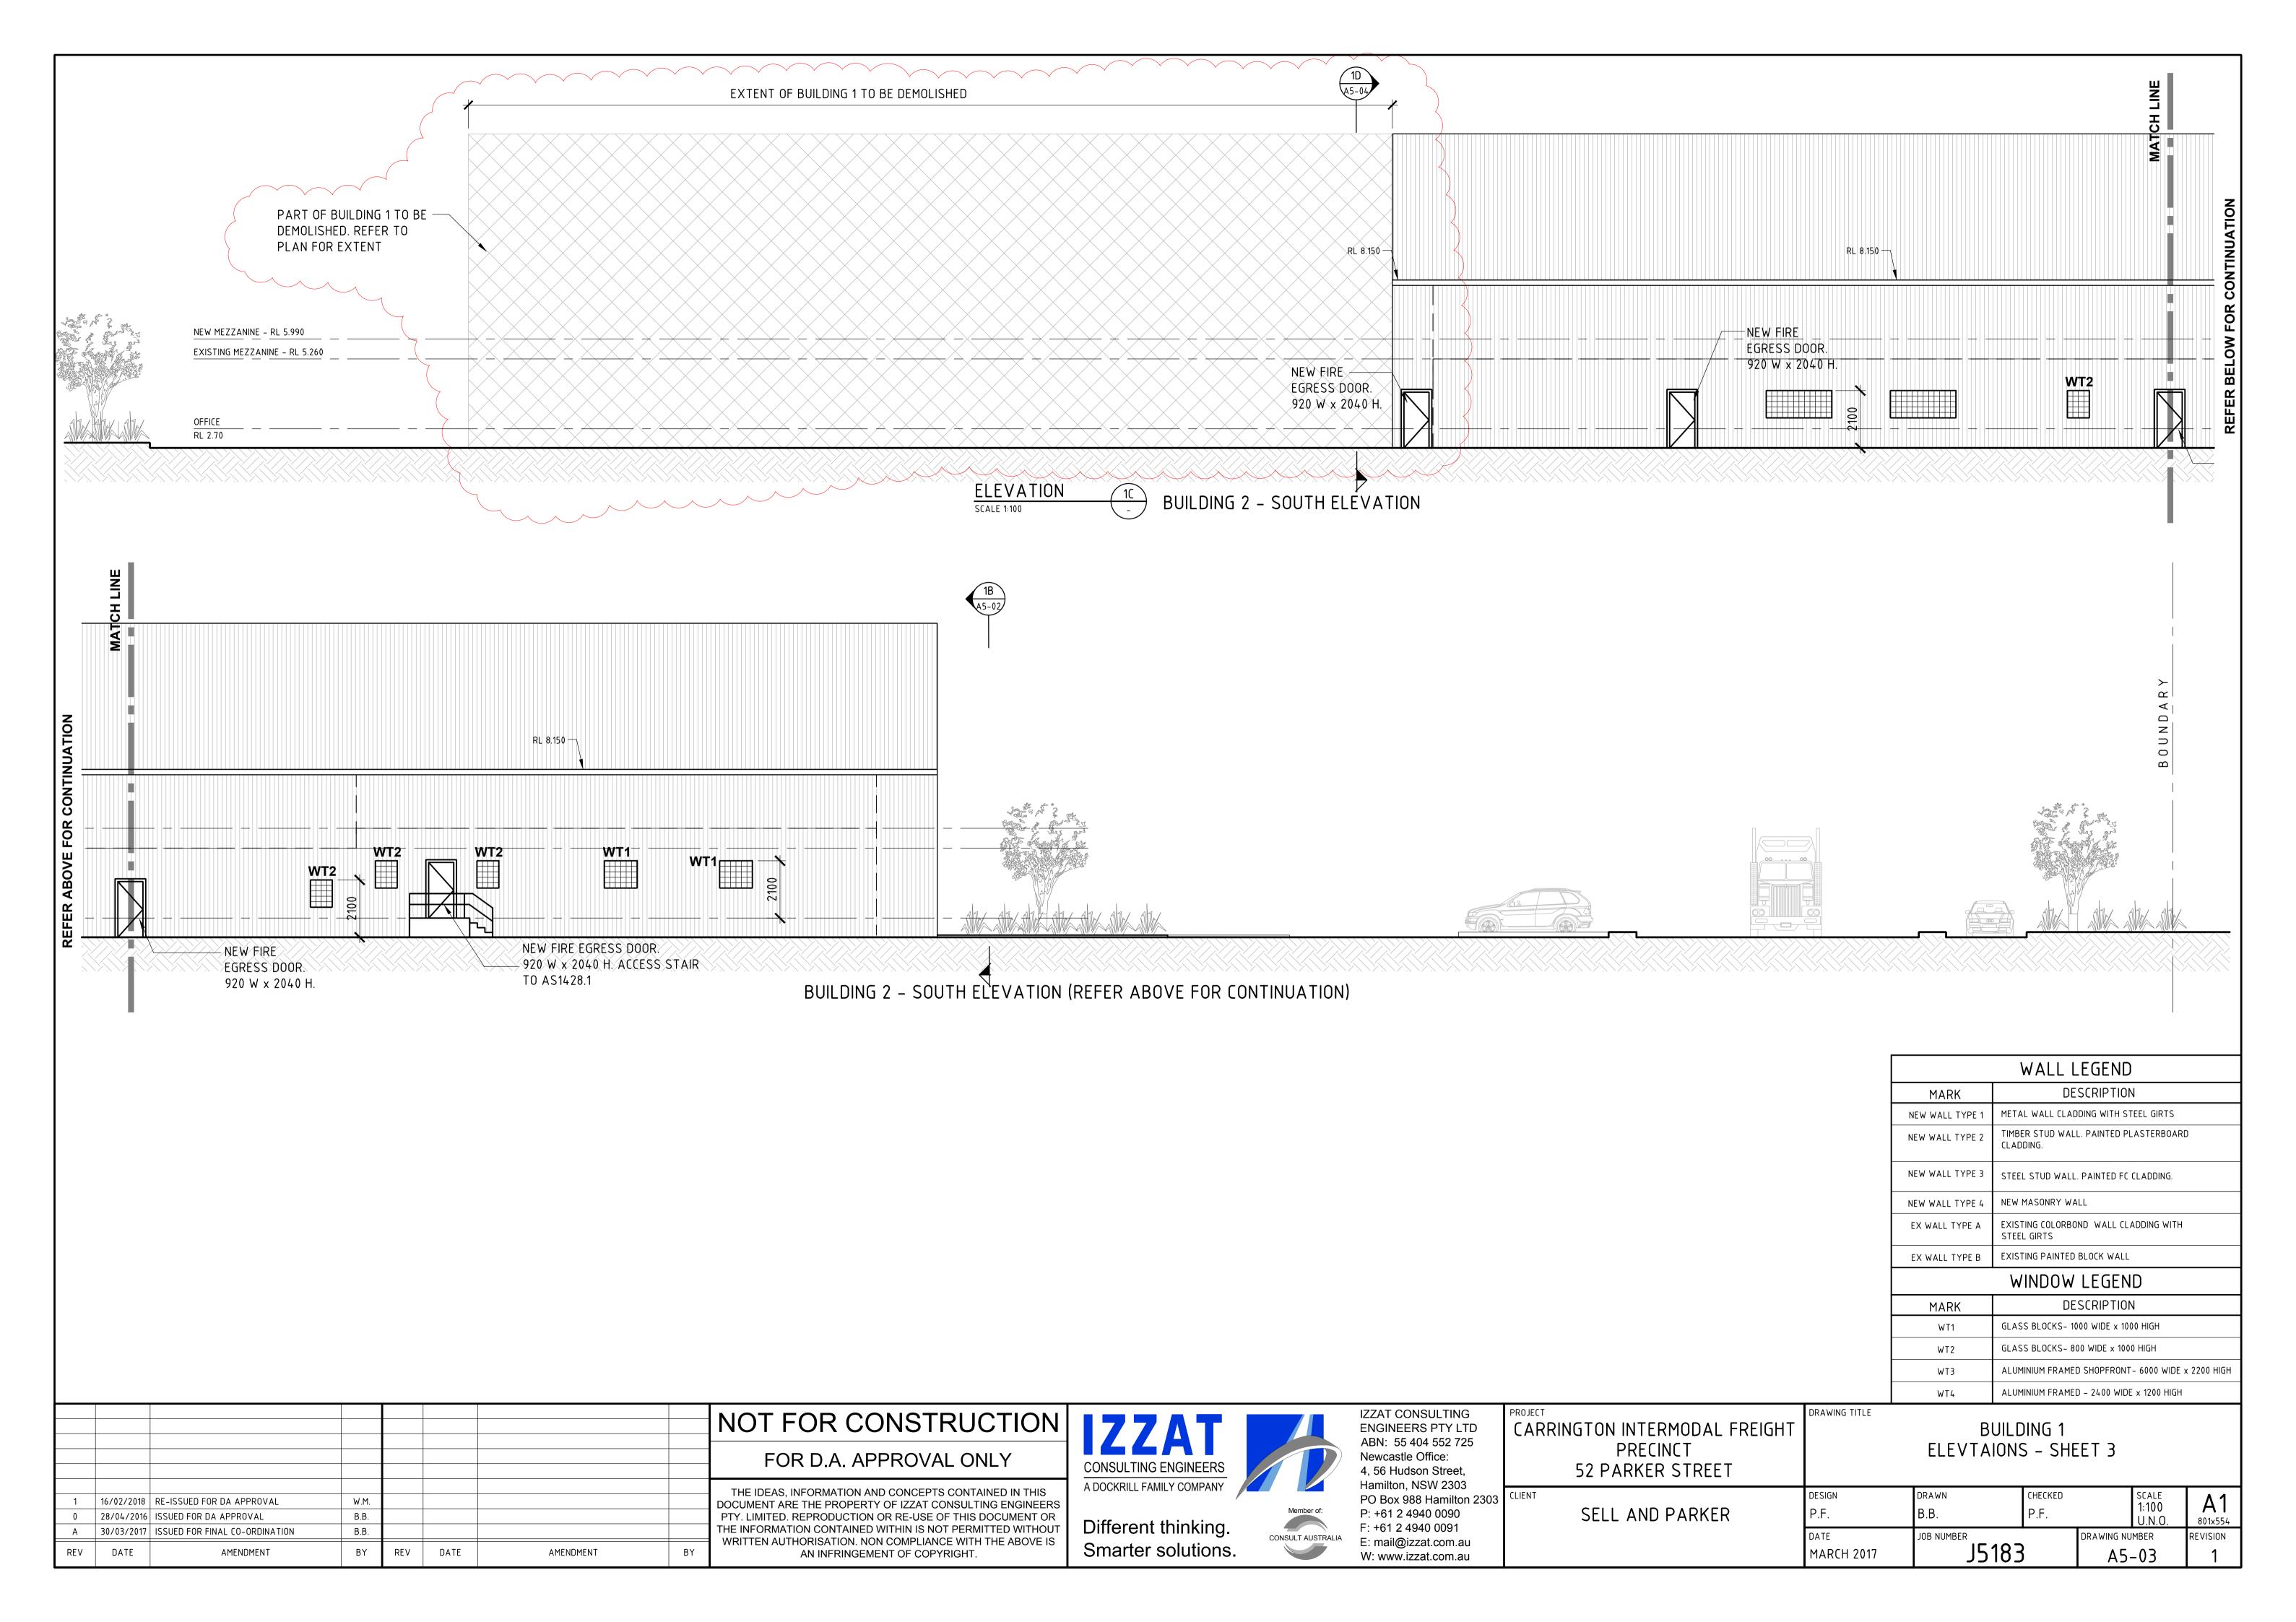

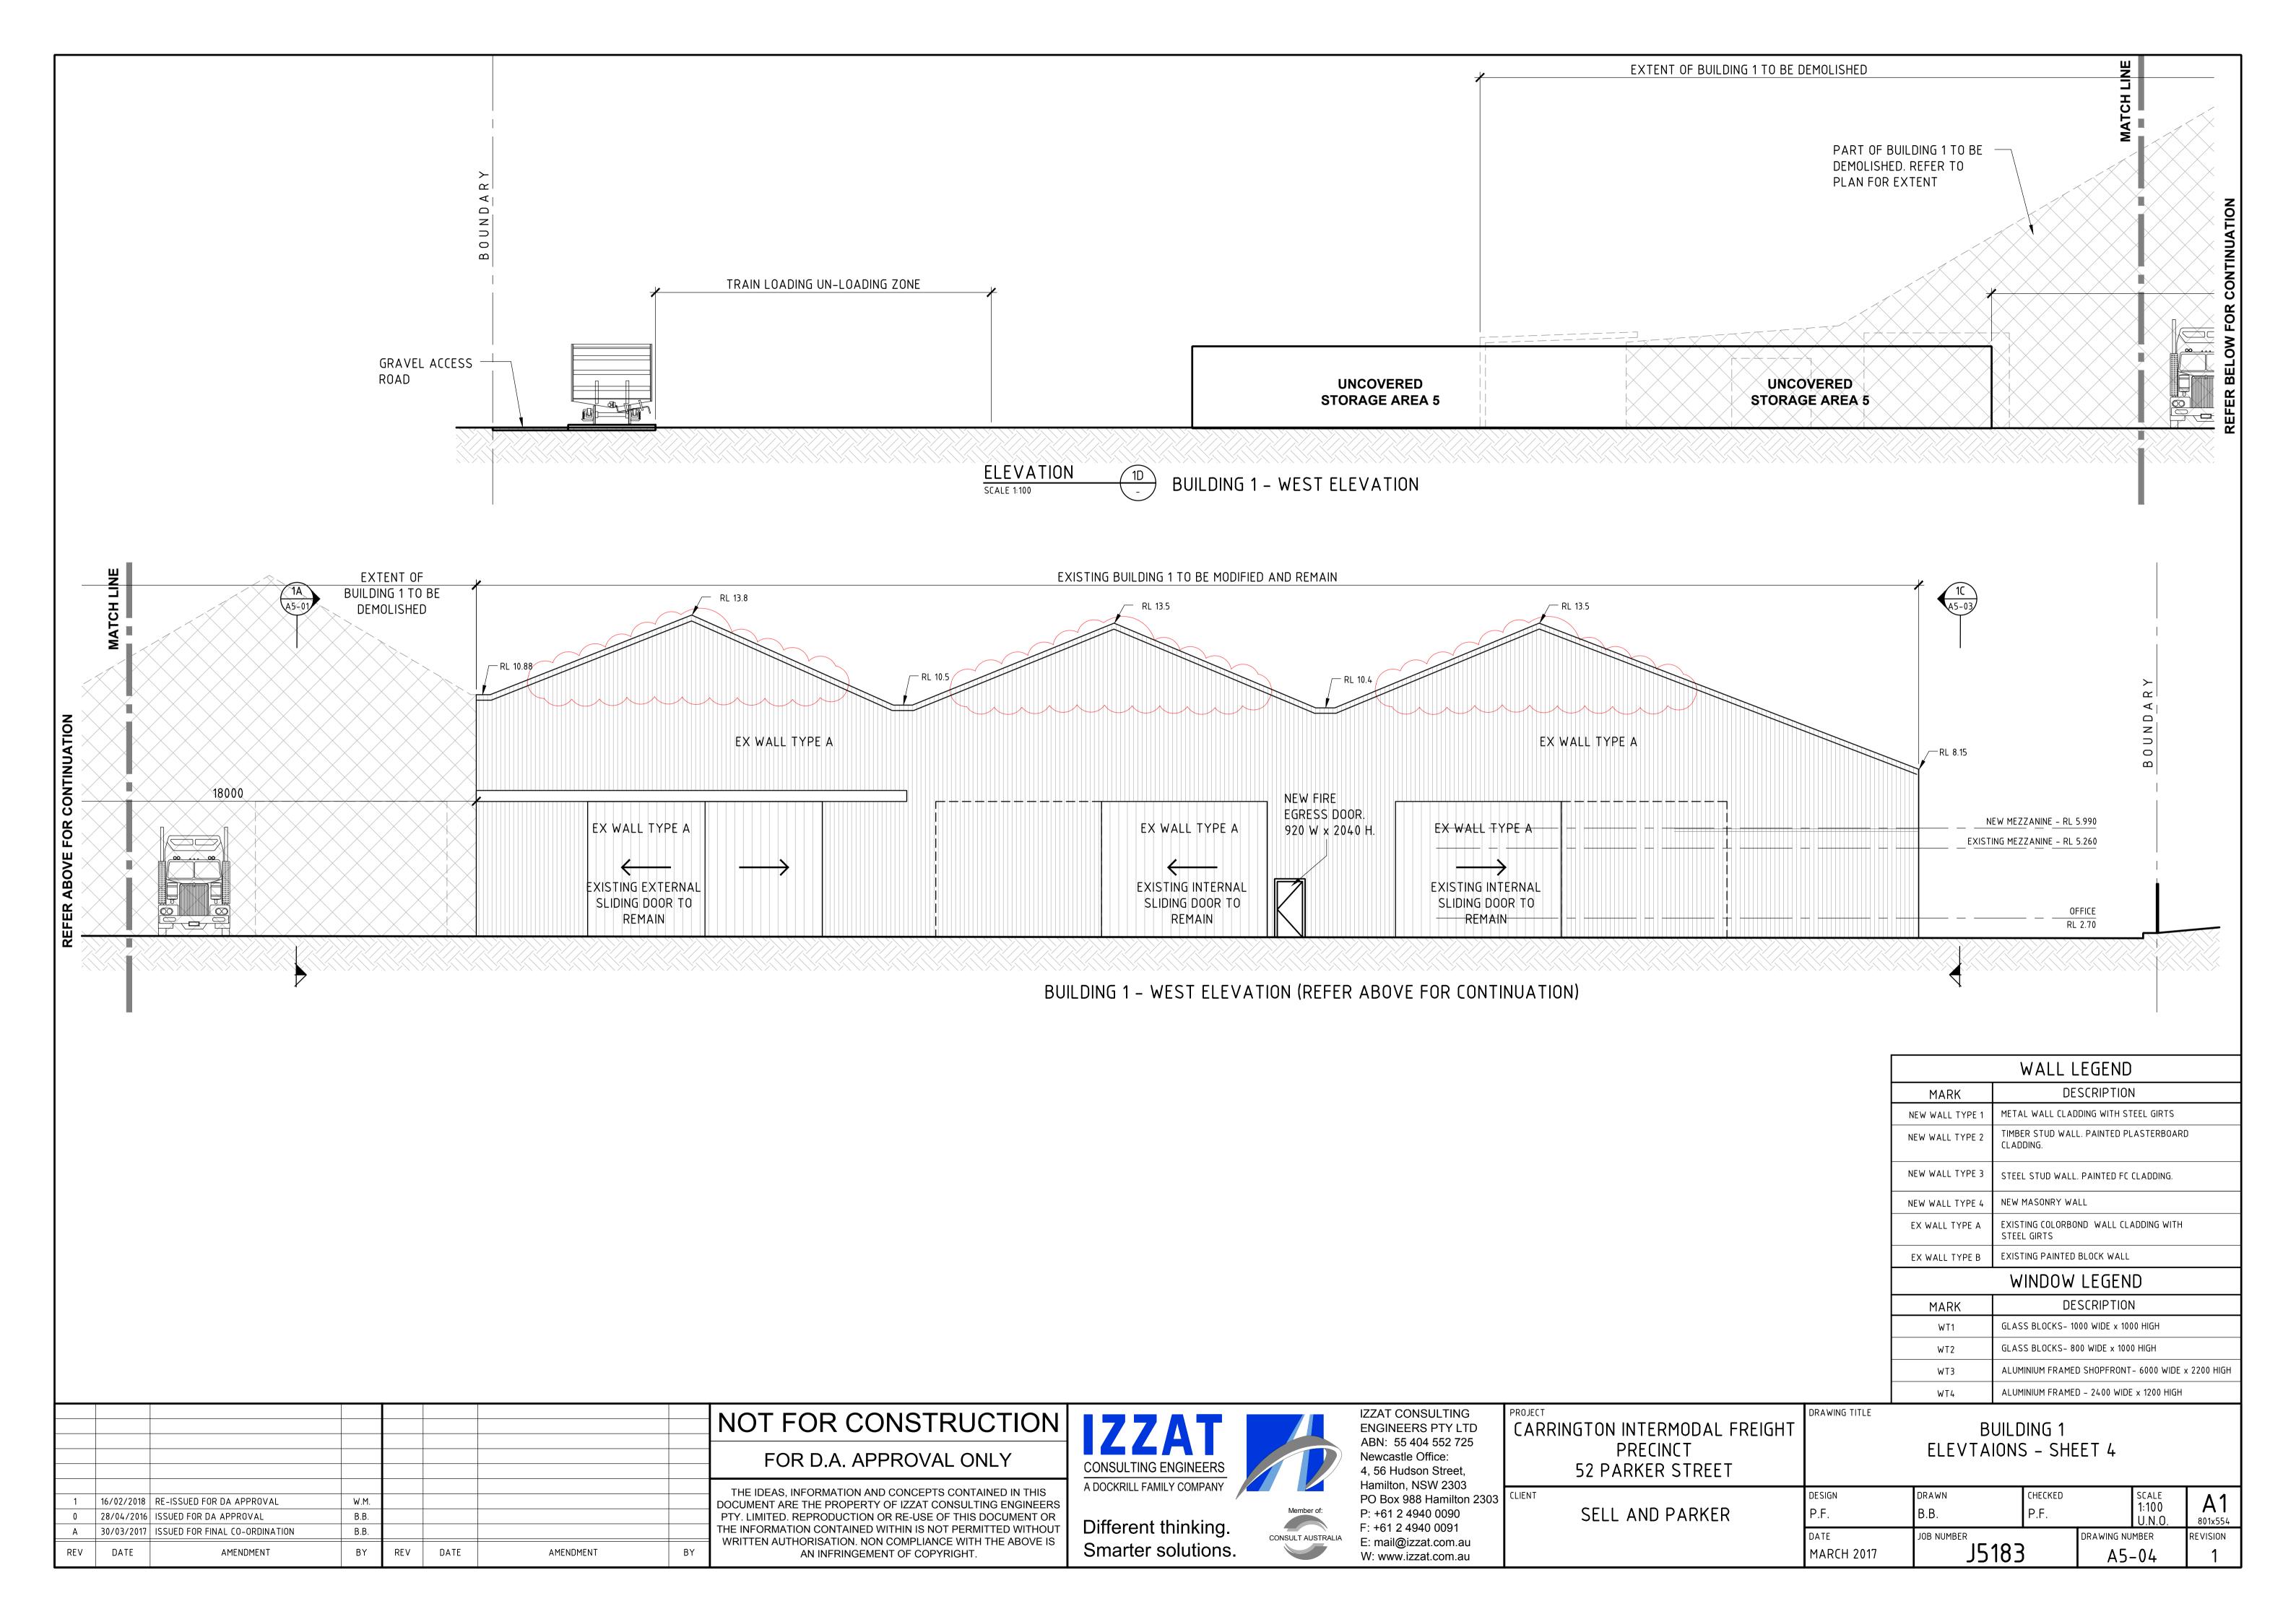

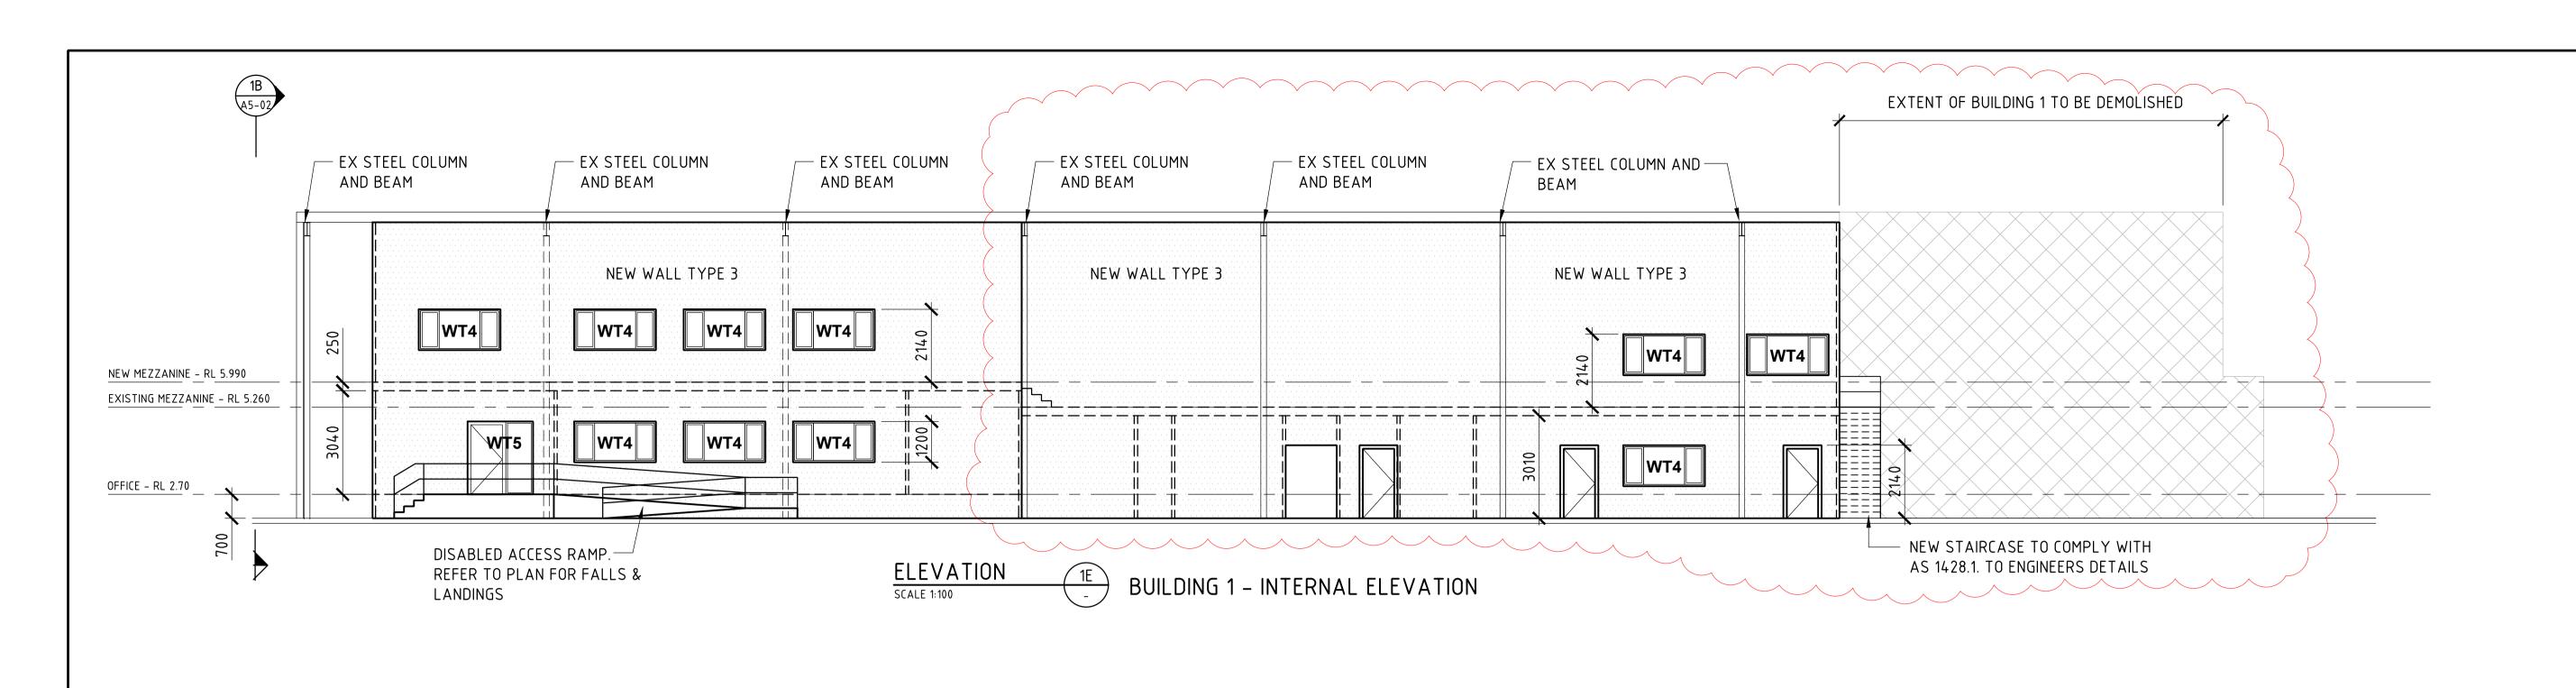

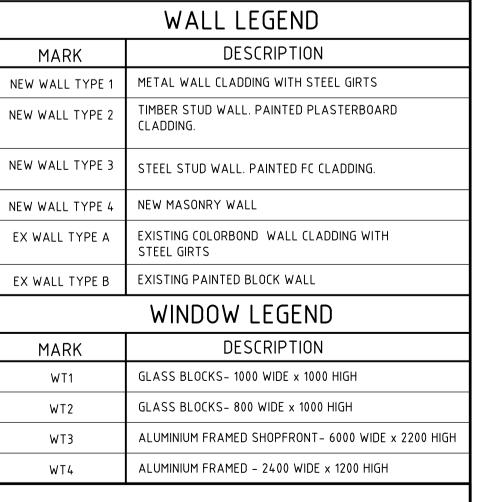

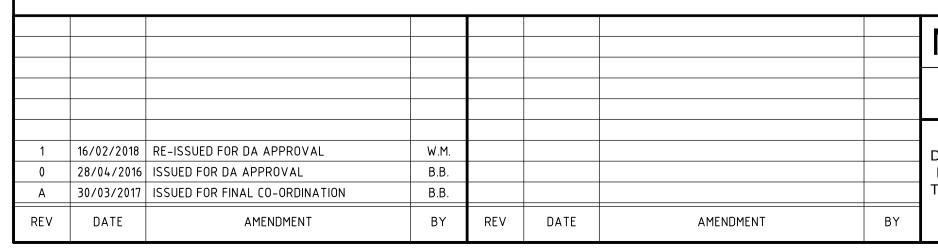

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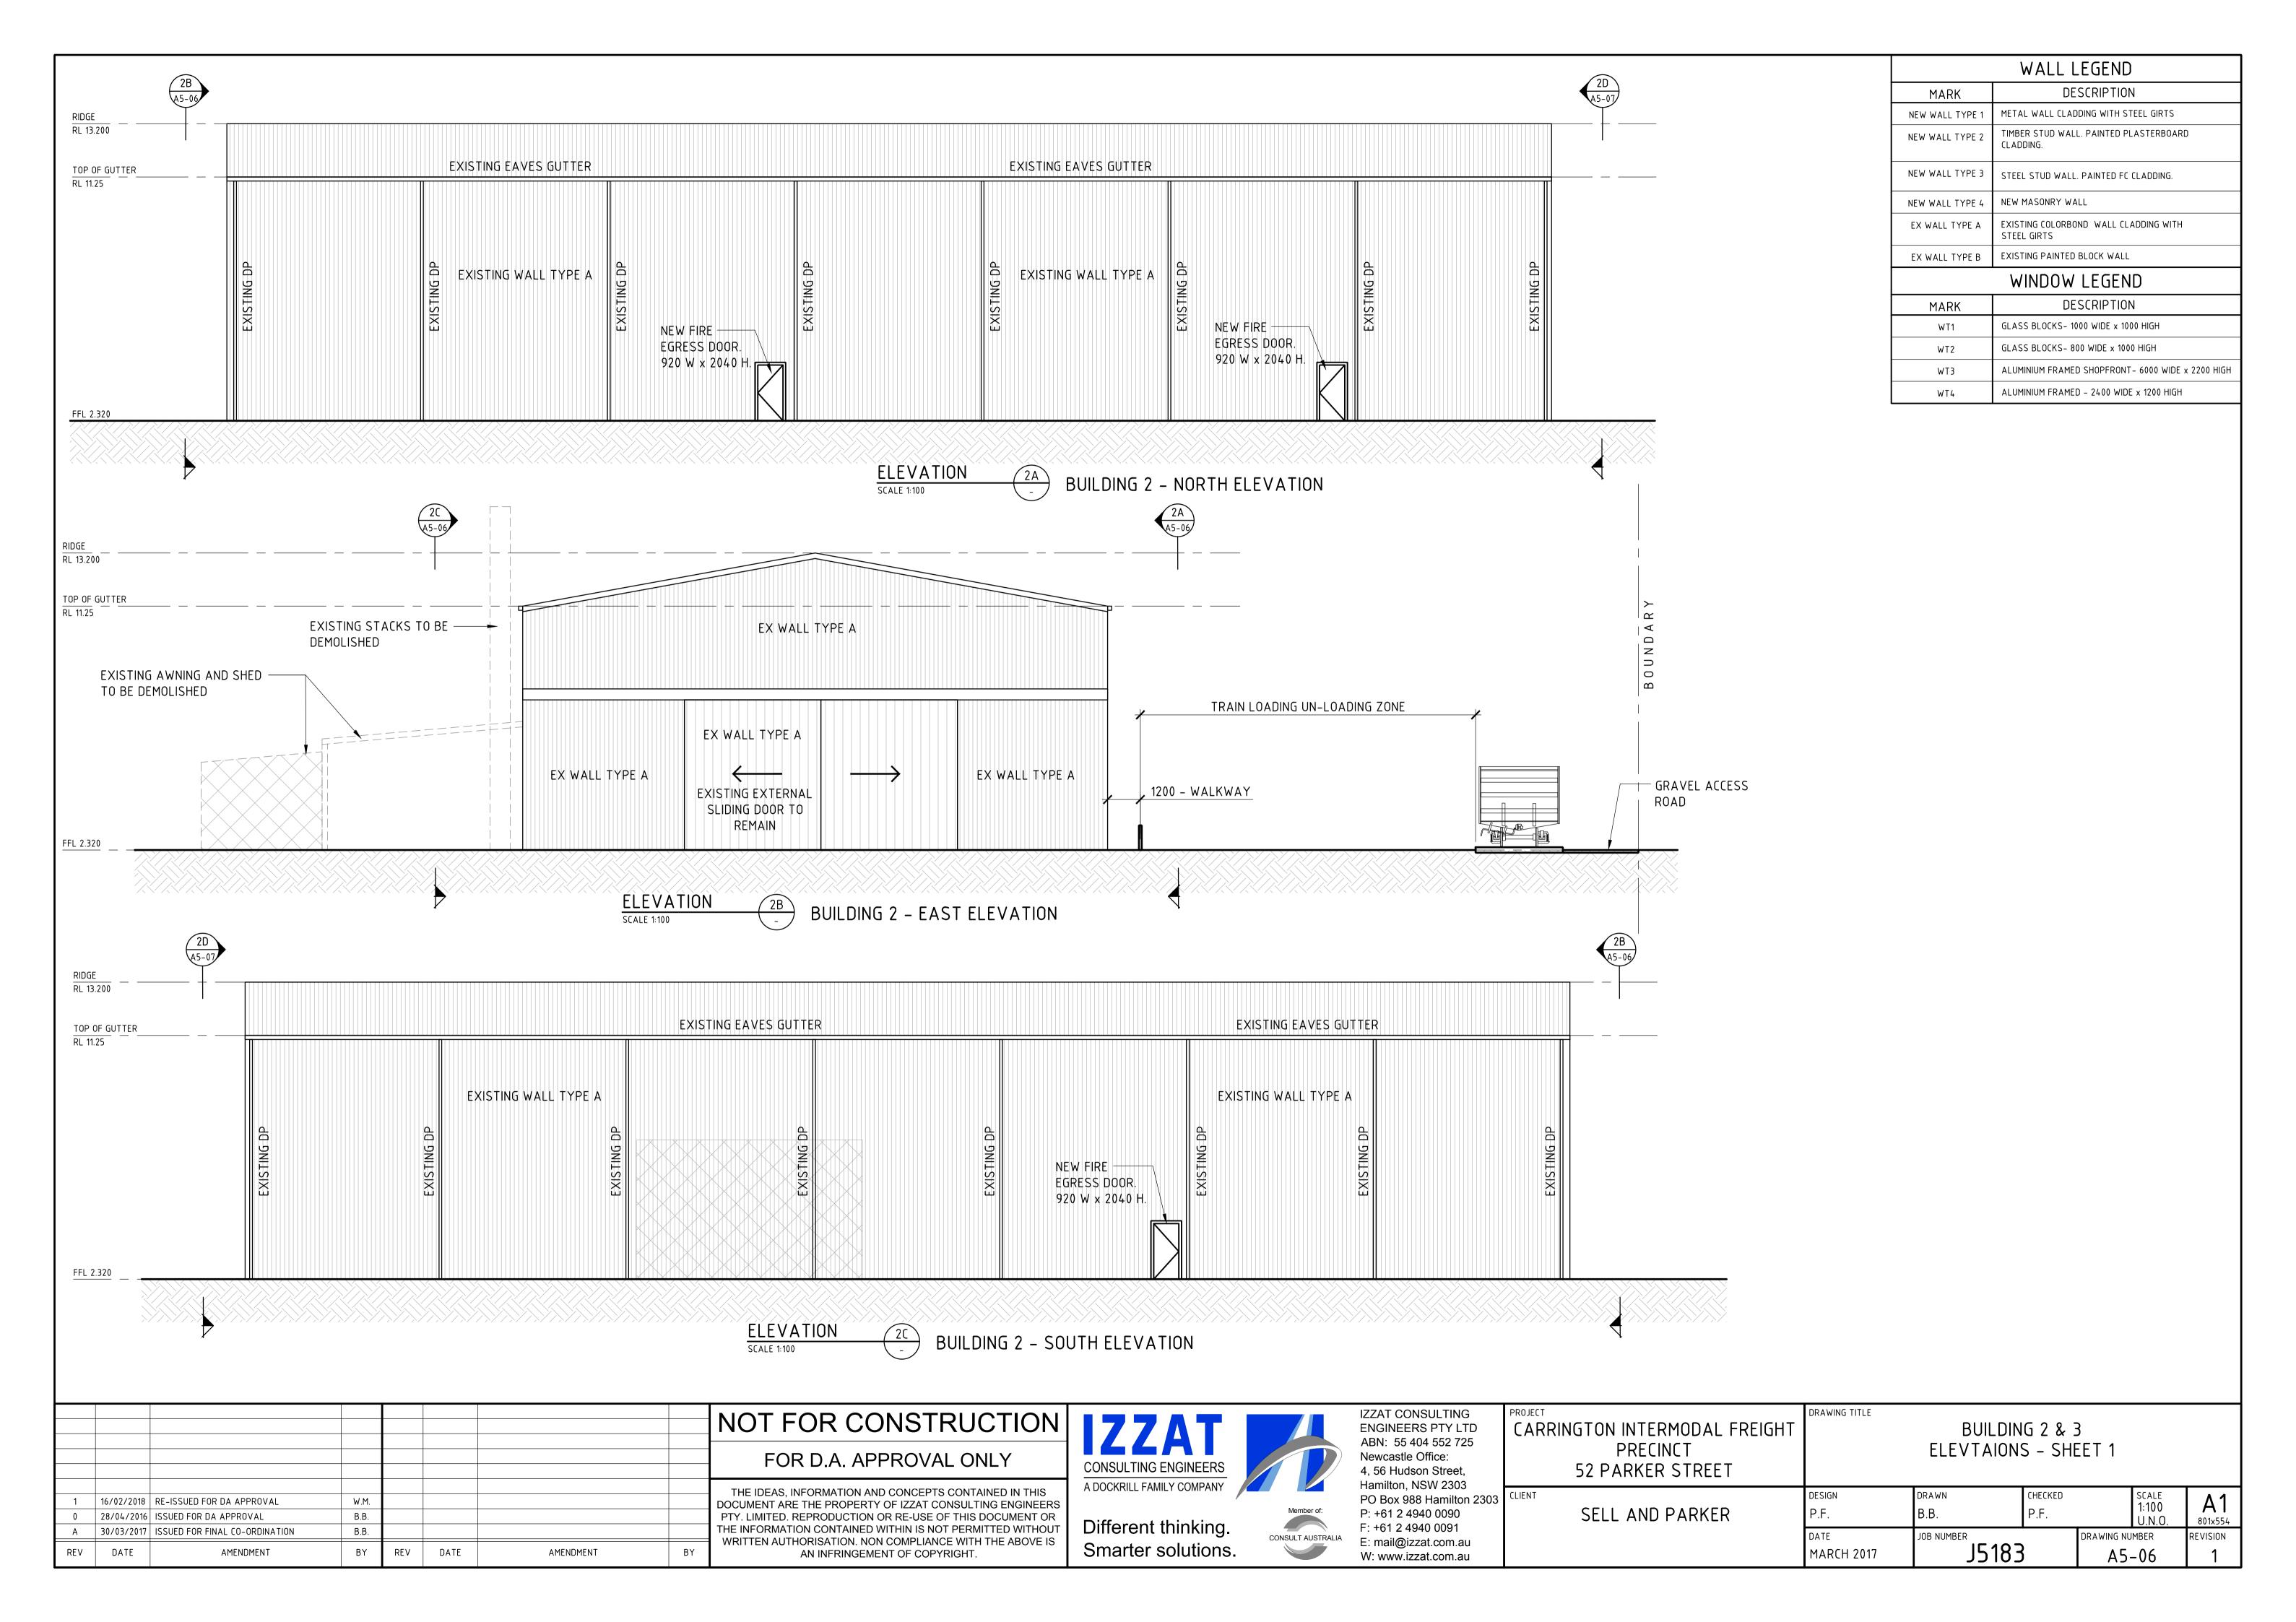
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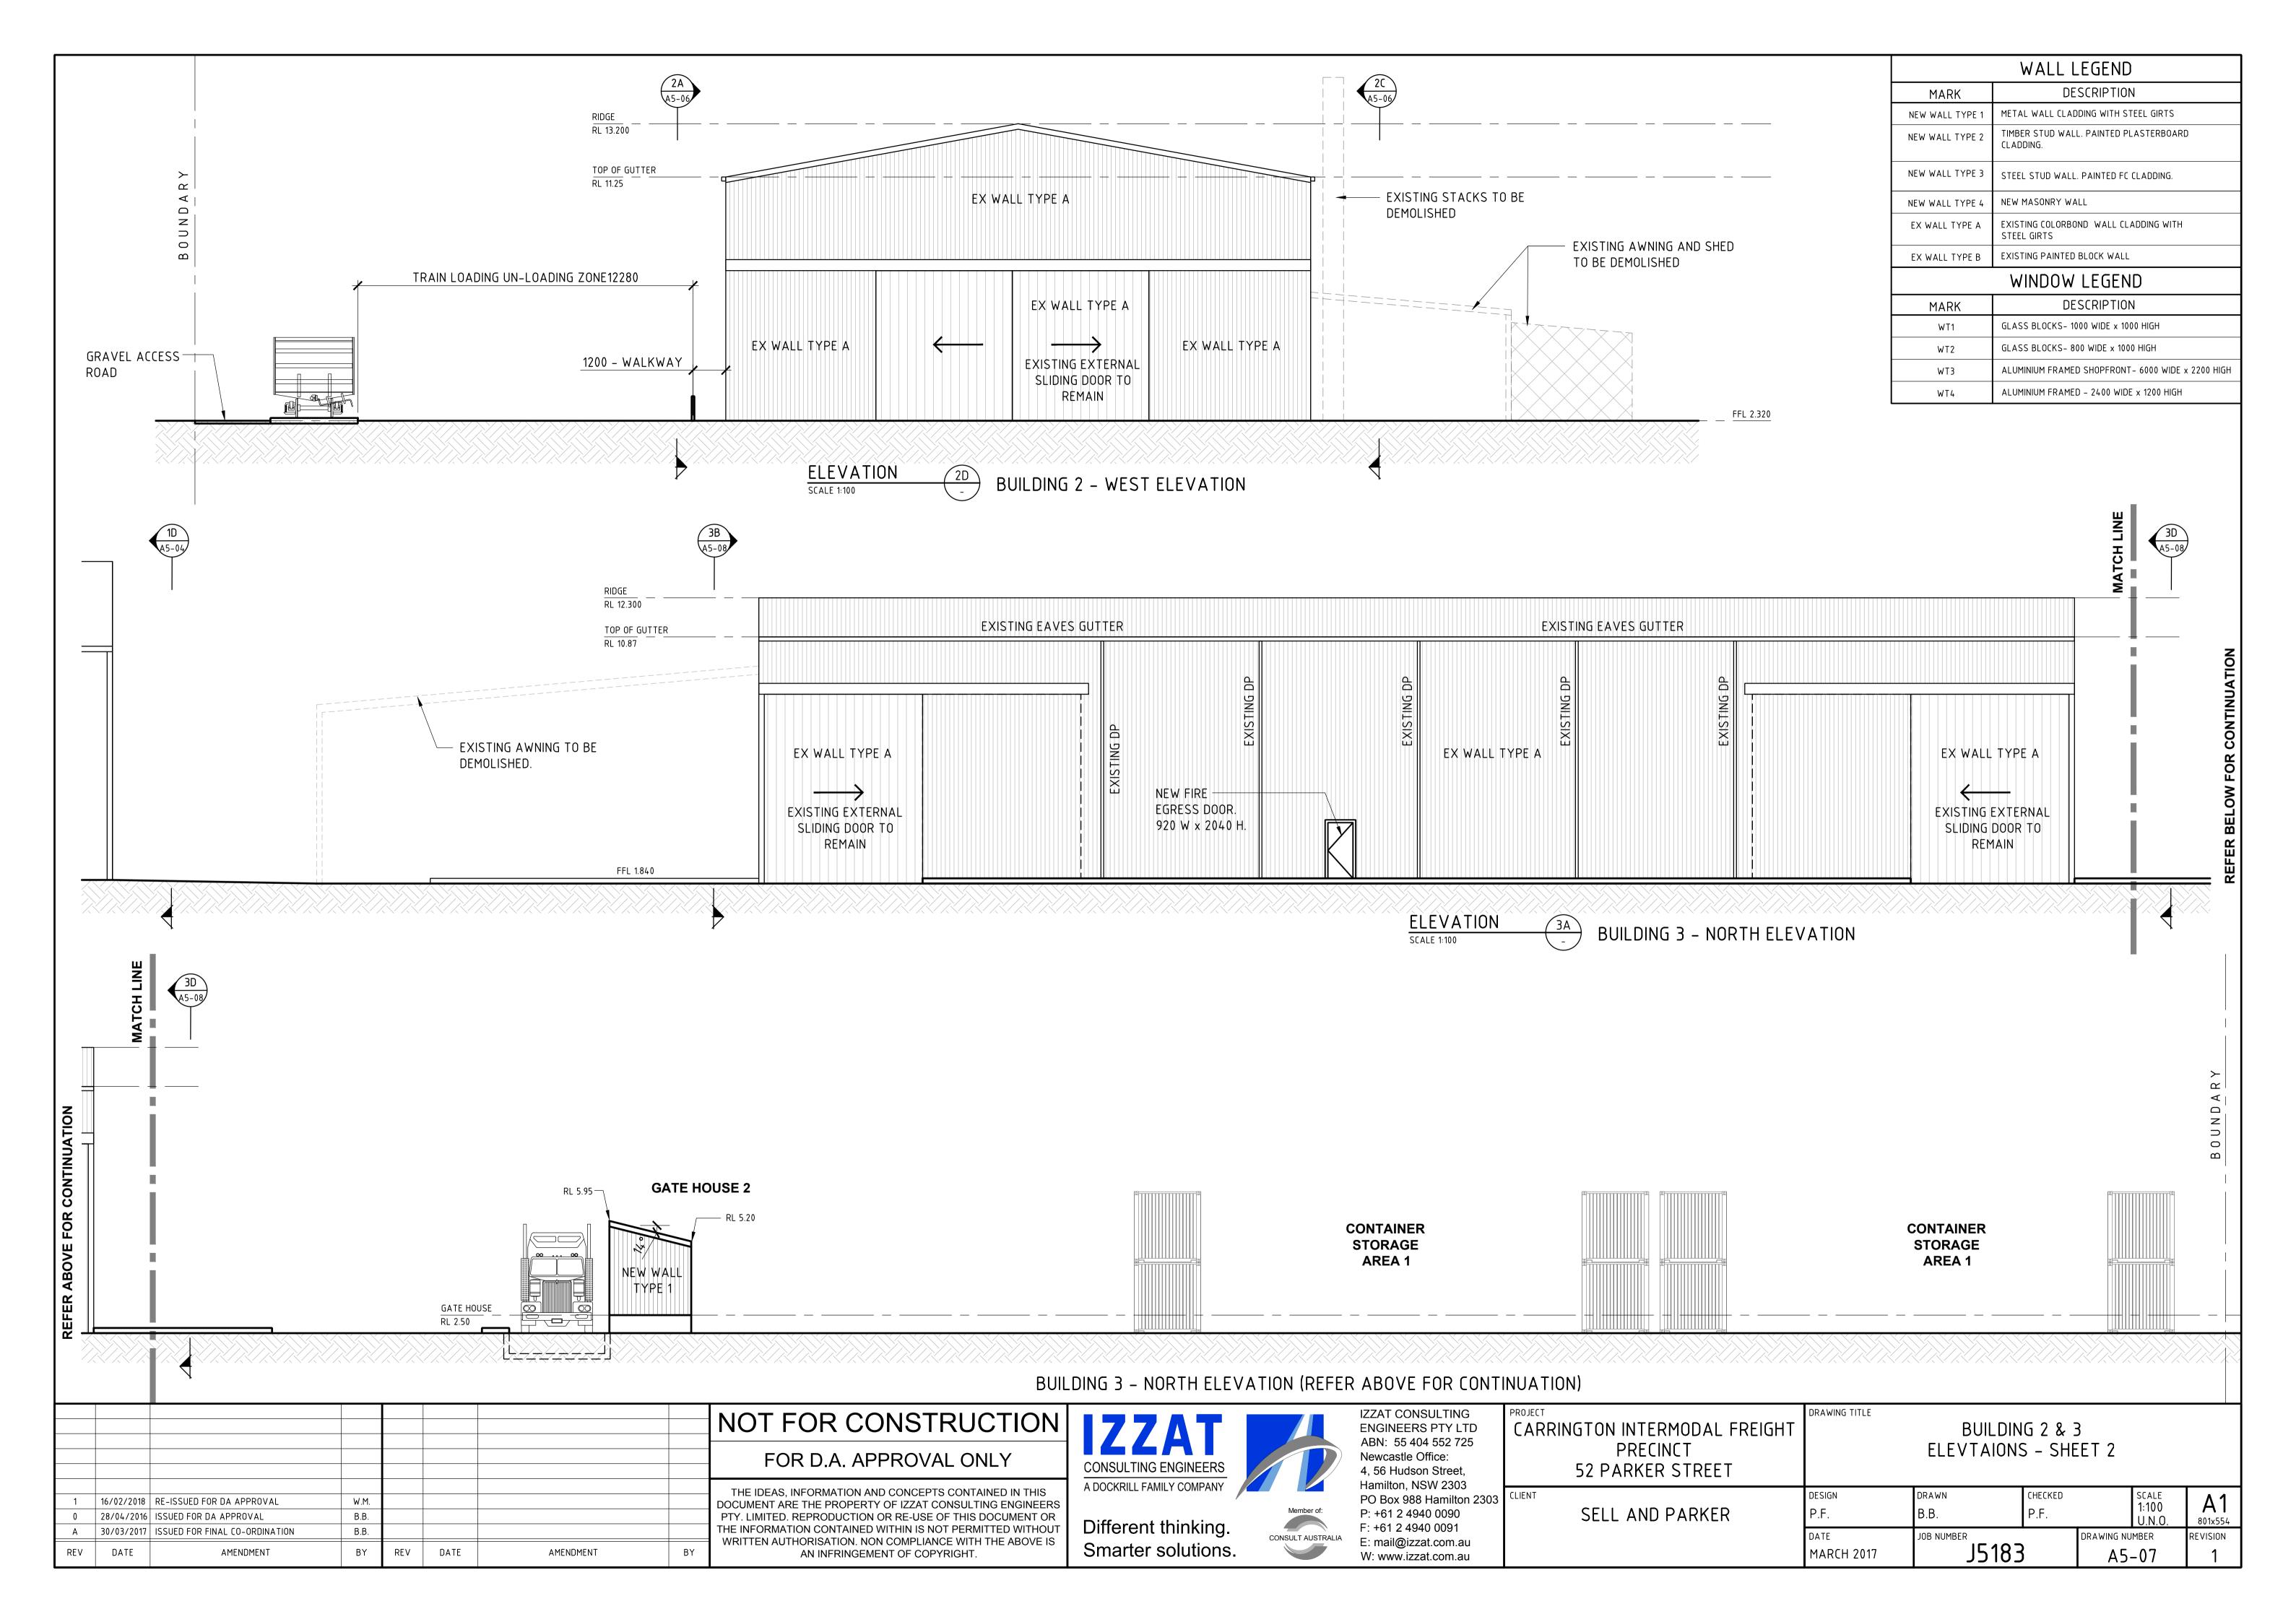
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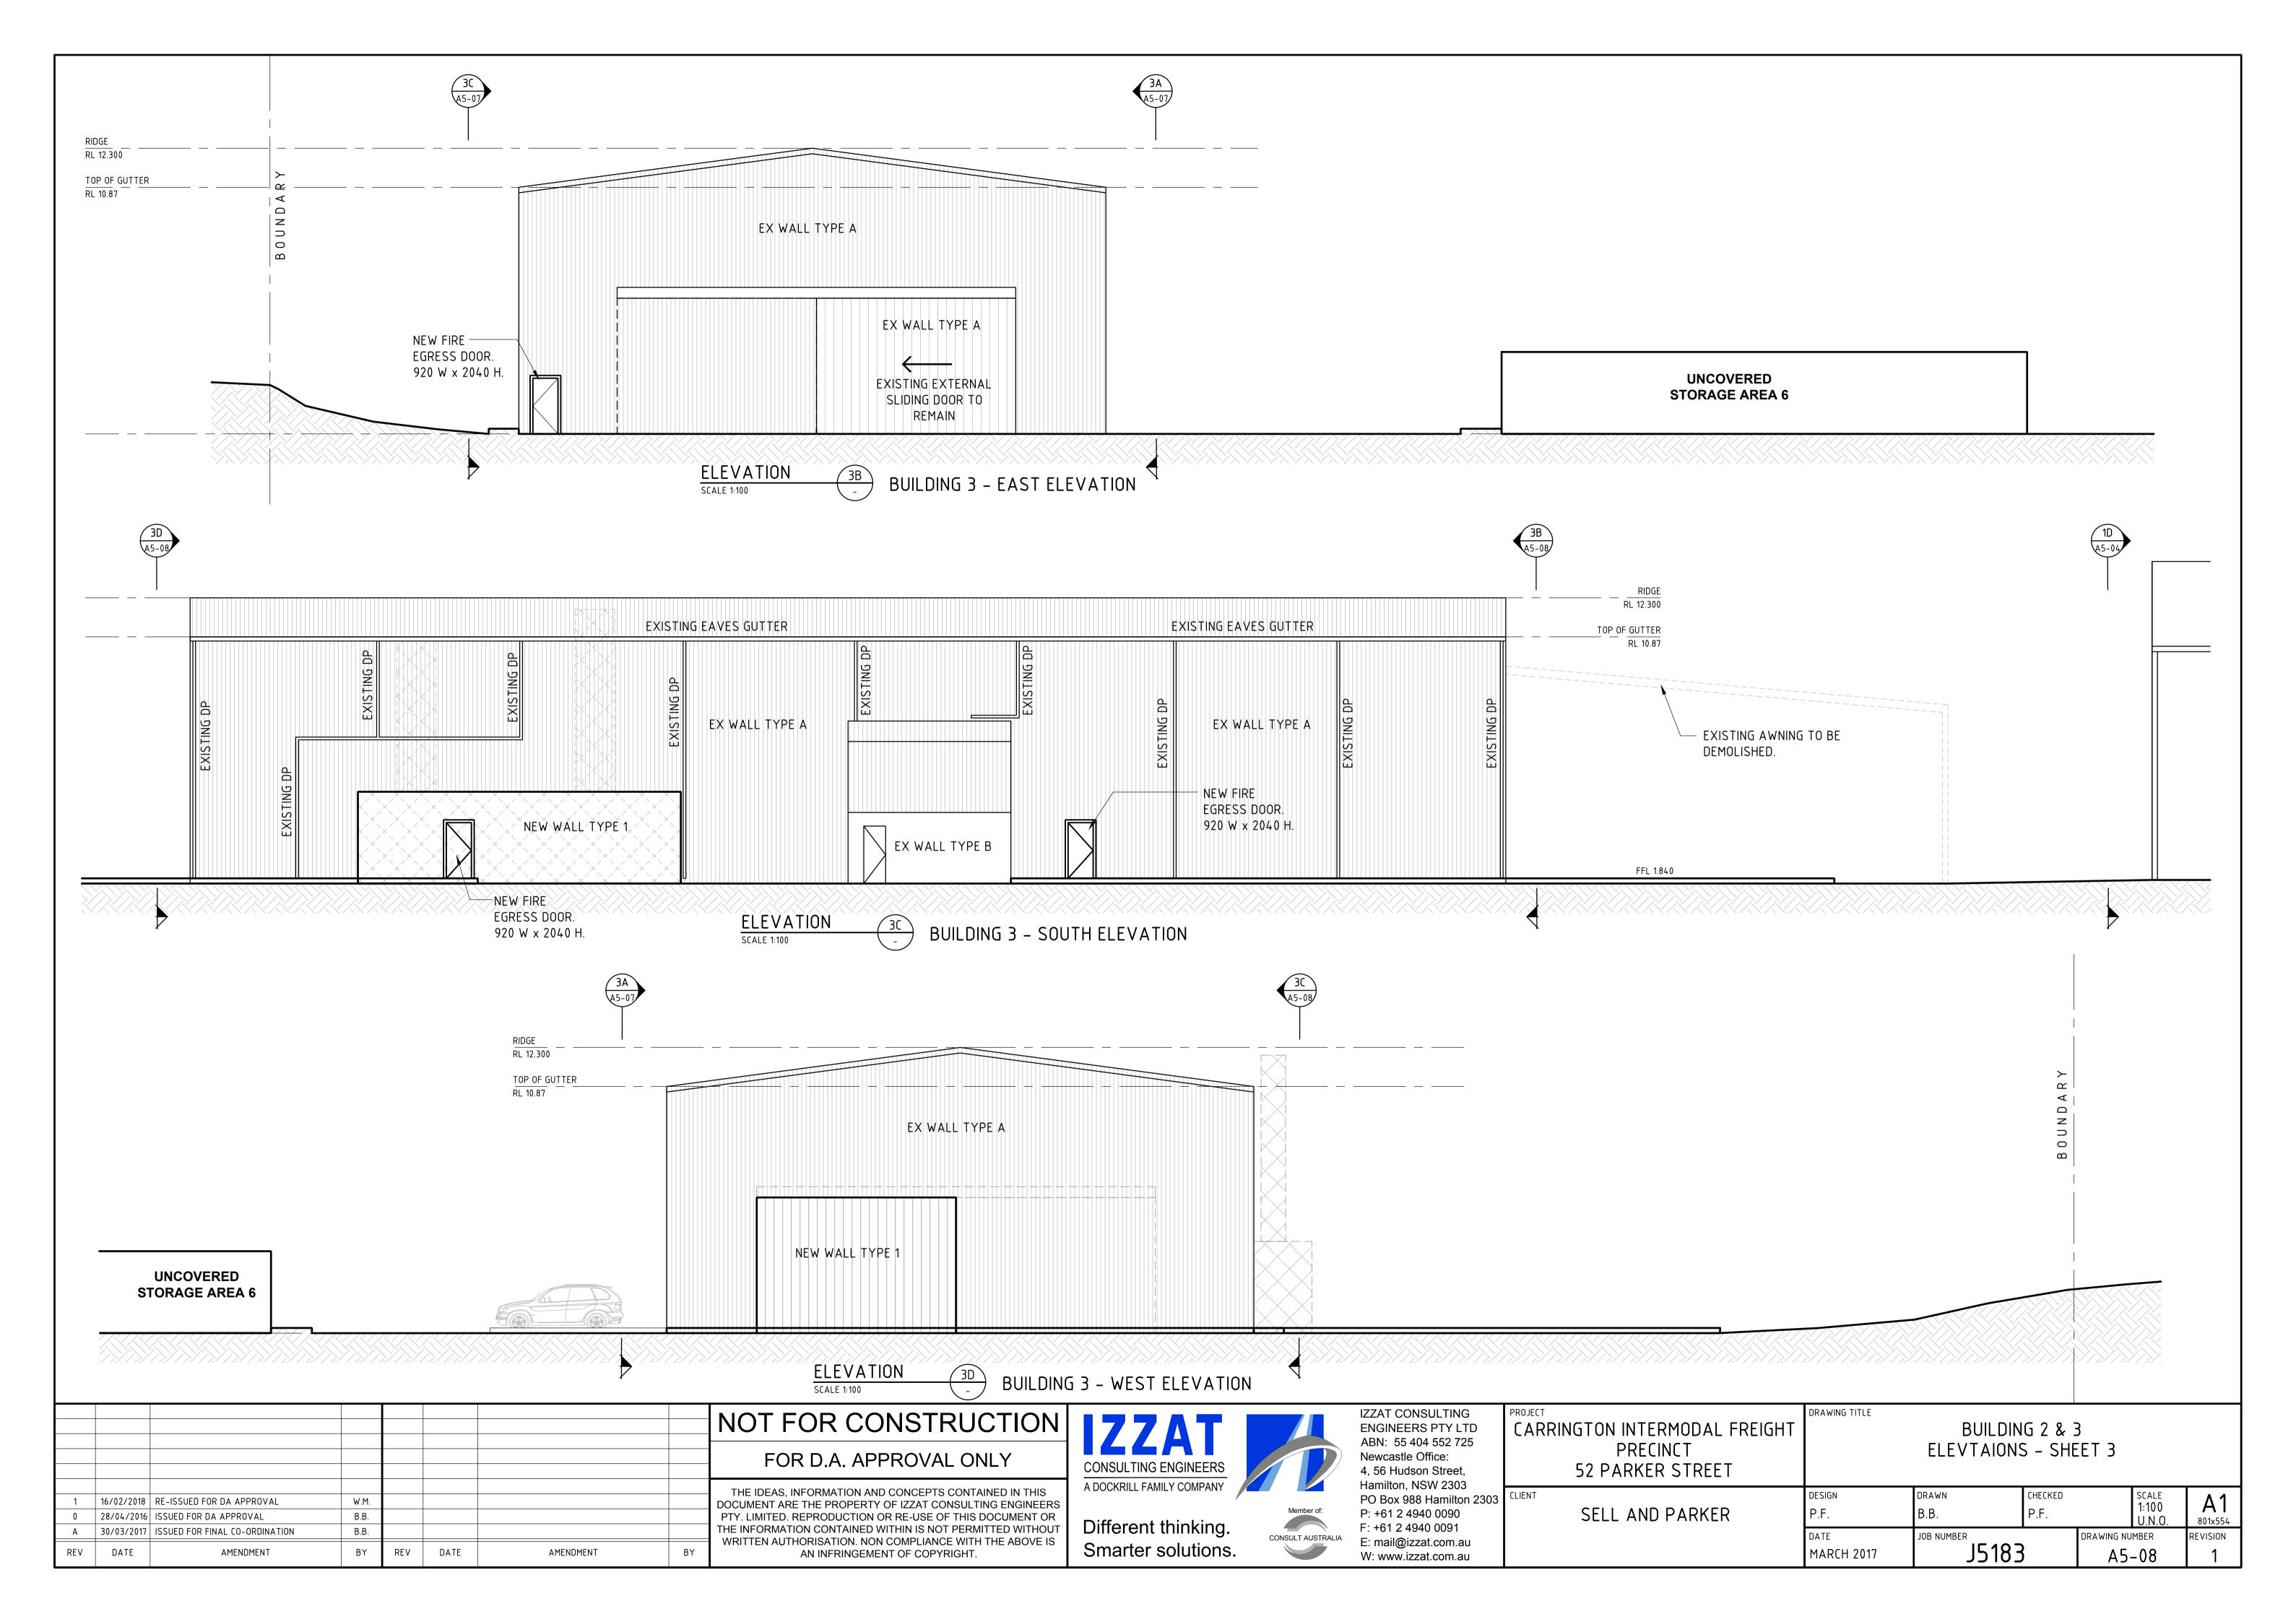
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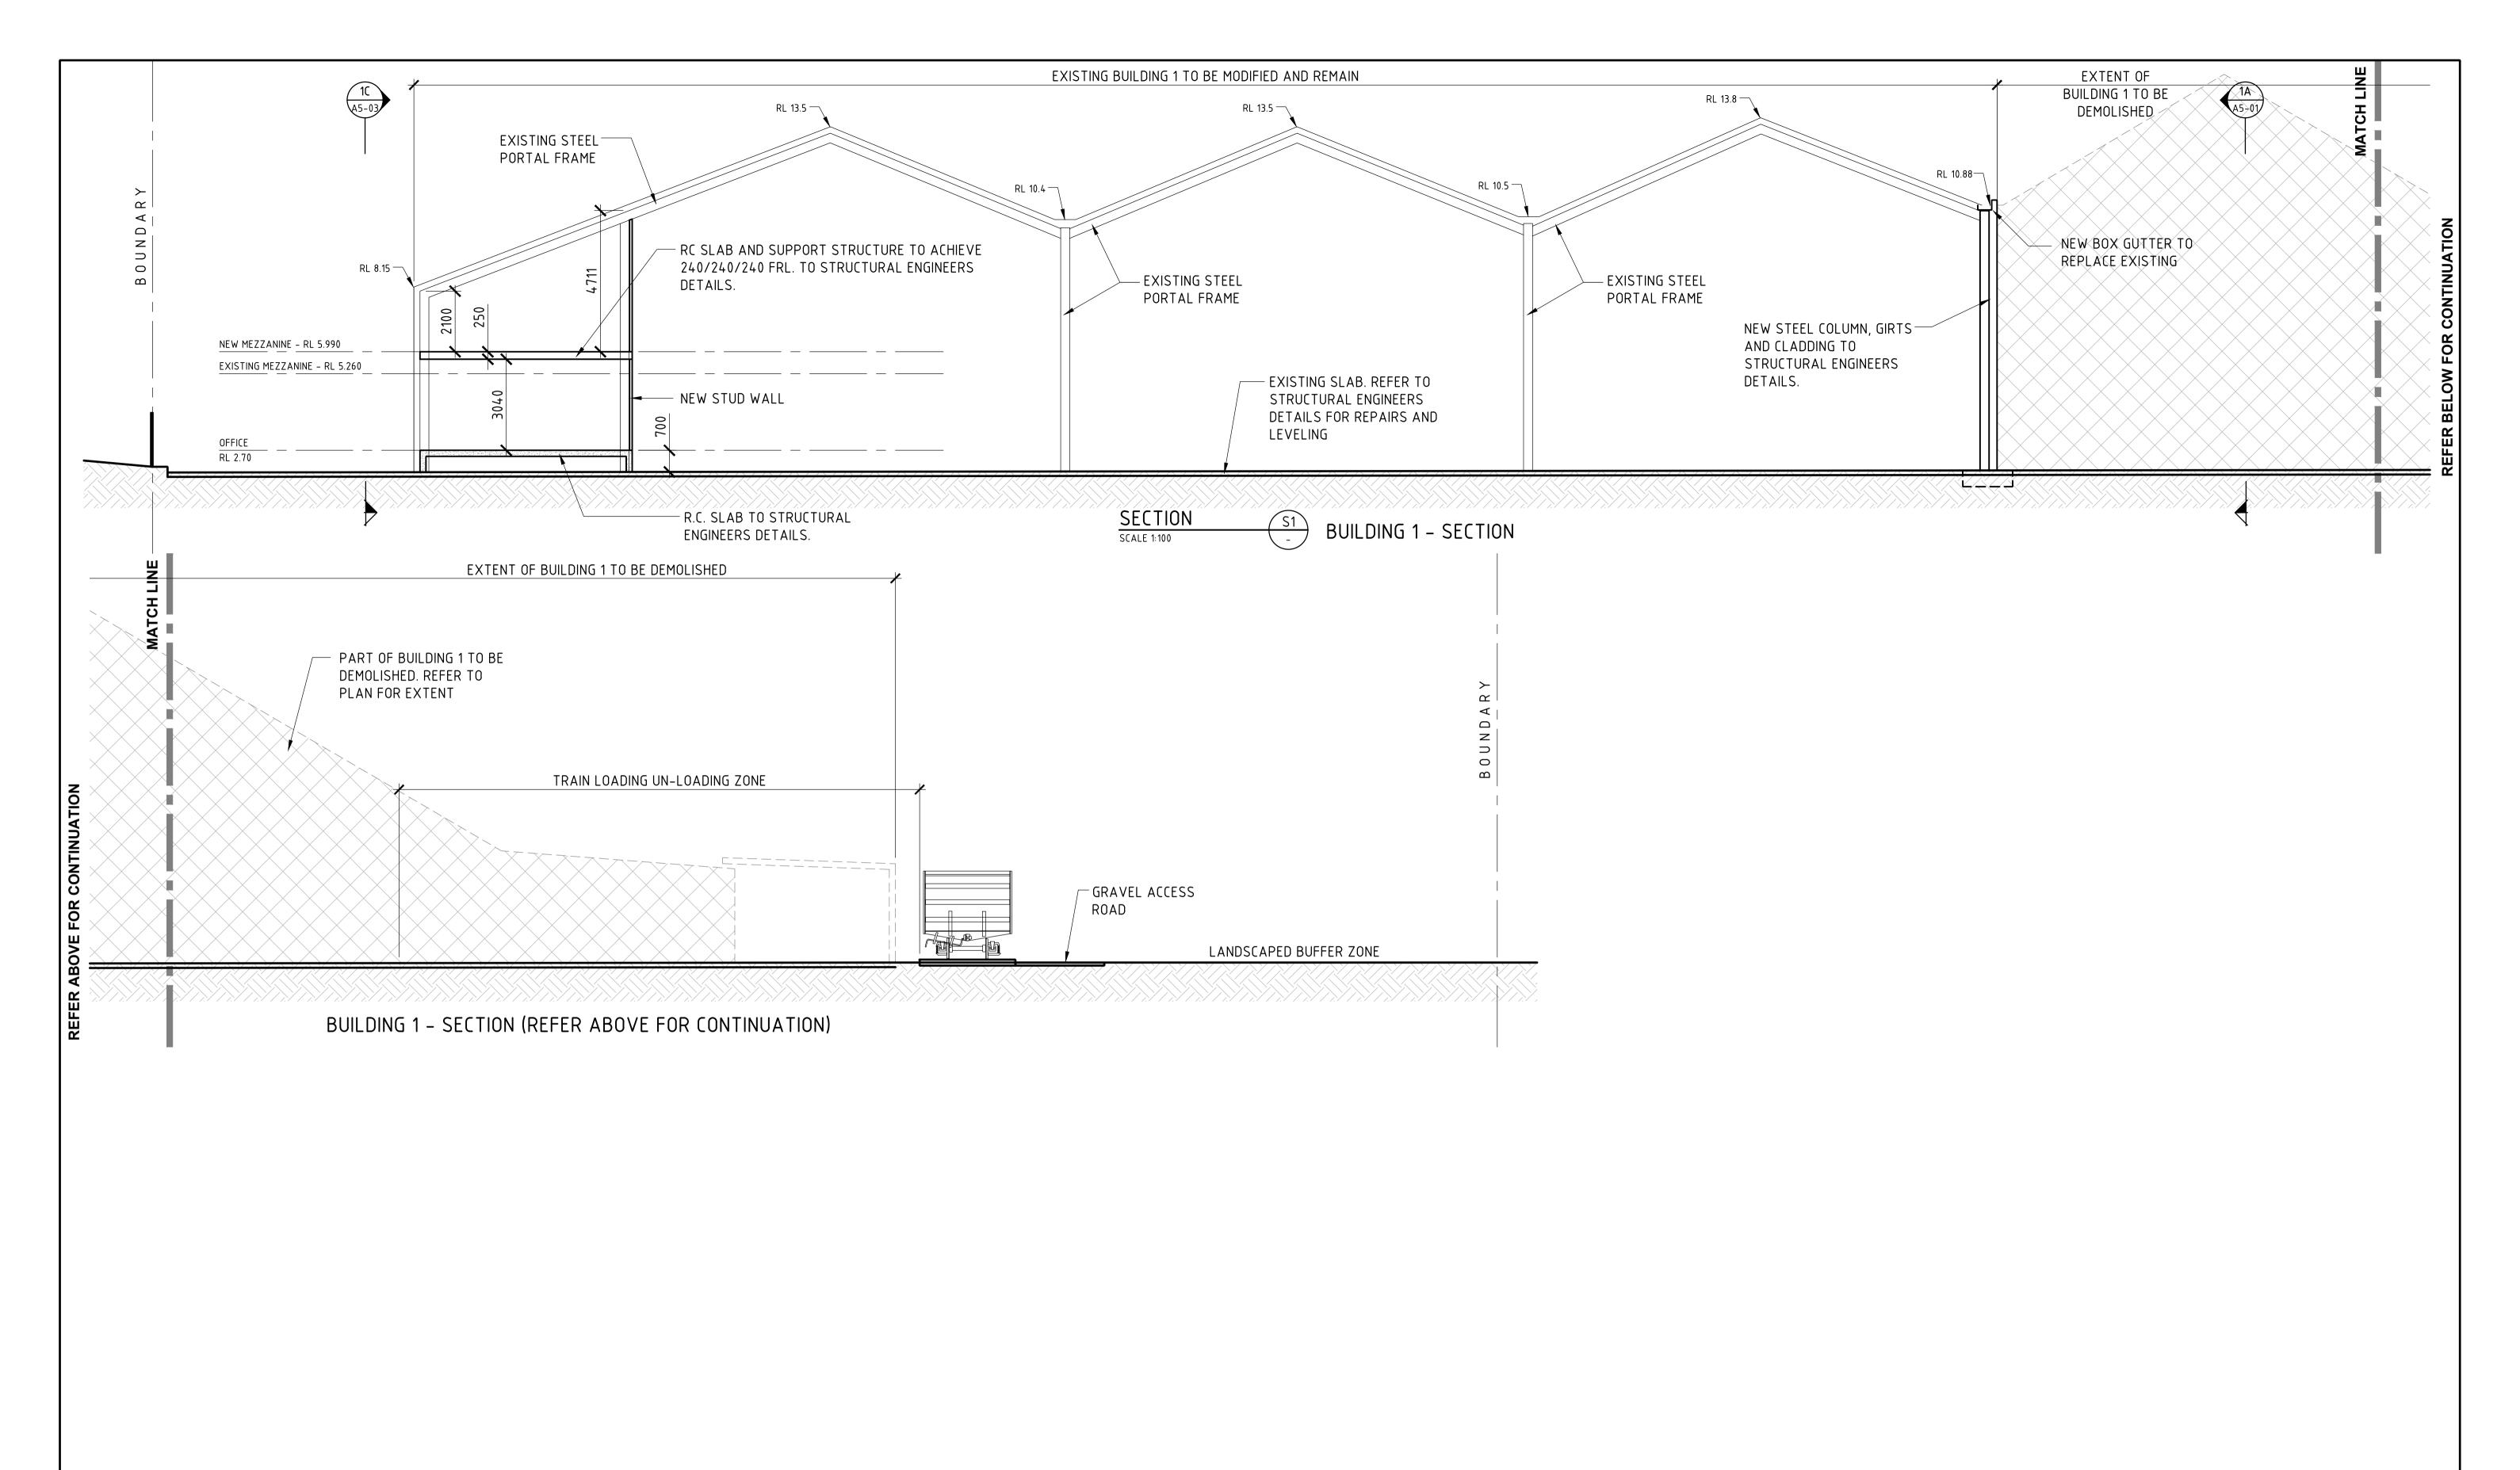
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PRECINCT
52 PARKER STREET


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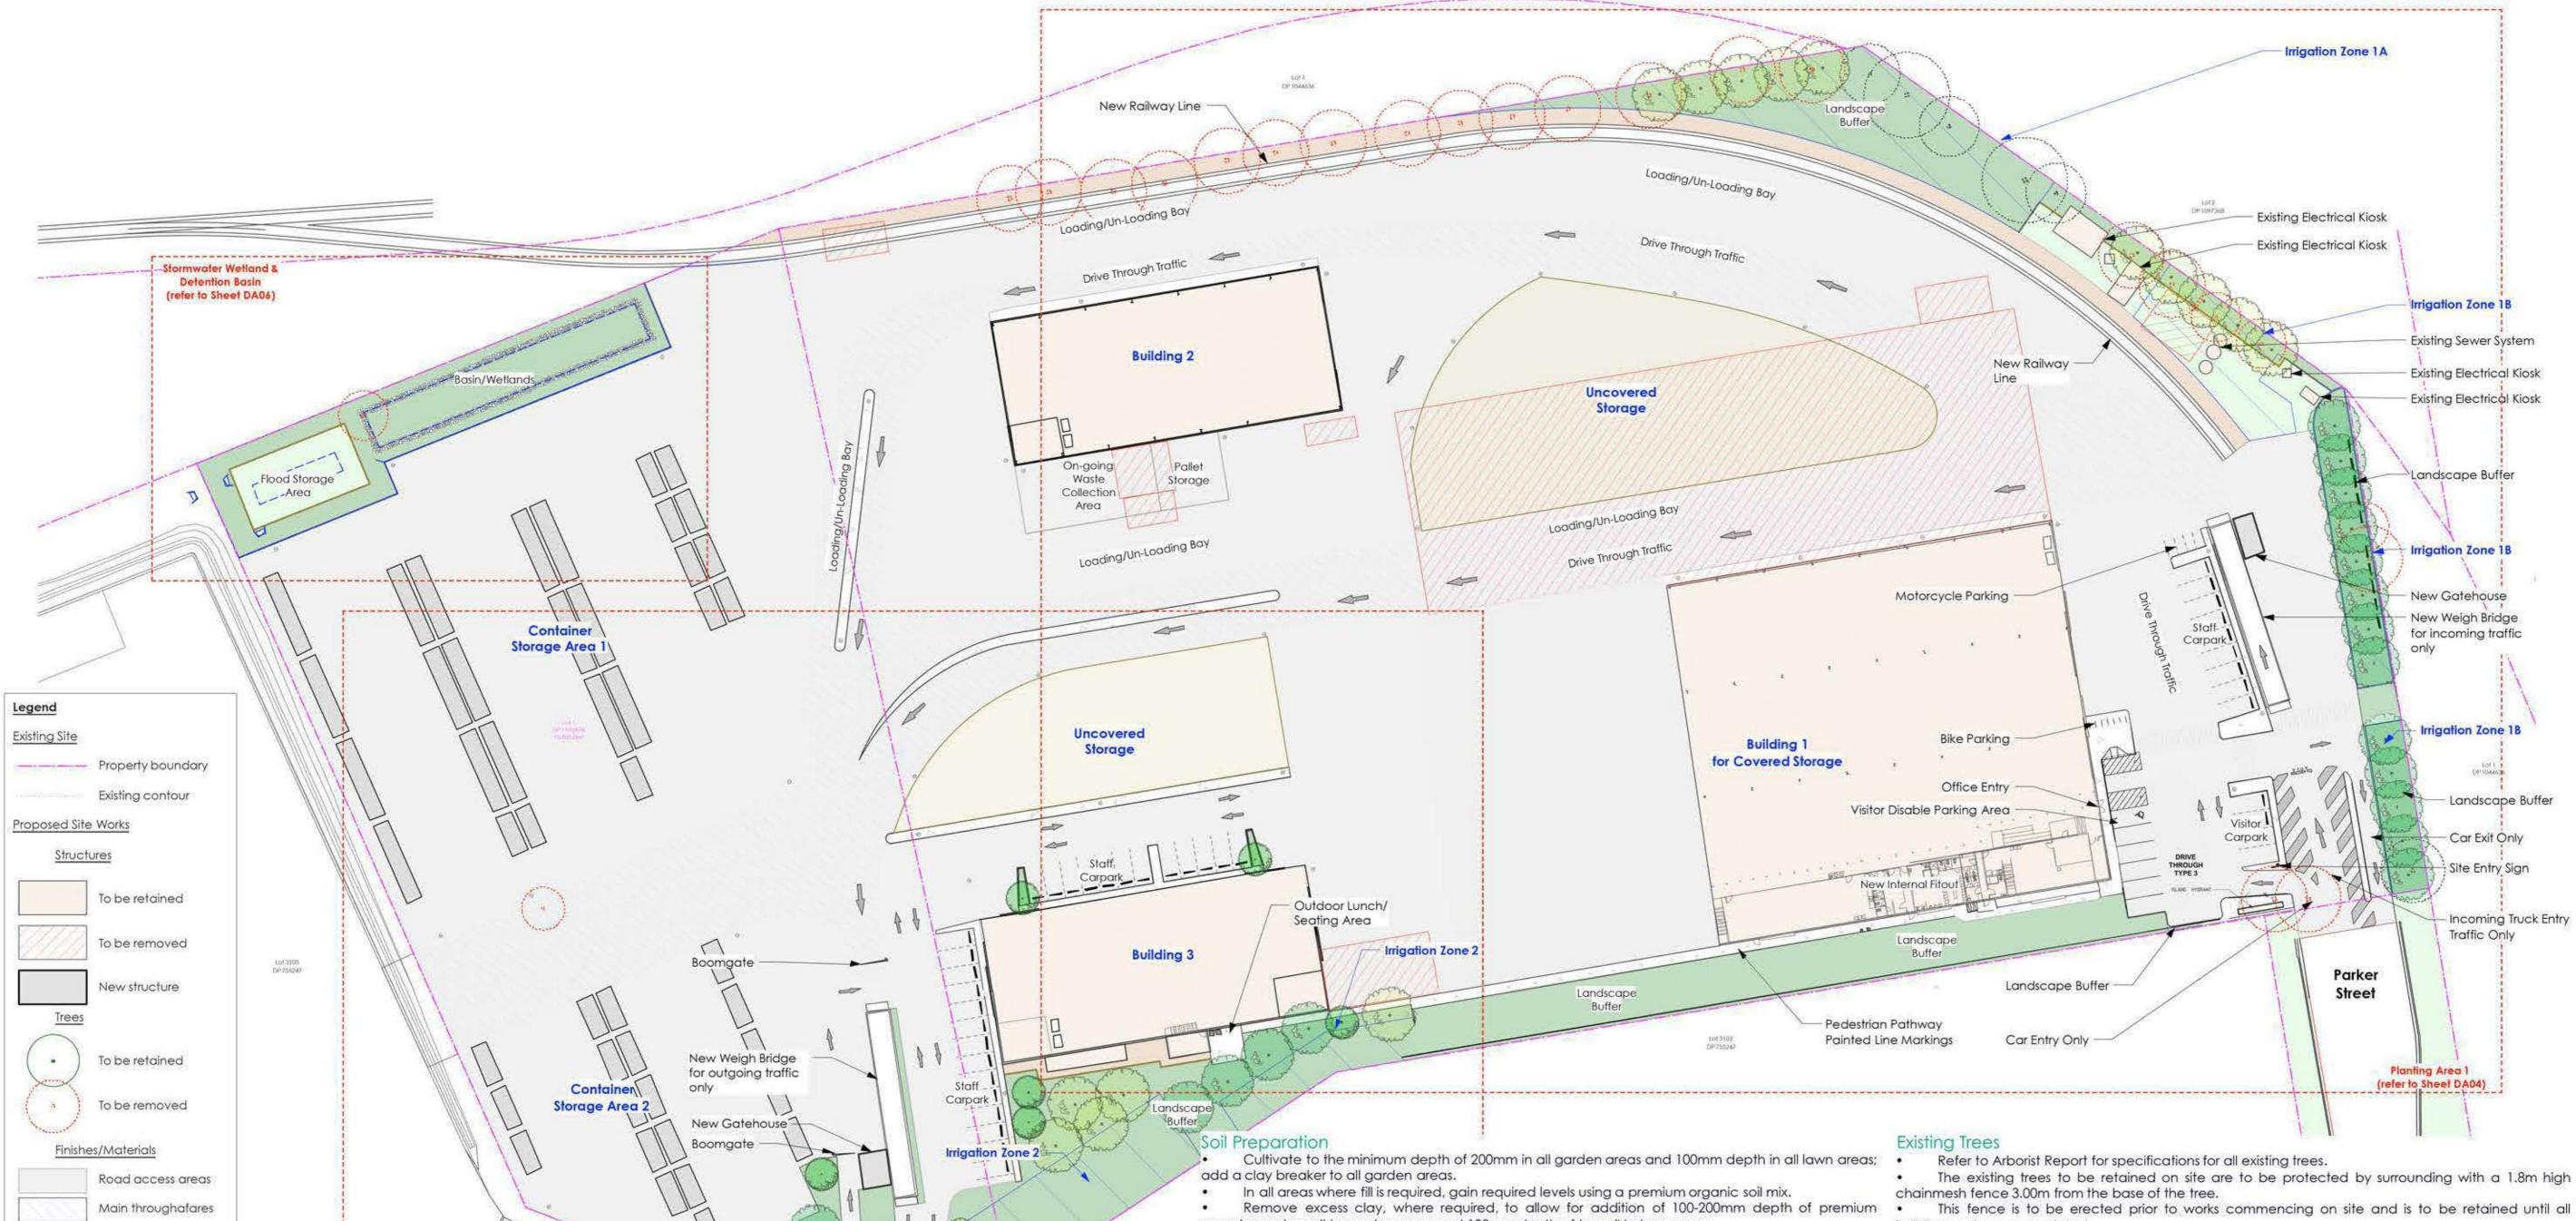
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SELL AND PARKER





organic garden soil to garden areas and 100mm depth of topsoil to lawn areas.

 Ensure all garden and lawn areas drain adequately (surface and subsurface) and are set at the recommended finished levels and have sufficient soil depths to enable lawn and plants to thrive and grow. For soil prepatation in Irrigation Zones refer to report by Whitehead & Associates 'Onsite

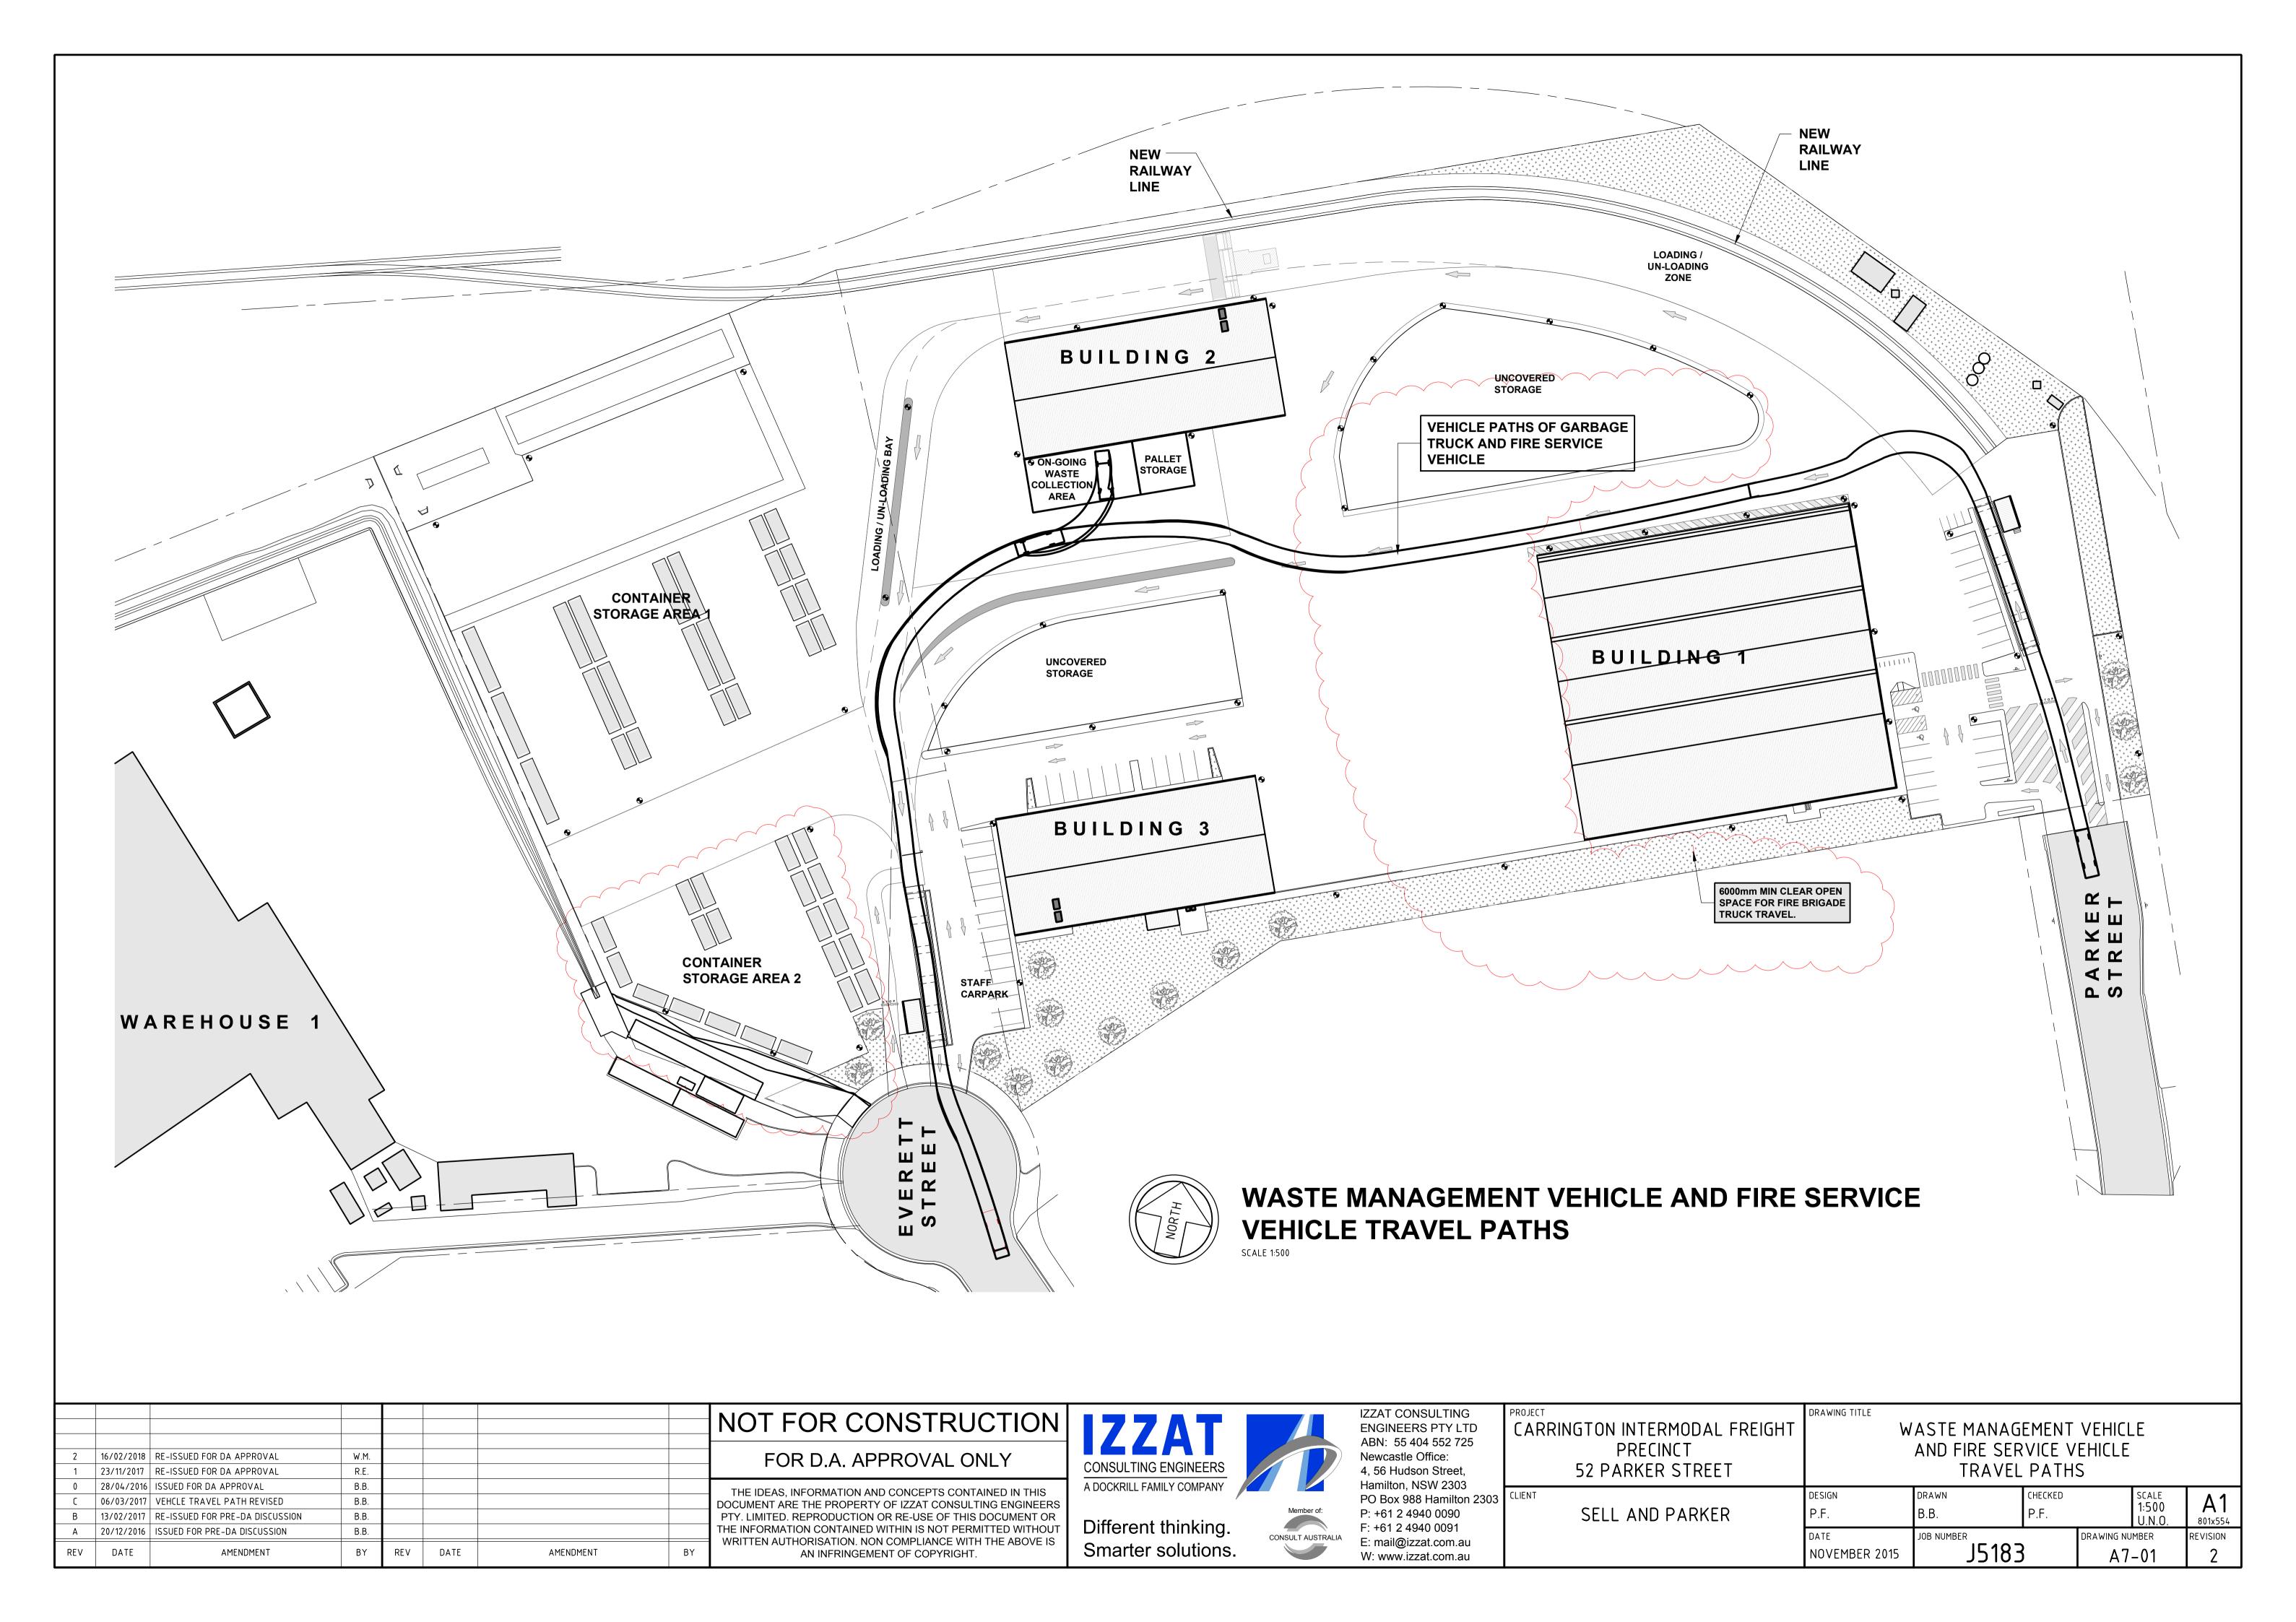Wastewater Management Plan for Proposed Freight at Carrington, NSW. Ensure soil levels are set to allow for the addition of turf and mulches to specified requirements.

## Ensure plants are installed within 24hrs of delivered.

- Set out plants as indicated on Planting Plans (Refer to Sheet DA03, DA04 & DA05). Refer to Sheet DA07 for Tree & Shrub planting details.
- Add fertilizer, followed by 100mm of garden soil shall be placed into the base of hole and lightly consolidated.
- Base of stem shall finish flush with finished soil level. Thoroughly water all plants on first planting to soak soil of plant and surrounding soil so as to allow •
- roots to adjust, do not allow drying out.

## Water regular over the first 3-4 weeks.

Turf areas to have suitable Kikuyu 'Kenda' instant turf laid over prepared subsoils.

## Gravel Areas

 Use crushed rhyolite, 100mm thick, over a compacted road base. Contain areas between gardens & gravel with timber edging.

Min. 50mm x 100mm H4 treated pine timber edge to be located between all garden/turf areas and gravel/garden areas. Secure to 50mm x 50mm x 450mm hardwood timber pegs with galvanised nails, 2 per fixing.

building works are completed.

## The enclosed area is to remain free of materials, machinery, vehicles or site sheds.

 For irrigation refer to report by Whitehead & Associates 'Onsite Wastewater Management Plan for Proposed Freight at Carrington, NSW.

## Install 75mm minimum of forest mulch over all gardens area, covering mulch around all plants

keeping away from stems and finishing flush with adjacent surfaces. Masonry Walls

Refer to civil drawings for location and specifications for all fencing structures.

Stormwater Drainage Refer to civil drawings for location and specifications for all stormwater specifications.

Refer to civil drawings for location and specifications for all masonry wall structures.

## Plants to be located to accommodate any garden drainage swales.

 It is recommended that a 26-week maintenance period be undertaken to ensure the success of planting and landscape elements. During this maintenance period, these works shall include but not limited to watering, weeding, fertilizing, pest and disease control, re-turfing, staking and tying, replanting, cultivation, pruning, aerating, renovation, top dressing and the like.

## octopus garden design

Traffic flow

Turf areas

Gravel access road

Concrete areas

Garden area

Gravel areas

Lightpoles

Timber garden edging

LANDSCAPE PLAN - SITE PLAN

CHECK ALL DIMENSIONS ON SITE PRIOR TO COMMENCING CONSTRUCTION . THIS DRAWING AND THE INFORMATION IT CONTAINS ARE COPYRIGHT AND REMAIN THE PROPERTY OF OCTOPUS GARDEN DESIGN.

MEMBER OF THE AUSTRALIAN INSTITUTE OF LANDSCAPE DESIGNERS & MANAGERS LTD.

This documentation has been designed and reviewed to comply with NCC Category 3 DCP requirements.

Gary Edwards Bachelor of Landscape Architecture (2000 Canberra) Certificate of Horticulture (1991 Orange TAFE)

Specifications

requirements to approved sites.

Gerrad Everson Cert. Landscape Architecture (2001 Melbourne) Bachelor of Science (Architecture) (1999 Newcastle)

You Dig - phone: 1100) and ensure no damage occurs.

lawn and garden areas to manufactures directions.

contract so as to suppress any weeds that may arise.

Carpark Entry Only

Verify all dimensions on site prior to commencement; locate all underground services (Dial Before


Comply with the requirements of the Council site guidelines in reference to erosion and sediment

· Spray all weeds before commencement of any site works are carried and throughout the

Excess soils and contaminated soil are to be removed within the guidelines of the council

Spray weeds and unwanted planted material with approved herbicide weed killer to all proposed

**Everett Street** 

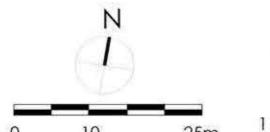

Carpark Exit Only

Traffic Only

Truck Exit Outgoing

DATE FEB 2018 SCALE 1:500@A1

PAGE 2 OF 7 ISSUE

SITE PLAN

52 Parker Street, CARRINGTON, NSW 2294



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